

# BASE BUILDING IMPROVEMENTS

## 476 Massachusetts Avenue, Arlington MA 02474


### Permit Set

### 12-16-2019

CLIENT  
Marco Realty  
89 Winchester St  
Brookline, MA 02446

ARCHITECT  
Colin Smith Architecture, Inc.  
1666 Massachusetts Ave.  
Lexington, MA 02420  
781.274.0955


#### Mounting Heights

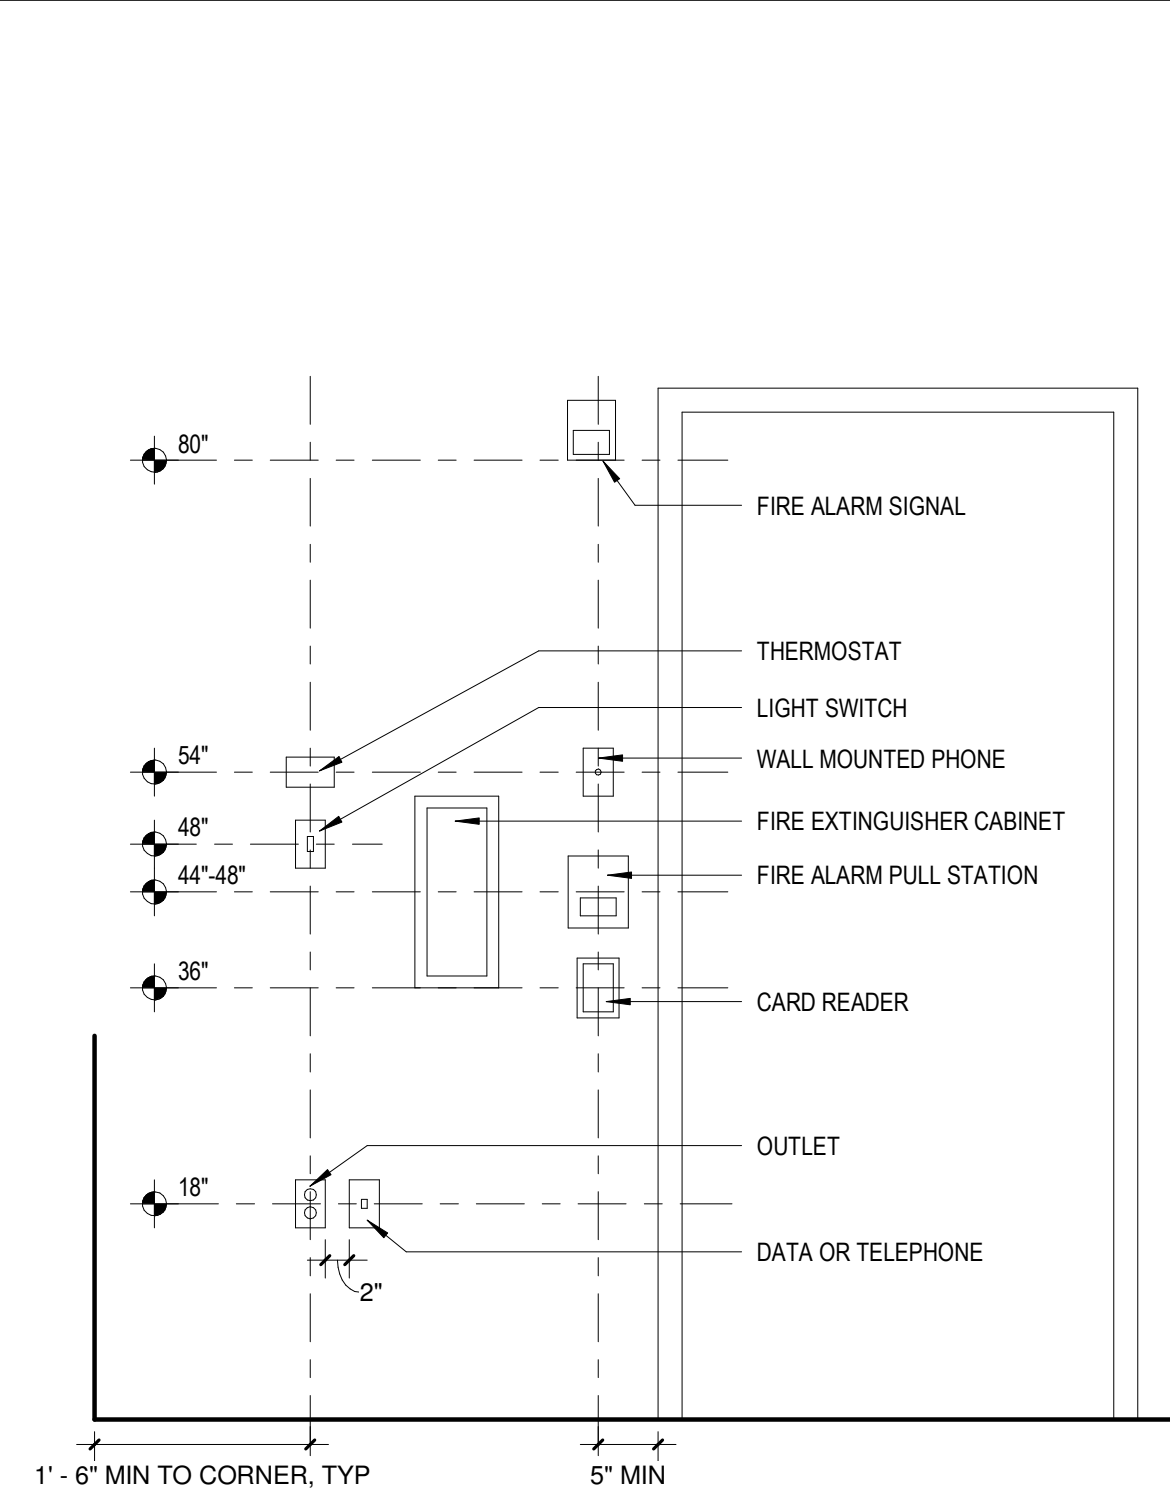


#### Abbreviations

C.L.	CENTERLINE	E.V.	EXISTING VENT PIPE	PTD	PAINTED
A/C	AIR CONDITIONING	F.D.	FLOOR DRAIN	QTY	QUANTITY
ADJ.	ADJUSTABLE OR ADJACENT	F.E.	FIRE EXTINGUISHER	R	RISER
A.E.D.	AUTOMATED EXTERNAL DEFIBRILLATOR	F.E.C.	FIRE EXTINGUISHER CABINET	R.O.	ROUGH OPENING
AFF	ABOVE FINISHED FLOOR	F.F.	FINISH FLOOR	REFG	REFRIGERATOR
A.H.J.	AUTHORITY HAVING JURISDICTION	FDN	FOUNDATION	REQD	REQUIRED
ALT	ALTERNATE	FLR	FLOOR	RM	ROOM
BLKG	BLOCKING	FLR	FLOOR	R.T.U.	ROOF TOP UNIT
BLRD	BOLLARD	G.C.	GENERAL CONTRACTOR	S.F.	SQUARE FOOT
BOT	BOTTOM	G.F.A.	GROSS FLOOR AREA	SIM	SIMILAR
B.O.W.	BOTTOM OF WALL	GL	GLASS	SPR	SPRINKLER HEAD
CJ	CONTROL JOINT	GWB	GYPSPUM WALL BOARD	SPR(e)	SPRINKLER EXISTING
CLR	CLEAR	GA	GAUGE	ST	STREET
CMU	CONCRETE MASONRY UNIT	HDWD	HARDWOOD	S. STL	STAINLESS STEEL
CONC.	CONCRETE	HT	HEIGHT	STL	STEEL
CPT	CARPET	HVAC	HEATING, VENTILATION & AIR CONDITIONING	T	TREAD
CT	CERAMIC TILE	I.D.	INSIDE DIAMETER	T&B	TOP & BOTTOM
CTR	CENTER	I.L.O.	IN LIEU OF	T&G	TONGUE & GROOVE
CONT.	CONTINUOUS	INSUL	INSULATION	T.O.C.	TOP OF CONCRETE
DD	DUE DILIGENCE	INT.	INTERIOR	T.O.M.	TOP OF MASONRY
DEMO	DEMOLITION	LT	LIGHT	T.O.S.	TOP OF STEEL
DIA	DIAMETER	LT(ex)	LIGHT EXISTING	T.O.W.	TOP OF WALL
DIM	DIMENSION	M.O.	MASONRY OPENING	T.S.	TUBE STEEL
DN	DOWN	MAX	MAXIMUM	TEMP	TEMPORARY OR TEMPERED
DS	DOWNSPOUT	MIN	MINIMUM	TYP	TYPICAL
DWG	DRAWING	MTD	MOUNTED	U.O.N.	UNLESS OTHERWISE NOTED
E	EGRESS	N.E.F.	NEW EXHAUST VENT	U.L.	UNDERWRITERS LABORATORIES, INC.
E.F.U.	EXISTING FAN UNITS	N.I.C.	NOT IN CONTRACT	V.B.	VAPOR BARRIER
E.J.	EXPANSION JOINT	N.D.V.	NEW DRYER VENT	V.I.F.	VERIFY IN FIELD
E.P.	ELECTRICAL PANEL	N.K.V.	NEW KITCHEN VENT	W.C.	WATER CLOSET
E.T.R.	EXISTING TO REMAIN	O.C.	ON CENTER	W.H.	WATER HEATER
EA	EACH	OD	OUTSIDE DIAMETER	W/	WITH
ELEC	ELECTRICAL	OH	OVERHEAD	W/O	WITHOUT
EQ	EQUAL	OPP	OPPOSITE	WD	WOOD
EXIST	EXISTING	P.T.	PRESSURE TREATED	WRB	WEATHER RESISTIVE BARRIER
EXT	EXTERIOR	PLY	PLYWOOD	WP	WATERPROOFING


#### Standard Materials

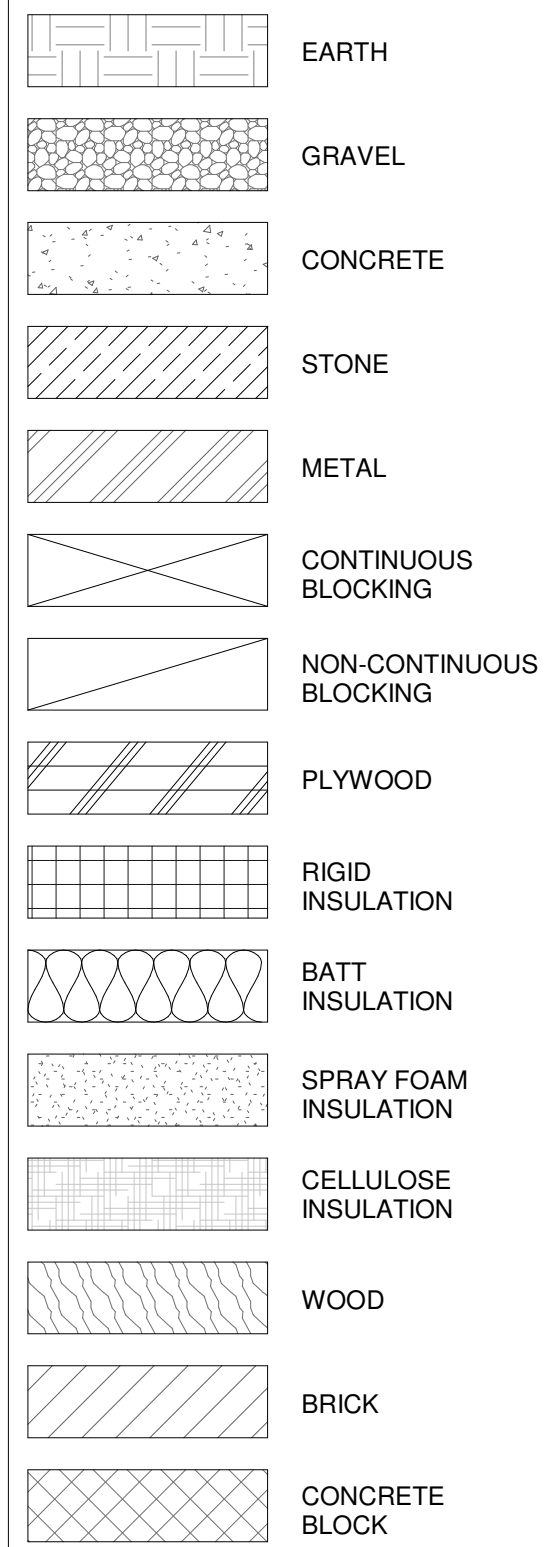


#### General Legend

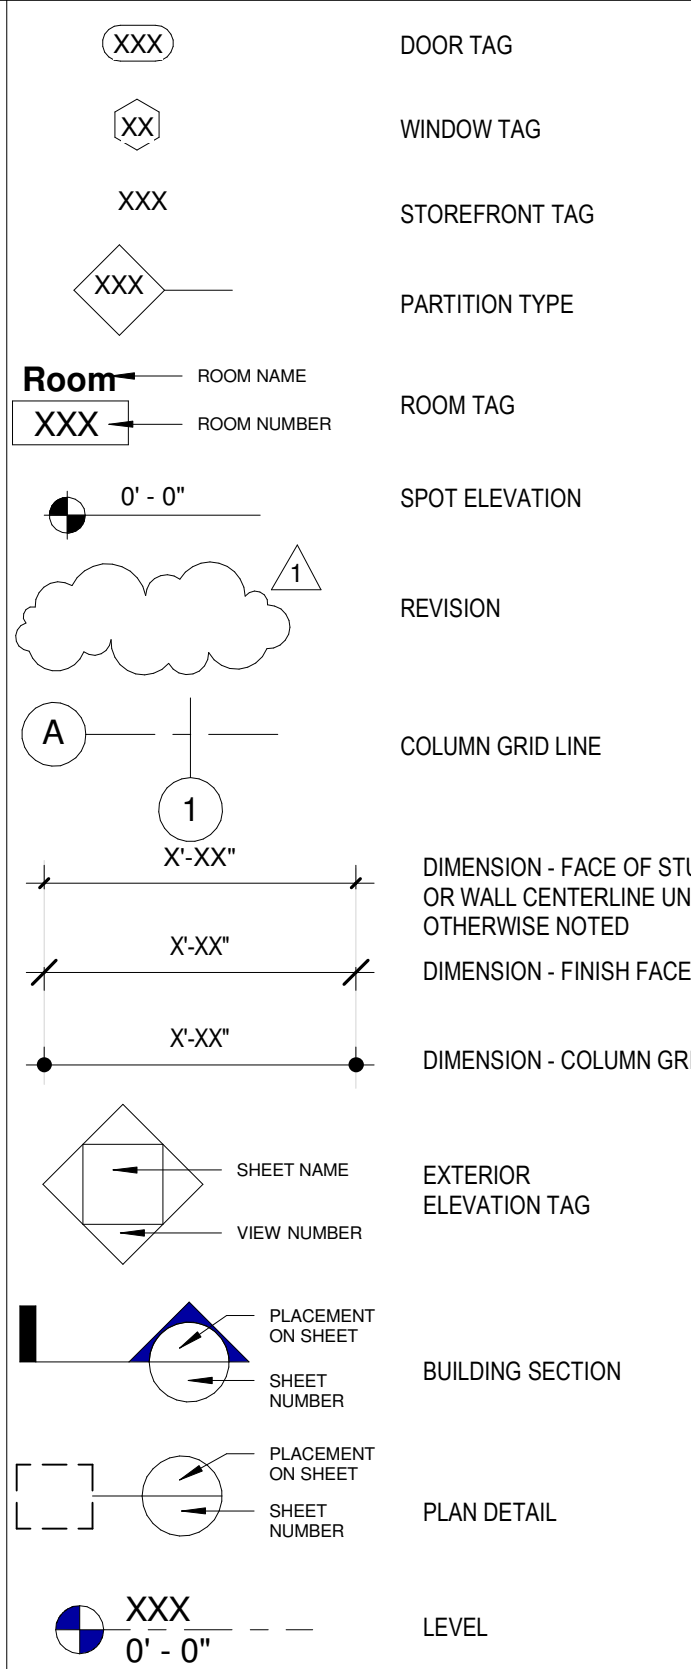

#### Locus Plan

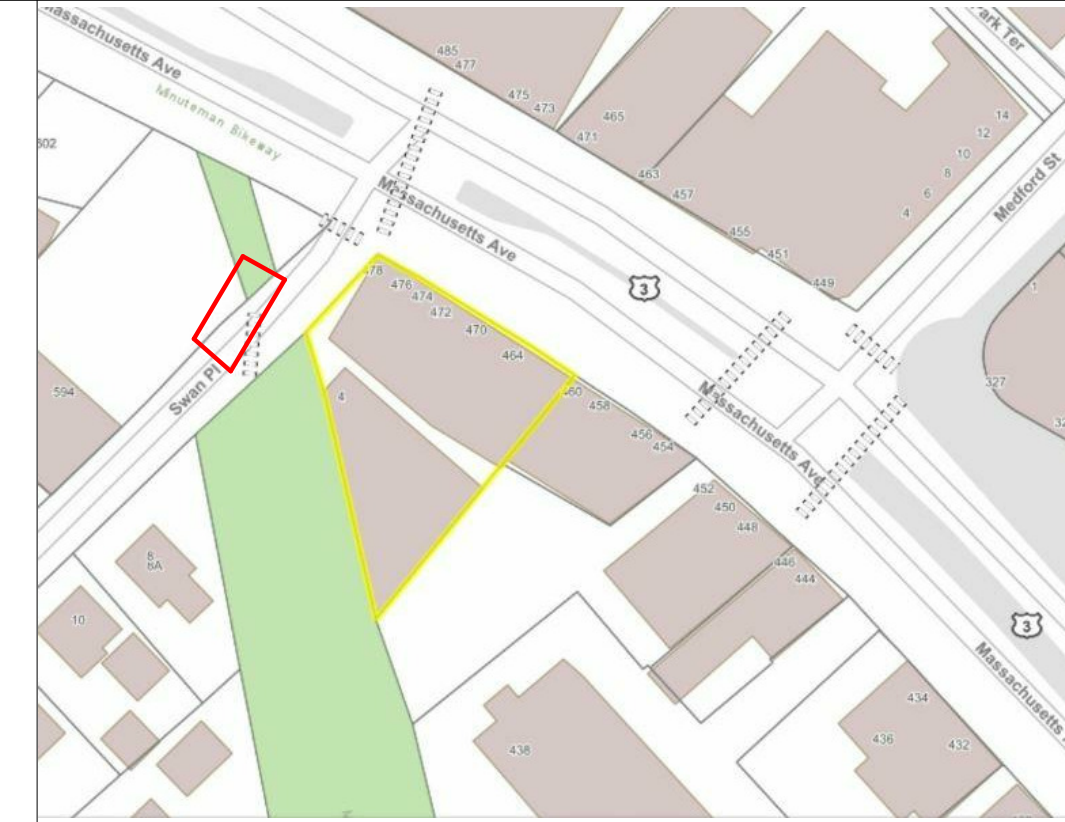

#### Plan Legend

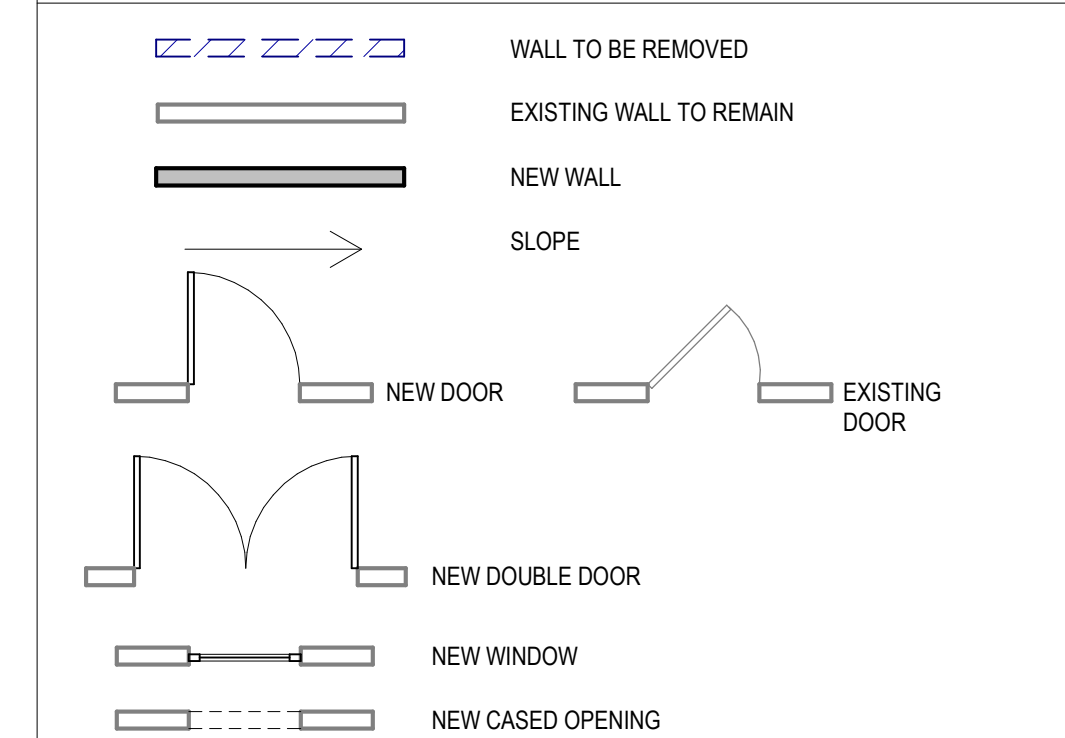

#### Drawing List

Sheet Number	Sheet Name
A0.1	Cover
A0.2	General Conditions & Requirements
A0.3	Demolition Floor Plans
A1.0	Floor Plans & Roof Plan
A2.0	Ceiling Plans, Partition Types, Schedules and Mounting Heights
A3.0	Elevations

#### Code References

- THIS APPLICATION TO COMPLY WITH, AND HAS BEEN DESIGNED IN ACCORDANCE WITH THE FOLLOWING GOVERNING AUTHORITIES:
- A. 780 CMR MASSACHUSETTS STATE BUILDING CODE - 9TH EDITION (2015 IBC)
  - B. 521 CMR REGULATIONS OF THE MASSACHUSETTS ARCHITECTURAL ACCESS BOARD
  - C. 2015 INTERNATIONAL EXISTING BUILDING CODE
  - D. INTERNATIONAL MECHANICAL CODE
  - E. 2015 INTERNATIONAL FIRE CODE
  - F. 248 CMR MASSACHUSETTS INFORM STATE PLUMBING CODE
  - G. NATIONAL ELECTRICAL CODE


#### Hardware Sets

<b>HW-1 (BUILDING ENTRANCE- EXTERIOR)</b> <ul style="list-style-type: none"> <li>HINGES</li> <li>PULL</li> <li>SILENCERS</li> <li>DOOR SWEEP</li> <li>THRESHOLD &amp; WEATHERSTRIPPING</li> <li>EXIT DEVICE</li> <li>CYLINDER CORE</li> <li>CLOSER</li> </ul>	<b>HW-2 (RESTROOM PRIVATE)</b> <ul style="list-style-type: none"> <li>HINGES</li> <li>LOCKSET</li> <li>CLOSER</li> <li>GASKETS</li> <li>VACANT INDICATOR</li> <li>SILENCERS</li> <li>KICKPLATES</li> </ul>	<b>HW-3 (BASEMENT)</b> <ul style="list-style-type: none"> <li>LOCKSET</li> <li>HINGES</li> <li>THRESHOLD</li> <li>WEATHER STRIPPING</li> <li>CLOSER</li> </ul>
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#### Area Calculations

	Existing
Basement	725 SF
Level One	680 SF
<b>Total</b>	<b>1,405 SF</b>

#### Area Plans, Travel Distance and Occupancy

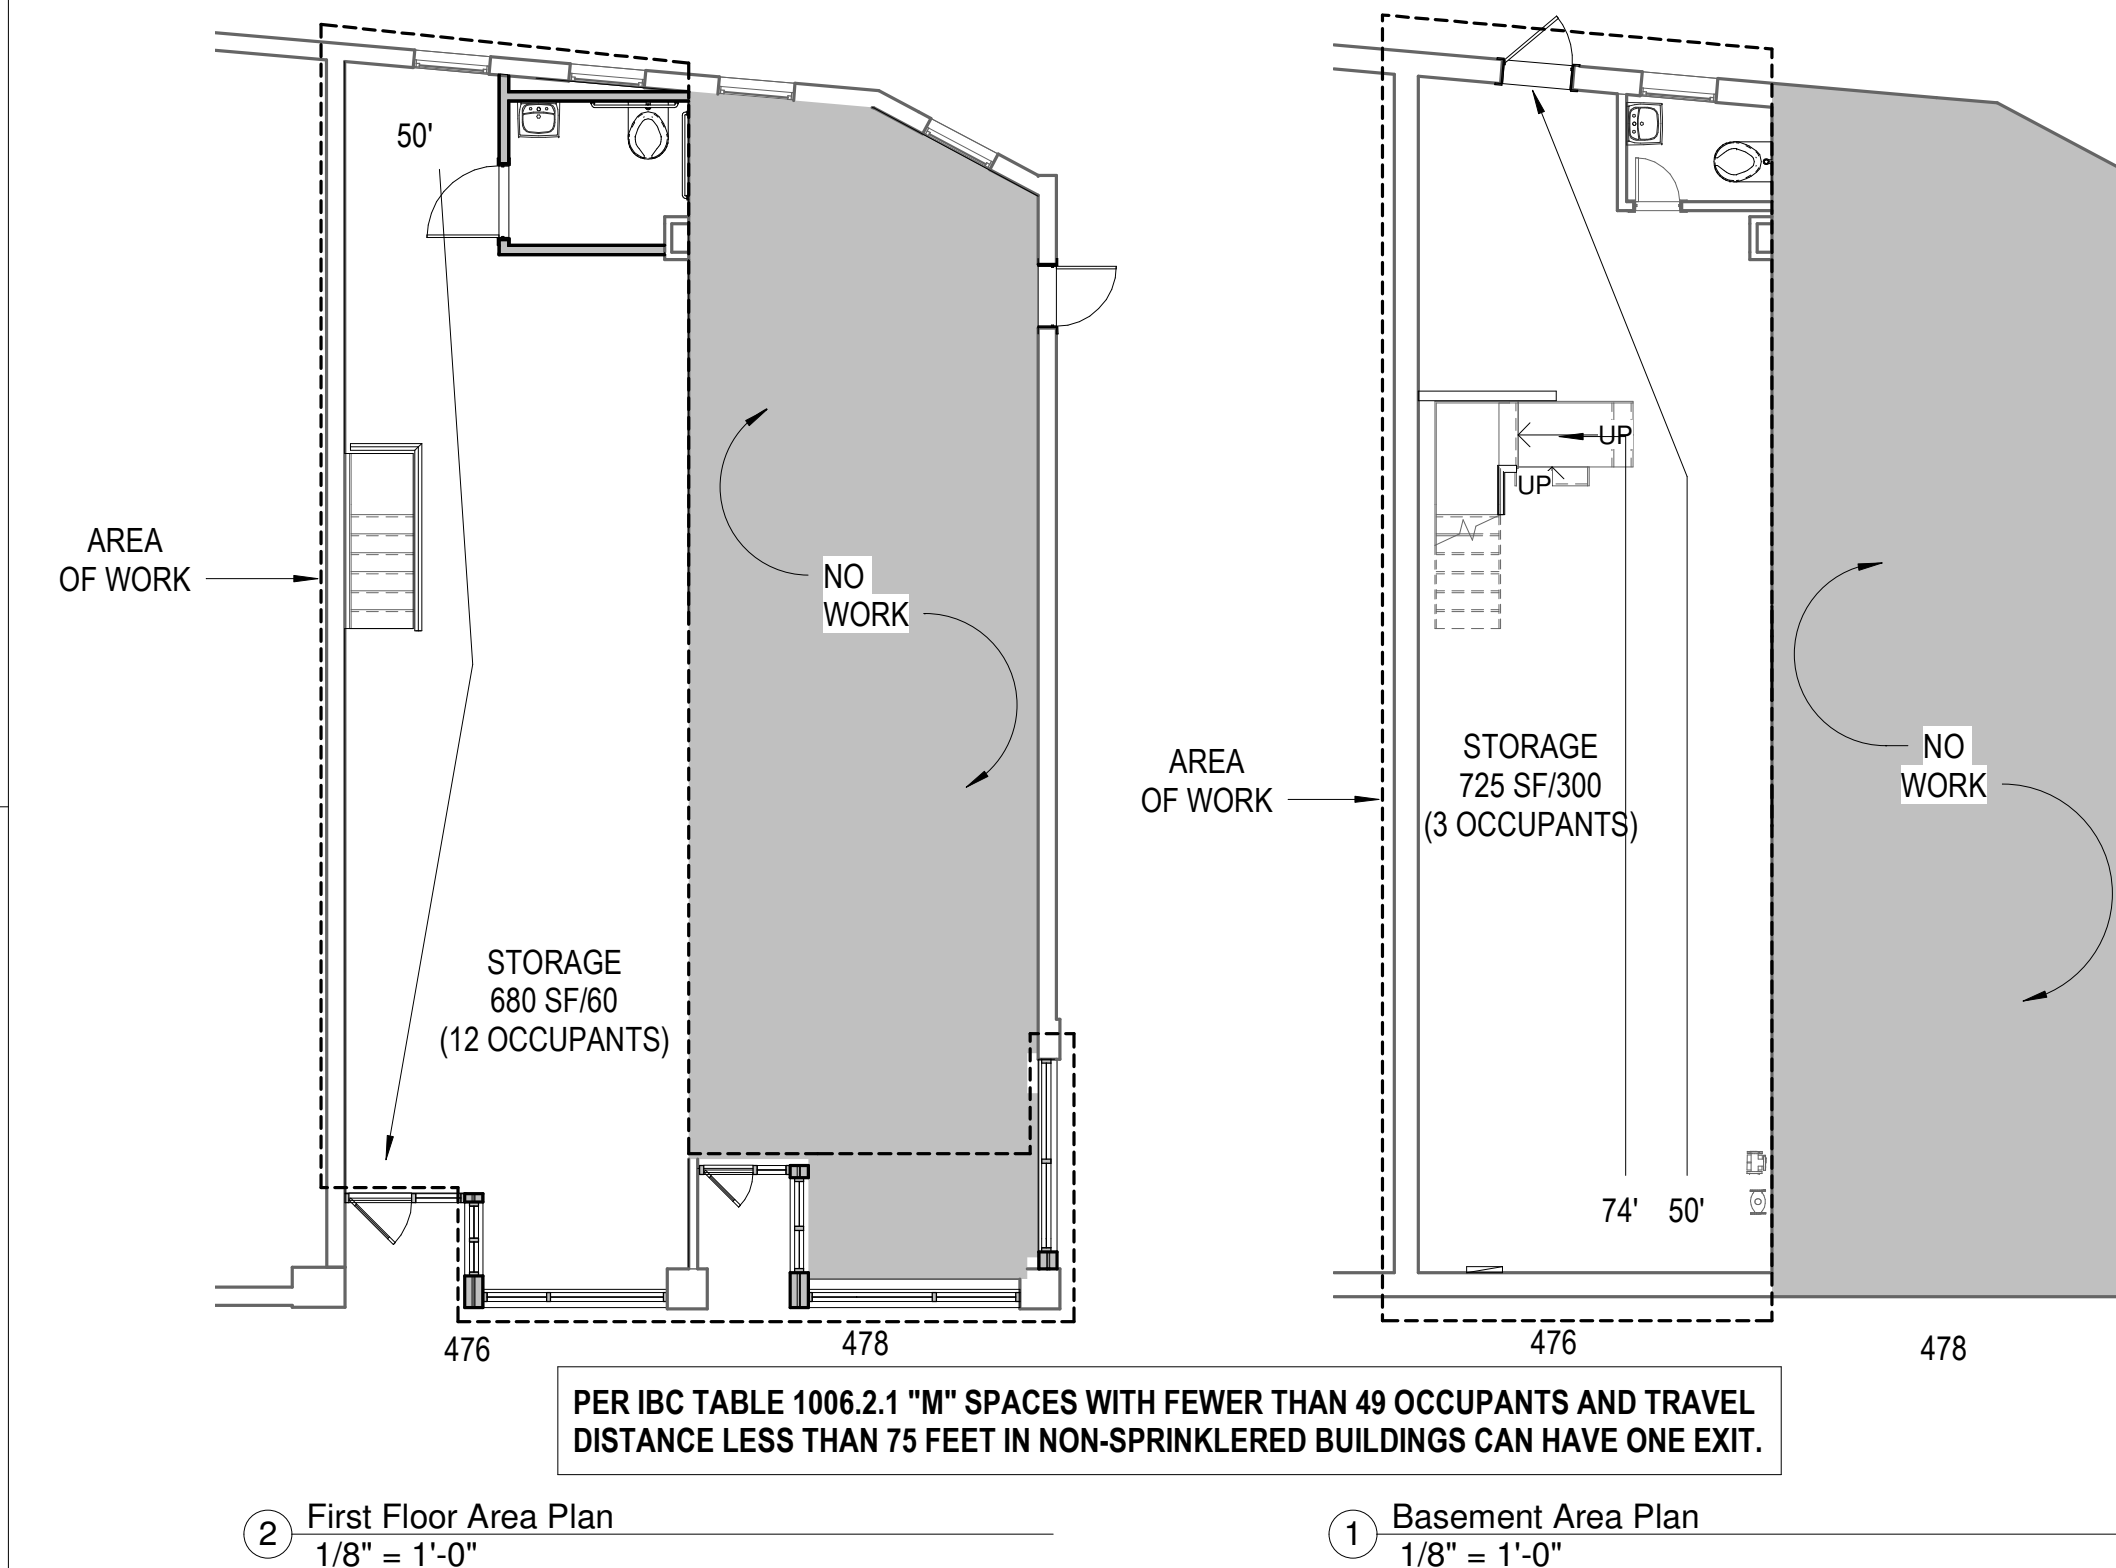

#### General Project Notes

- GENERAL NOTES**
- All of the work shown on the drawings is the responsibility of the General Contractor unless specifically noted otherwise.
  - The General Contractor shall review the contract documents and verify existing site conditions prior to submitting a bid, proposal or agreement. The General Contractor's proposal shall include all trades and services necessary for completion of the work. The General Contractor shall note all existing conditions which interfere or conflict with the working drawings and report the inconsistencies prior to bid, proposal or agreement.
  - Construction means and methods are the sole responsibility of the General Contractor. The Designer has accounted for the most common techniques used in the design of this project.
  - The Builder is the sole party in control of the work environment, and must verify all dimensions on the plans with existing site conditions prior to commencement of work. Any discrepancies shall be brought to the attention of the Architect.
  - All dimensions to be verified in the field, with any discrepancies reported to the Architect before proceeding with the work. Do not scale these drawings. If a discrepancy is found, the General Contractor is to contact the designer for interpretation of intent prior to commencement of work. All work shall be performed by licensed tradesmen according to all applicable local, state and federal laws, codes and standards.
  - All materials and construction assemblies shall conform to all applicable manufacturers specifications, installation and performance standards.
  - All new construction shall comply with the Massachusetts Energy Code.
  - Alteration/renovation work requires that certain assumptions be made regarding existing conditions, and because some of these assumptions can not be verified without great expense and / or destroying serviceable portions of the building, the Architect shall not be responsible for any unforeseen conditions including any hazardous material.
  - Unless otherwise shown or noted, all details are considered to be typical and shall be used where applicable.
  - Safety measures: At all times the General Contractor shall be solely and completely responsible for the conditions of the job site, including safety of the persons and property, and for all independent engineering reviews of these conditions. The Architect or Engineer's job site reviews are not intended to include review of the General Contractor's safety measures.
  - Plans, notations and details are hierarchical. Highly detailed drawings take precedence over lower detailed drawings. Notations take precedence of graphical drawings.
  - Where mechanical, electrical, plumbing or specialty drawings are prepared by the Builder or the Builder's sub-contractor, the drawings shall be considered shop drawings and shall be submitted to the Designer for review prior to submittal to the building department and/or commencement of work. The Designer retains the right to reject shop drawings not in conformance with the design intent.

#### ADDITIONAL TERMS OR CONDITIONS


- The General Contractor must notify the Owner in writing of any additional terms, qualifications, or conditions with their bid, as such claims will not be considered after that time.

#### OWNERSHIP OF DOCUMENTS

- The construction documents as instruments of professional service are and shall remain the property of the Architect. Documents are not to be used, in whole or in part, for other projects or purposes or by any other parties other than those authorized by contract without the specific written authorization of the Architect.

ID.	DESCRIPTION	MANUFACTURER, STYLE & COLOR
TA1	COAT HOOK	BOBRICK
TA2	GRAB BAR	BOBRICK, B-5806 99x42" - 1/4" DIA. STRAIGHT PEENED
TA3	TOILET TISSUE DISPENSER - SURFACE MOUNTED	BOBRICK, B-2888
TA4	PAPER TOWEL DISPENSER & WASTE RECEPTACLE	BOBRICK, B-3944
TA5	SOAP DISPENSER - WALL	BOBRICK
TA6	MIRROR	BOBRICK, B-165 - 1836

NOTE: ALL TOILET ACCESSORIES TO HAVE SATIN FINISH STAINLESS STEEL

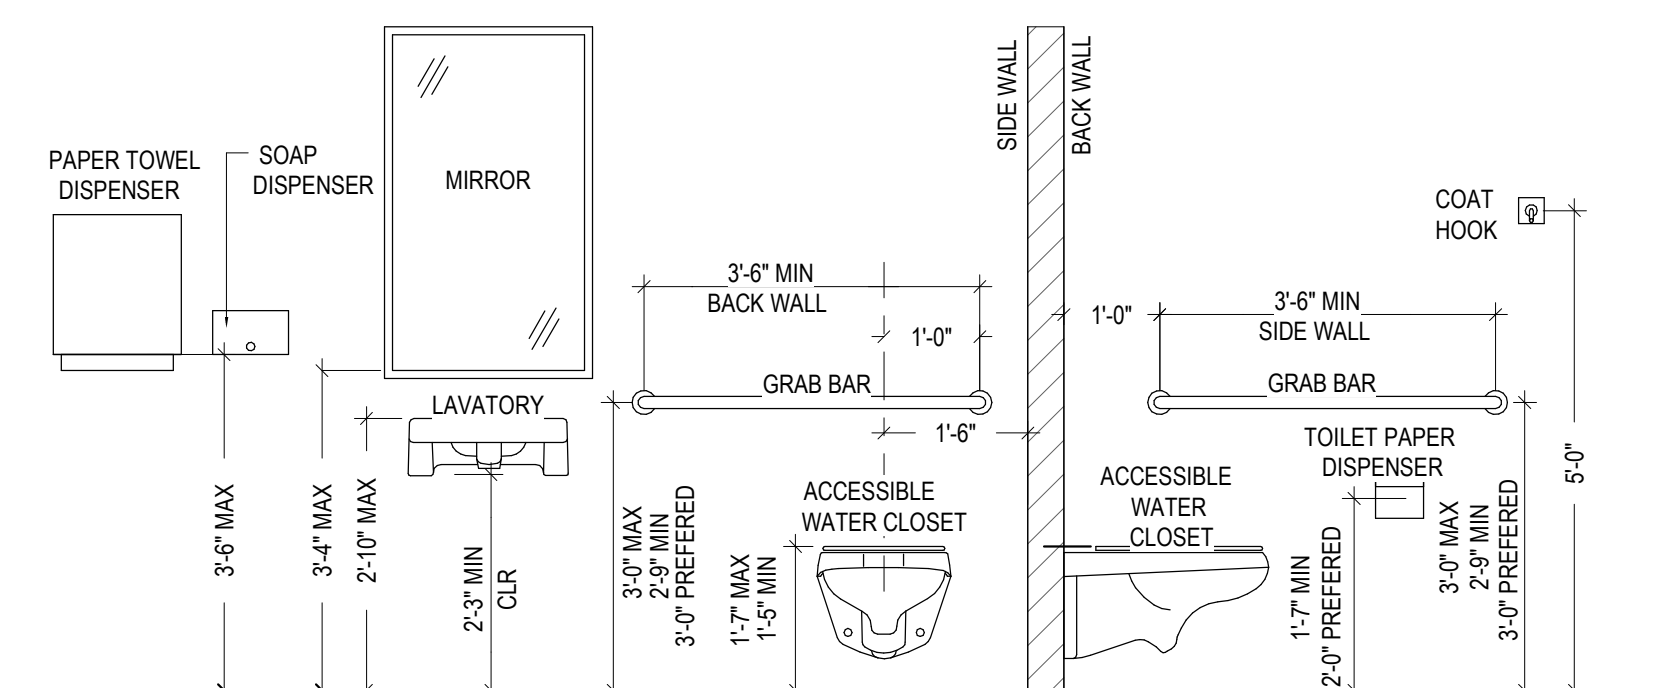

PROJECT NAME  
**476 Massachusetts Ave**  
PERMIT SET

#	Date	Description



SHEET NAME  
**Cover**

SHEET ISSUED: 12/16/2019  
SCALE: As indicated  
DRAWN BY: RA  
PROJECT #: 2018-40A

SHEET NUMBER  
**A0.1**




**GENERAL DEMOLITION NOTES**

1. CONTRACTOR TO SHORE, BRACE AND PROTECT ALL EXISTING STRUCTURE, WALLS, EQUIPMENT, FINISHES, ETC. TO REMAIN AS NECESSARY THROUGHOUT WORK. CONTRACTOR SHALL PLACE PROTECTIVE PLASTIC OVER FLOOR FINISHES WHERE WORKERS TRAVEL.
2. CONTRACTOR TO COORDINATE UTILITY LOCATION, SERVICE INTERRUPTION, PERMITS AND APPLICATIONS, ETC. WITH APPROPRIATE UTILITY COMPANIES PRIOR TO THE START OF ANY WORK. CAP AND PROTECT SERVICE LINES FOR POSSIBLE REUSE. PROTECT ALL PANELS, METERS, ETC. TO BE RELOCATED OR TO REMAIN.
3. CONTRACTOR TO VERIFY ALL CONDITIONS BEFORE PROCEEDING WITH THE DEMOLITION WORK IN ANY AREA. DEMOLITION OF DOORS, WINDOWS, MILLWORK, FINISHES, PARTITIONS, OR ANY OTHER NON-STRUCTURAL ITEM MAY PROCEED AS INDICATED. WHERE DISCREPANCIES INVOLVE STRUCTURAL ITEMS, REPORT SUCH DIFFERENCES TO THE ARCHITECT AND RECEIVE INSTRUCTIONS BEFORE PROCEEDING IN THE AFFECTED AREA.
4. ALL RUBBISH AND DEBRIS DUE TO DEMOLITION SHALL BE PROMPTLY REMOVED FROM SITE AND DISPOSED OF PROPERLY. THE STORAGE OR SALE OF ANY SALVAGED MATERIALS ON SITE IS PROHIBITED.
5. CONTRACTOR TO PROVIDE SECURITY FENCING, PARTITIONS, LIGHTING, ETC. TO ADEQUATELY PROTECT THE PROPERTY AND SAFEGUARD PEDESTRIAN AND/OR VEHICULAR TRAFFIC FROM INJURY OR DAMAGE ON OR IN THE IMMEDIATE VICINITY OF THE SITE DURING CONSTRUCTION.
6. ANY COLUMNS, BEAMS, ETC. STEEL OR OTHERWISE, UNCOVERED DURING THE DEMOLITION OF BEARING WALLS SHALL REMAIN IN PLACE. THE ARCHITECT SHALL IMMEDIATELY BE CONTACTED FOR INSTRUCTION AND RESOLUTION.
7. THE CONTRACTOR SHALL COORDINATE WITH THE OWNER THE SALVAGE OF LIGHT FIXTURES, FURNISHINGS, DOORS, AND MISCELLANEOUS EQUIPMENT AT THE OWNERS REQUEST. ITEMS TO BE STORED AND PROTECTED BY CONTRACTOR.
8. REFER TO STRUCTURAL, MECHANICAL, ELECTRICAL, PLUMBING, AND FIRE PROTECTION DRAWINGS FOR ADDITIONAL DEMOLITION NOTES AND INFORMATION.
9. THE CONTRACTOR SHALL PROVIDE ALL NECESSARY BARRICADES AND OTHER FORMS OF PROTECTION AS REQUIRED TO PROTECT THE OWNER'S PERSONNEL, OTHER TENANTS, AND GENERAL PUBLIC FROM INJURY, NOISE, ACTIVITY, DUST AND DEBRIS DUE TO DEMOLITION WORK.
10. THE CONTRACTOR SHALL ENSURE THAT DEMOLITION WORK DOES NOT INTERFERE WITH OR PROHIBIT THE CONTINUED OCCUPATION OF ADJACENT OPERATIONS WITHIN THE STRUCTURE. THIS INCLUDES BUT IS NOT LIMITED TO THE SELECTIVE DEMOLITION OF PARTITIONS, ELECTRICAL AND MECHANICAL SYSTEMS. THE CONTRACTOR SHALL INFORM THE OWNER A MINIMUM OF 72 HOURS BEFORE DEMOLITION THAT WILL EFFECT NORMAL OPERATION OF THE BUILDING.
11. THE CONTRACTOR SHALL PROTECT ALL EXISTING CONSTRUCTION AND EQUIPMENT TO REMAIN. THE CONTRACTOR SHALL REPAIR DAMAGES CAUSED TO ADJACENT FACILITIES BY DEMOLITION WORK.
12. CONTRACTOR SHALL PROTECT ALL EXISTING AREAS FROM WEATHER DURING DEMOLITION.
13. FOR ALL NEW OR MODIFIED OPENINGS IN EXISTING TO REMAIN MASONRY WALLS, THE CONTRACTOR SHALL PROVIDE AND INSTALL LOOSE LINTEL SUPPORT AS REQUIRED. REFER TO DRAWINGS.
14. AT LOCATIONS OF MASONRY WALL DEMOLITION INDICATED ON THE DRAWINGS WHERE EXISTING PORTION IS TO REMAIN, THE CONTRACTOR SHALL CUT MASONRY WALLS AT CLOSEST MORTAR JOINT TO PROVIDE FOR TOOTH-IN CONDITION OF NEW AND EXISTING MASONRY SIZE, TYPE, COURSING AND FINISH. THE CONTRACTOR IS RESPONSIBLE FOR REMOVING AND DISPOSING ALL MATERIAL.

PROJECT NAME  
**476 Massachusetts Ave**  
 PERMIT SET



#	Date	Description

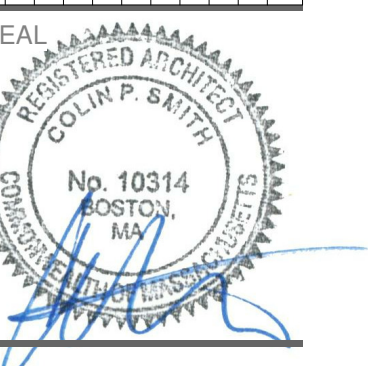

SHEET NAME  
**Demolition Floor Plans**

SHEET ISSUED: 12/12/2019  
 SCALE: As indicated  
 DRAWN BY:  
 PROJECT #: 2018-40A


SHEET NUMBER  
**A0.3**

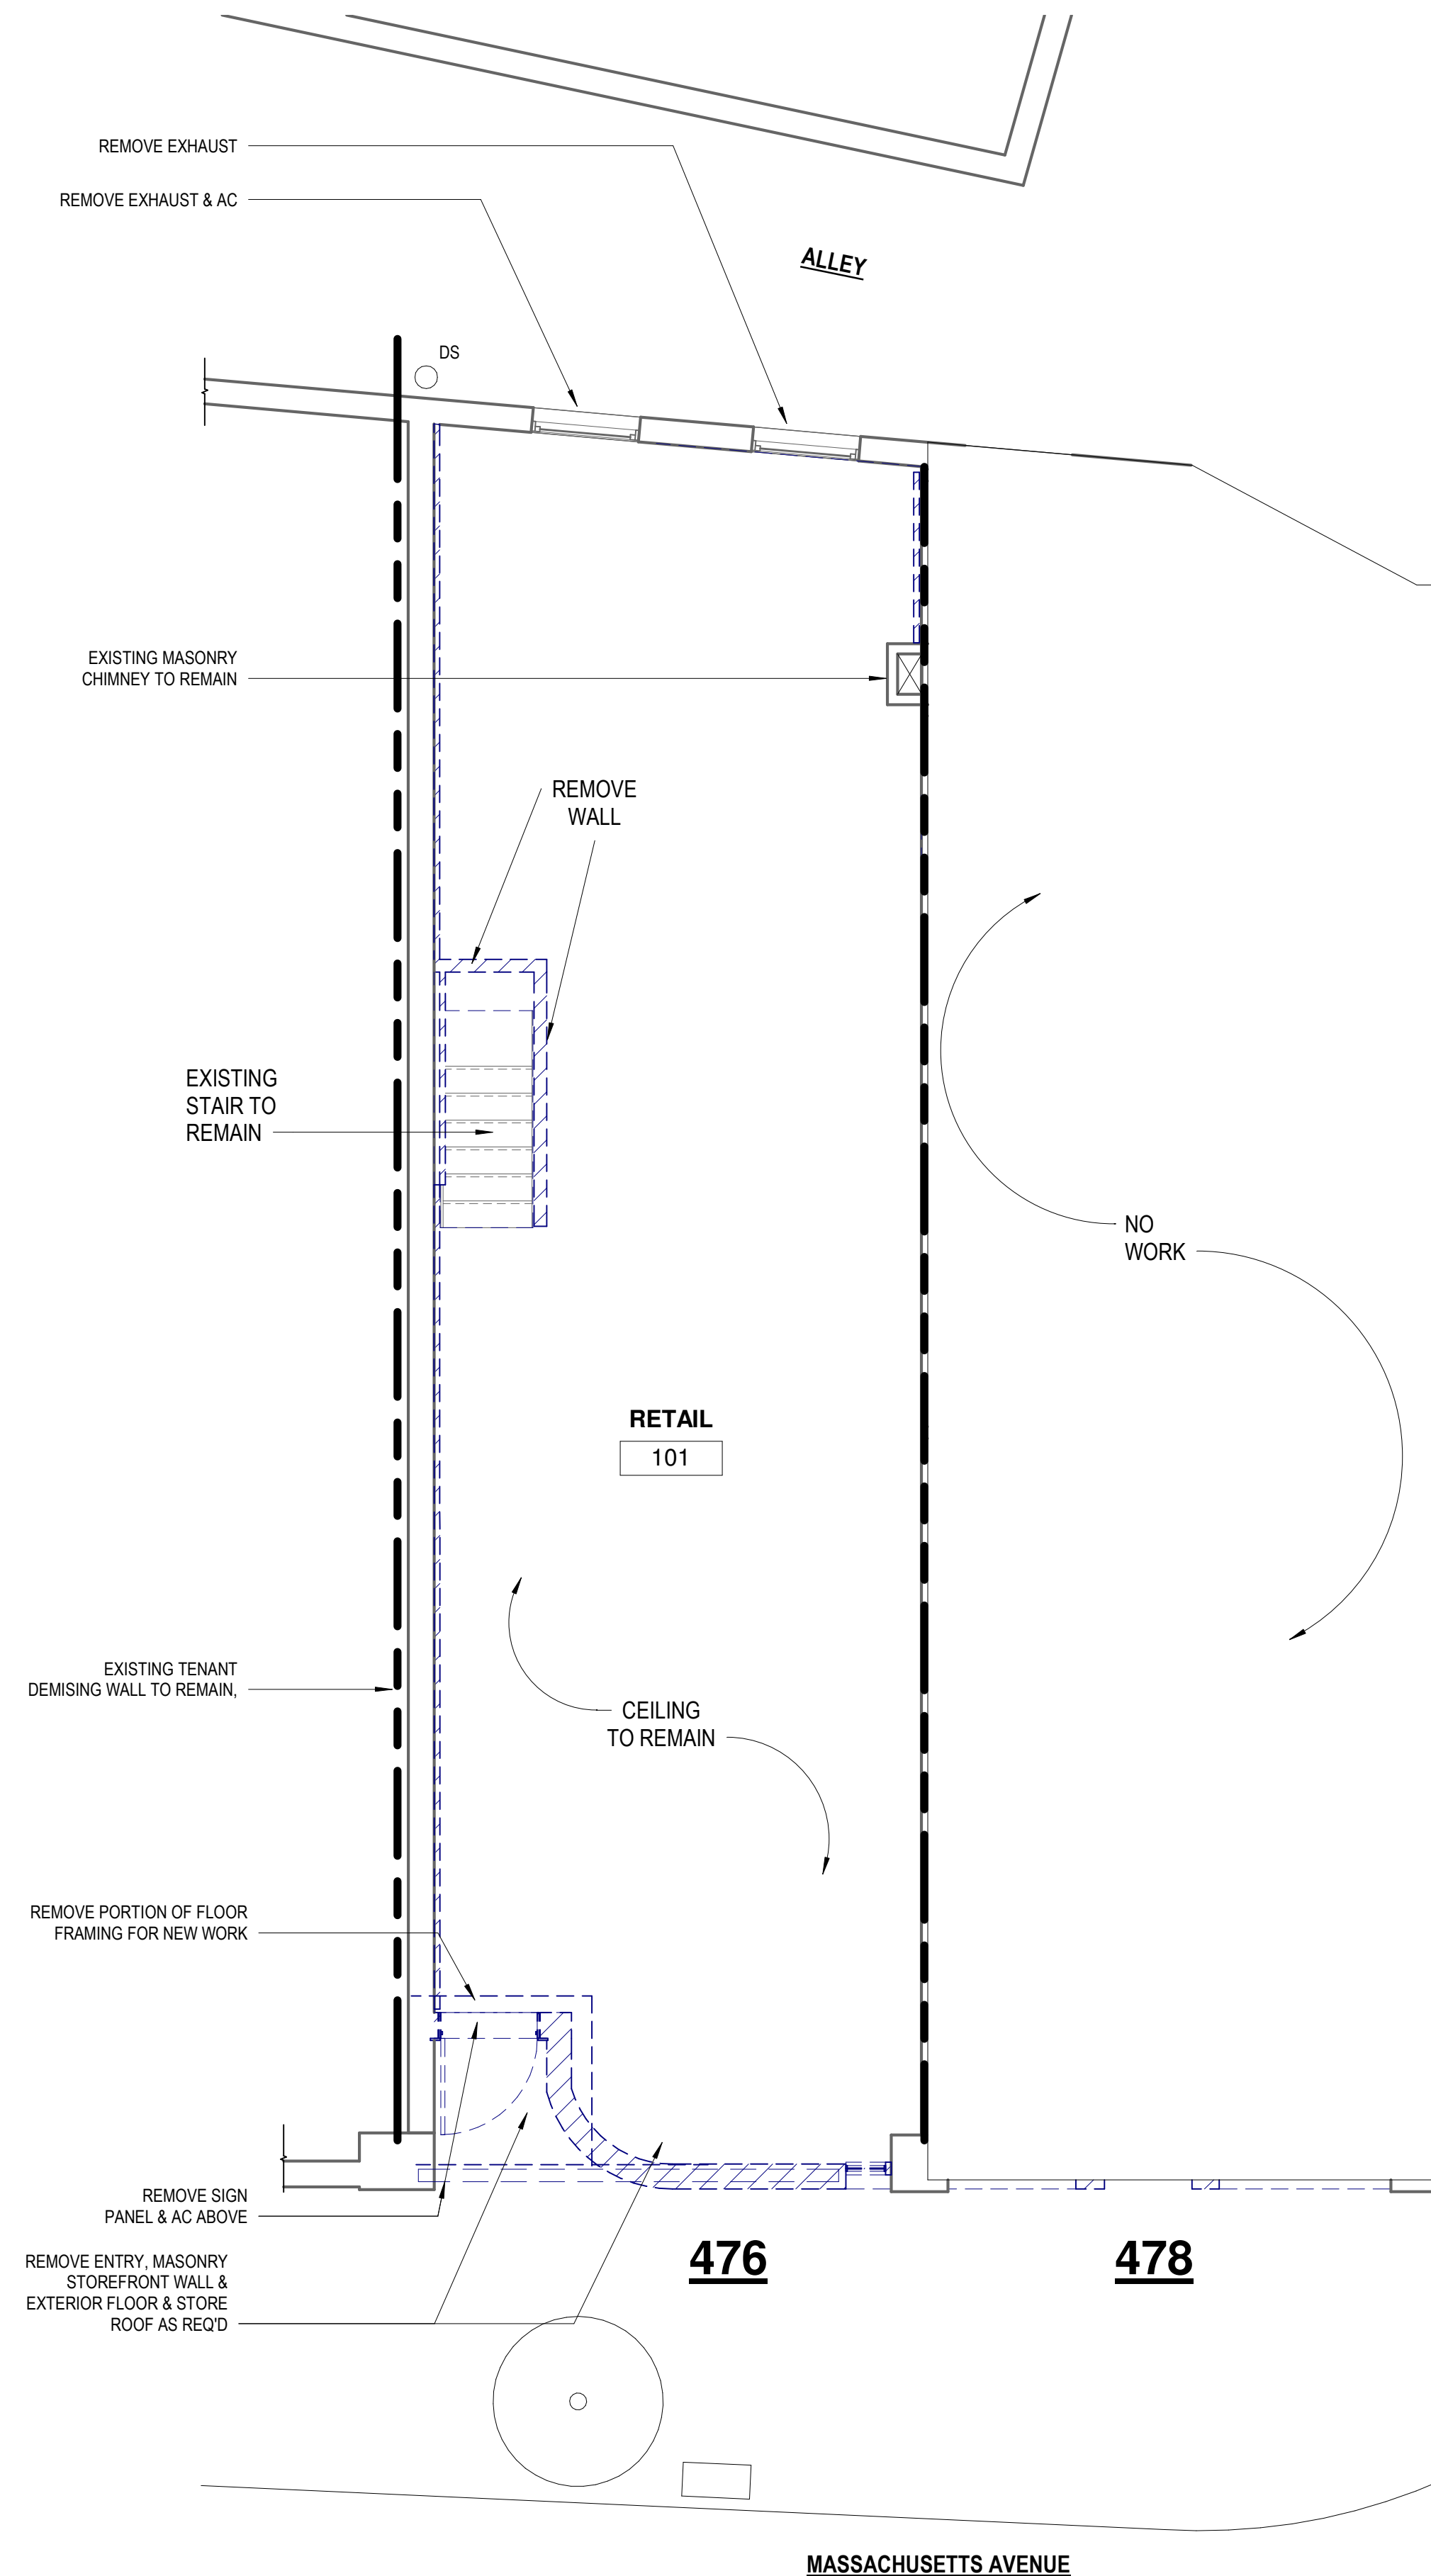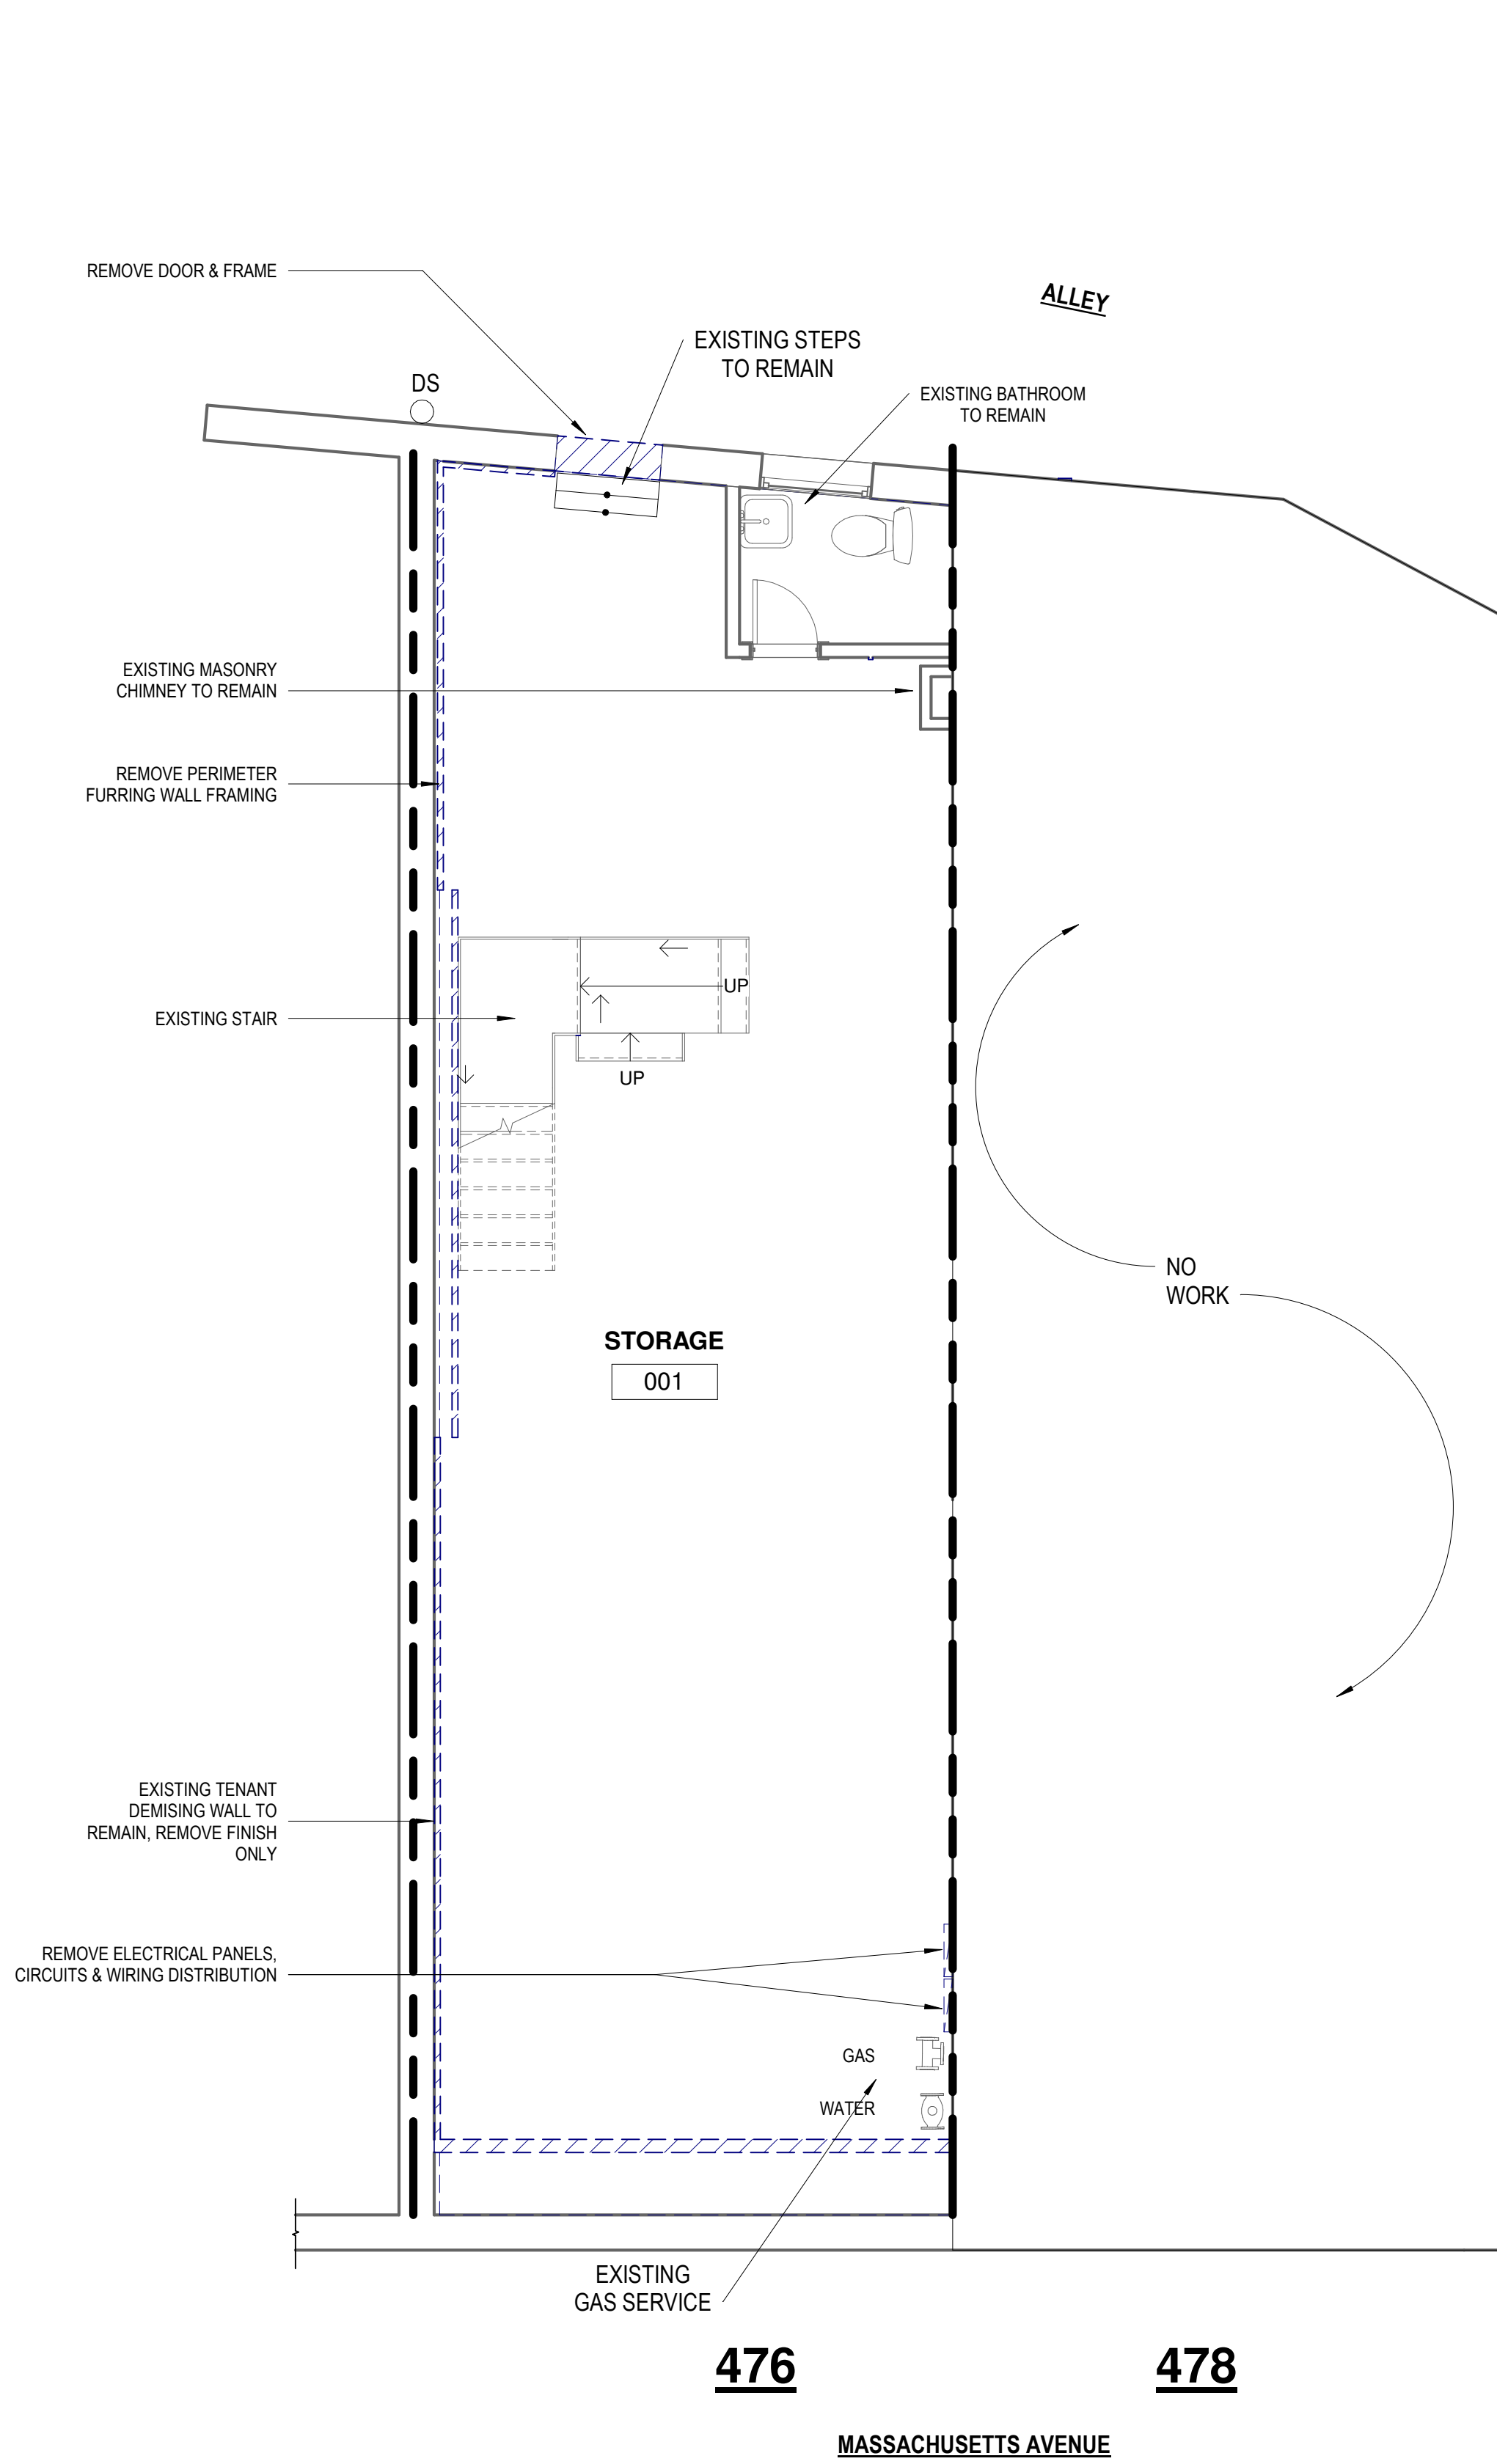

- GENERAL PLAN NOTES**
1. PRIOR TO INSPECTION OF THE EXISTING FACILITY, THE CONTRACTOR MUST RECEIVE PERMISSION FOR SITE ACCESS FROM THE OWNER OR THE DESIGNATED REPRESENTATIVE.
  2. VERIFY ALL DIMENSIONS AND CONDITIONS AT JOB SITE PRIOR TO SUBMISSION OF BIDS. COMPARE ARCHITECTURAL DRAWINGS WITH MECHANICAL AND ELECTRICAL CONDITIONS, ANY VARIATIONS OR DISCREPANCIES ARE TO BE REPORTED TO THE CONSTRUCTION MANAGER AND/OR COLIN SMITH ARCHITECTURE, INC. SUBMIT ALL NECESSARY SHOP DRAWINGS PRIOR TO FABRICATION FOR APPROVAL BY COLIN SMITH ARCHITECTURE, INC. AND/OR RESPECTIVE PROJECT ENGINEERS.
  3. DO NOT SCALE FROM THESE DRAWINGS.
  4. UNLESS OTHERWISE SHOWN, OR NOTED, ALL TYPICAL DETAILS SHALL BE USED WHERE APPLICABLE.
  5. ABBREVIATIONS THROUGHOUT THE PLANS ARE THOSE IN COMMON USE. NOTIFY ARCHITECT OF ANY ABBREVIATIONS IN QUESTION.
  6. CONTRACTOR SHALL COORDINATE THE INSTALLATION OF THE VARIOUS TRADE ITEMS WITHIN THE SPACE ABOVE ALL CEILINGS (INCLUDING, BUT NOT LIMITED TO: STRUCTURAL MEMBERS, MECHANICAL DUCTS AND INSULATION, CONDUITS, RACEWAYS, SPRINKLER SYSTEM, LIGHT FIXTURES, CEILING SYSTEMS, AND ANY SPECIAL STRUCTURAL SUPPORTS REQUIRED) AND SHALL BE RESPONSIBLE FOR MAINTAINING THE FINISH CEILING HEIGHT ABOVE THE FINISH FLOOR INDICATED IN THE DRAWINGS AND THE FINISH SCHEDULE. (CEILING HEIGHT DIMENSIONS ARE TO THE FINISH SURFACE OF THE CEILING)
  7. INSTALL FIRE EXTINGUISHER CABINETS AND EXTINGUISHERS IN ACCORDANCE WITH MANUFACTURER INSTRUCTION AND AS DIRECTED BY THE LOCAL FIRE MARSHALL. NOTIFY ARCHITECT PRIOR TO INSTALLATION IN LOCATIONS SHALL VARY FROM DESIGN LOCATIONS. PROVIDE BLOCKING AS REQUIRED TO SECURELY FASTENERS BEST SUITED TO SUBSTRATE.
  8. ALL NEW DOOR LOCATIONS ARE TO BE 6" FROM DOOR FRAME TO NEAREST WALL UNLESS OTHERWISE NOTED ON THE DRAWINGS.
  9. CONTRACTOR SHALL PROVIDE AND INSTALL ALL STIFFENERS, BRACINGS, BACK-UP PLATES AND SUPPORTING BRACKETS REQUIRED FOR THE INSTALLATION OF ALL CASEWORK, TOILET ACCESSORIES AND OF ALL FLOOR-MOUNTED OR SUSPENDED MECHANICAL AND ELECTRICAL EQUIPMENT.
  10. REFER TO ELECTRICAL & MECHANICAL DRAWINGS FOR ADDITIONAL INFO.

PROJECT NAME  
**476 Massachusetts Ave**  
 PERMIT SET


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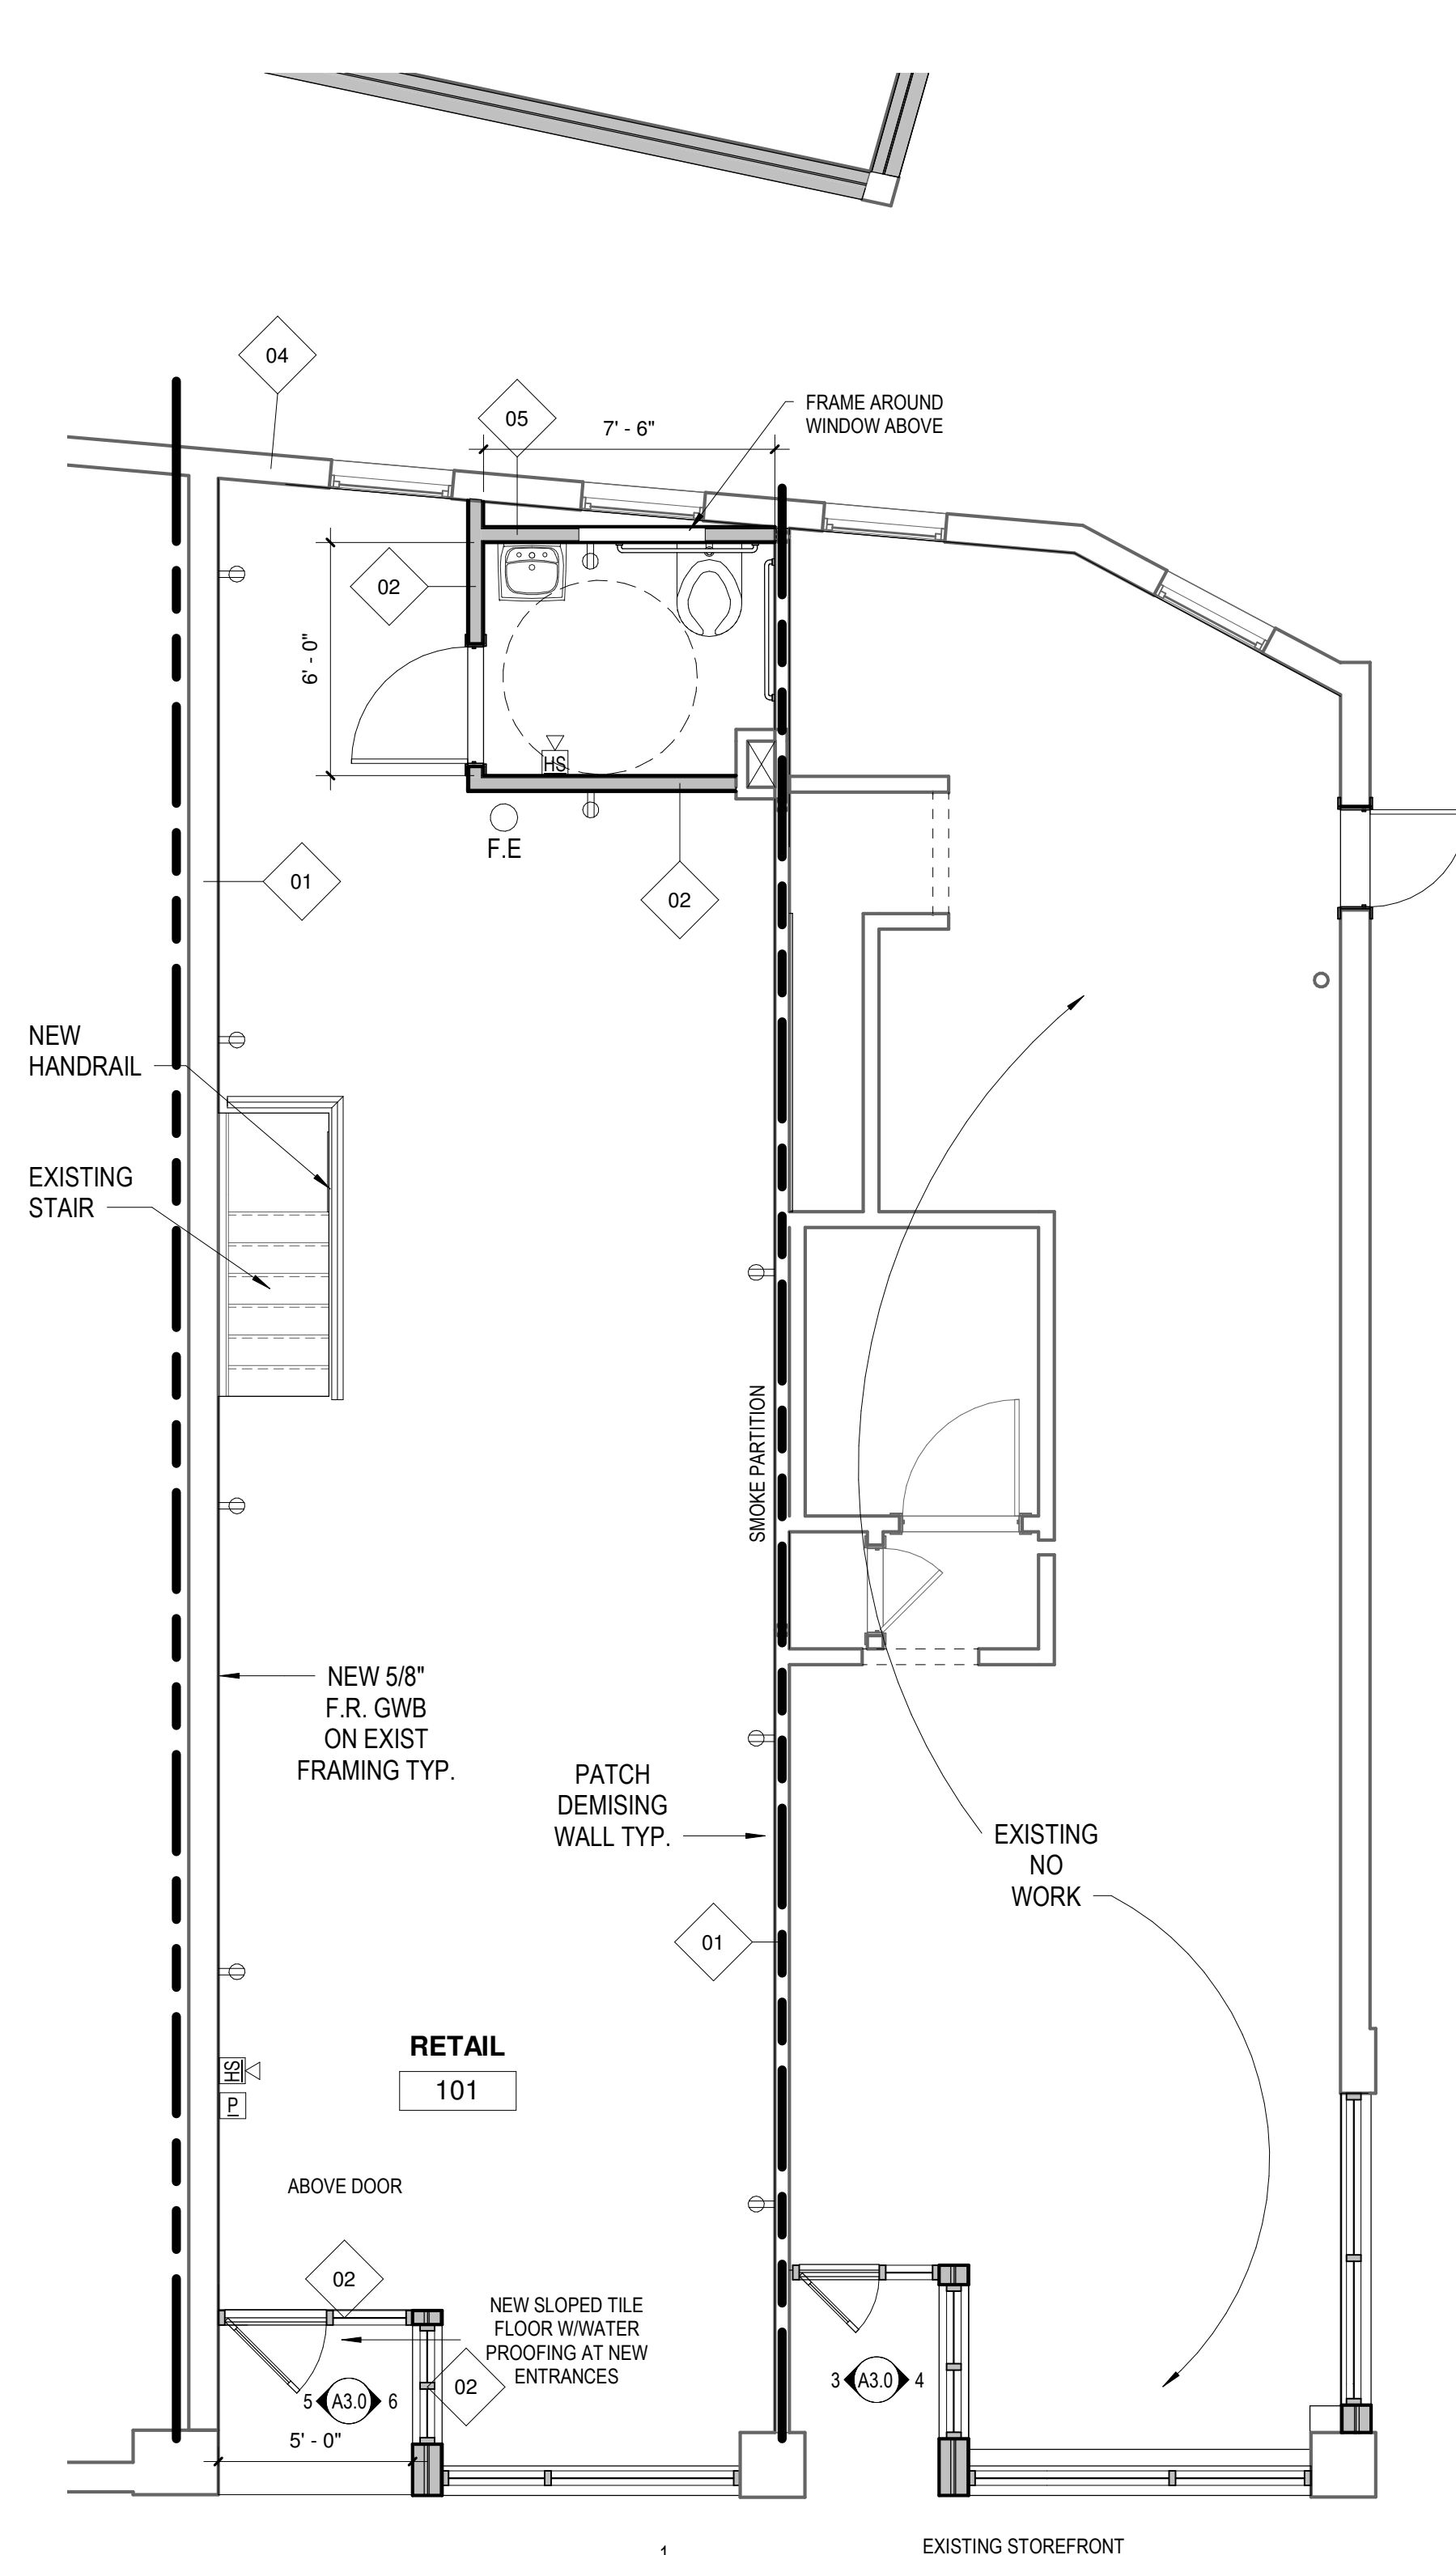
SHEET NAME  
**Floor Plans & Roof Plan**

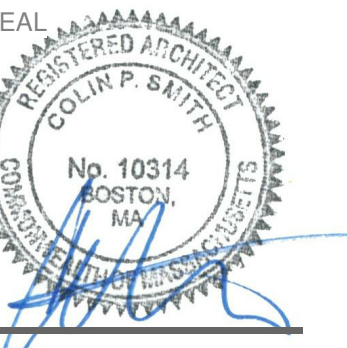SHEET ISSUED: 12/12/2019  
 SCALE: As indicated  
 DRAWN BY:  
 PROJECT #: 2018-40A


SHEET NUMBER  
**A1.0**



3 Roof Plan (Proposed)  
 1/4" = 1'-0"

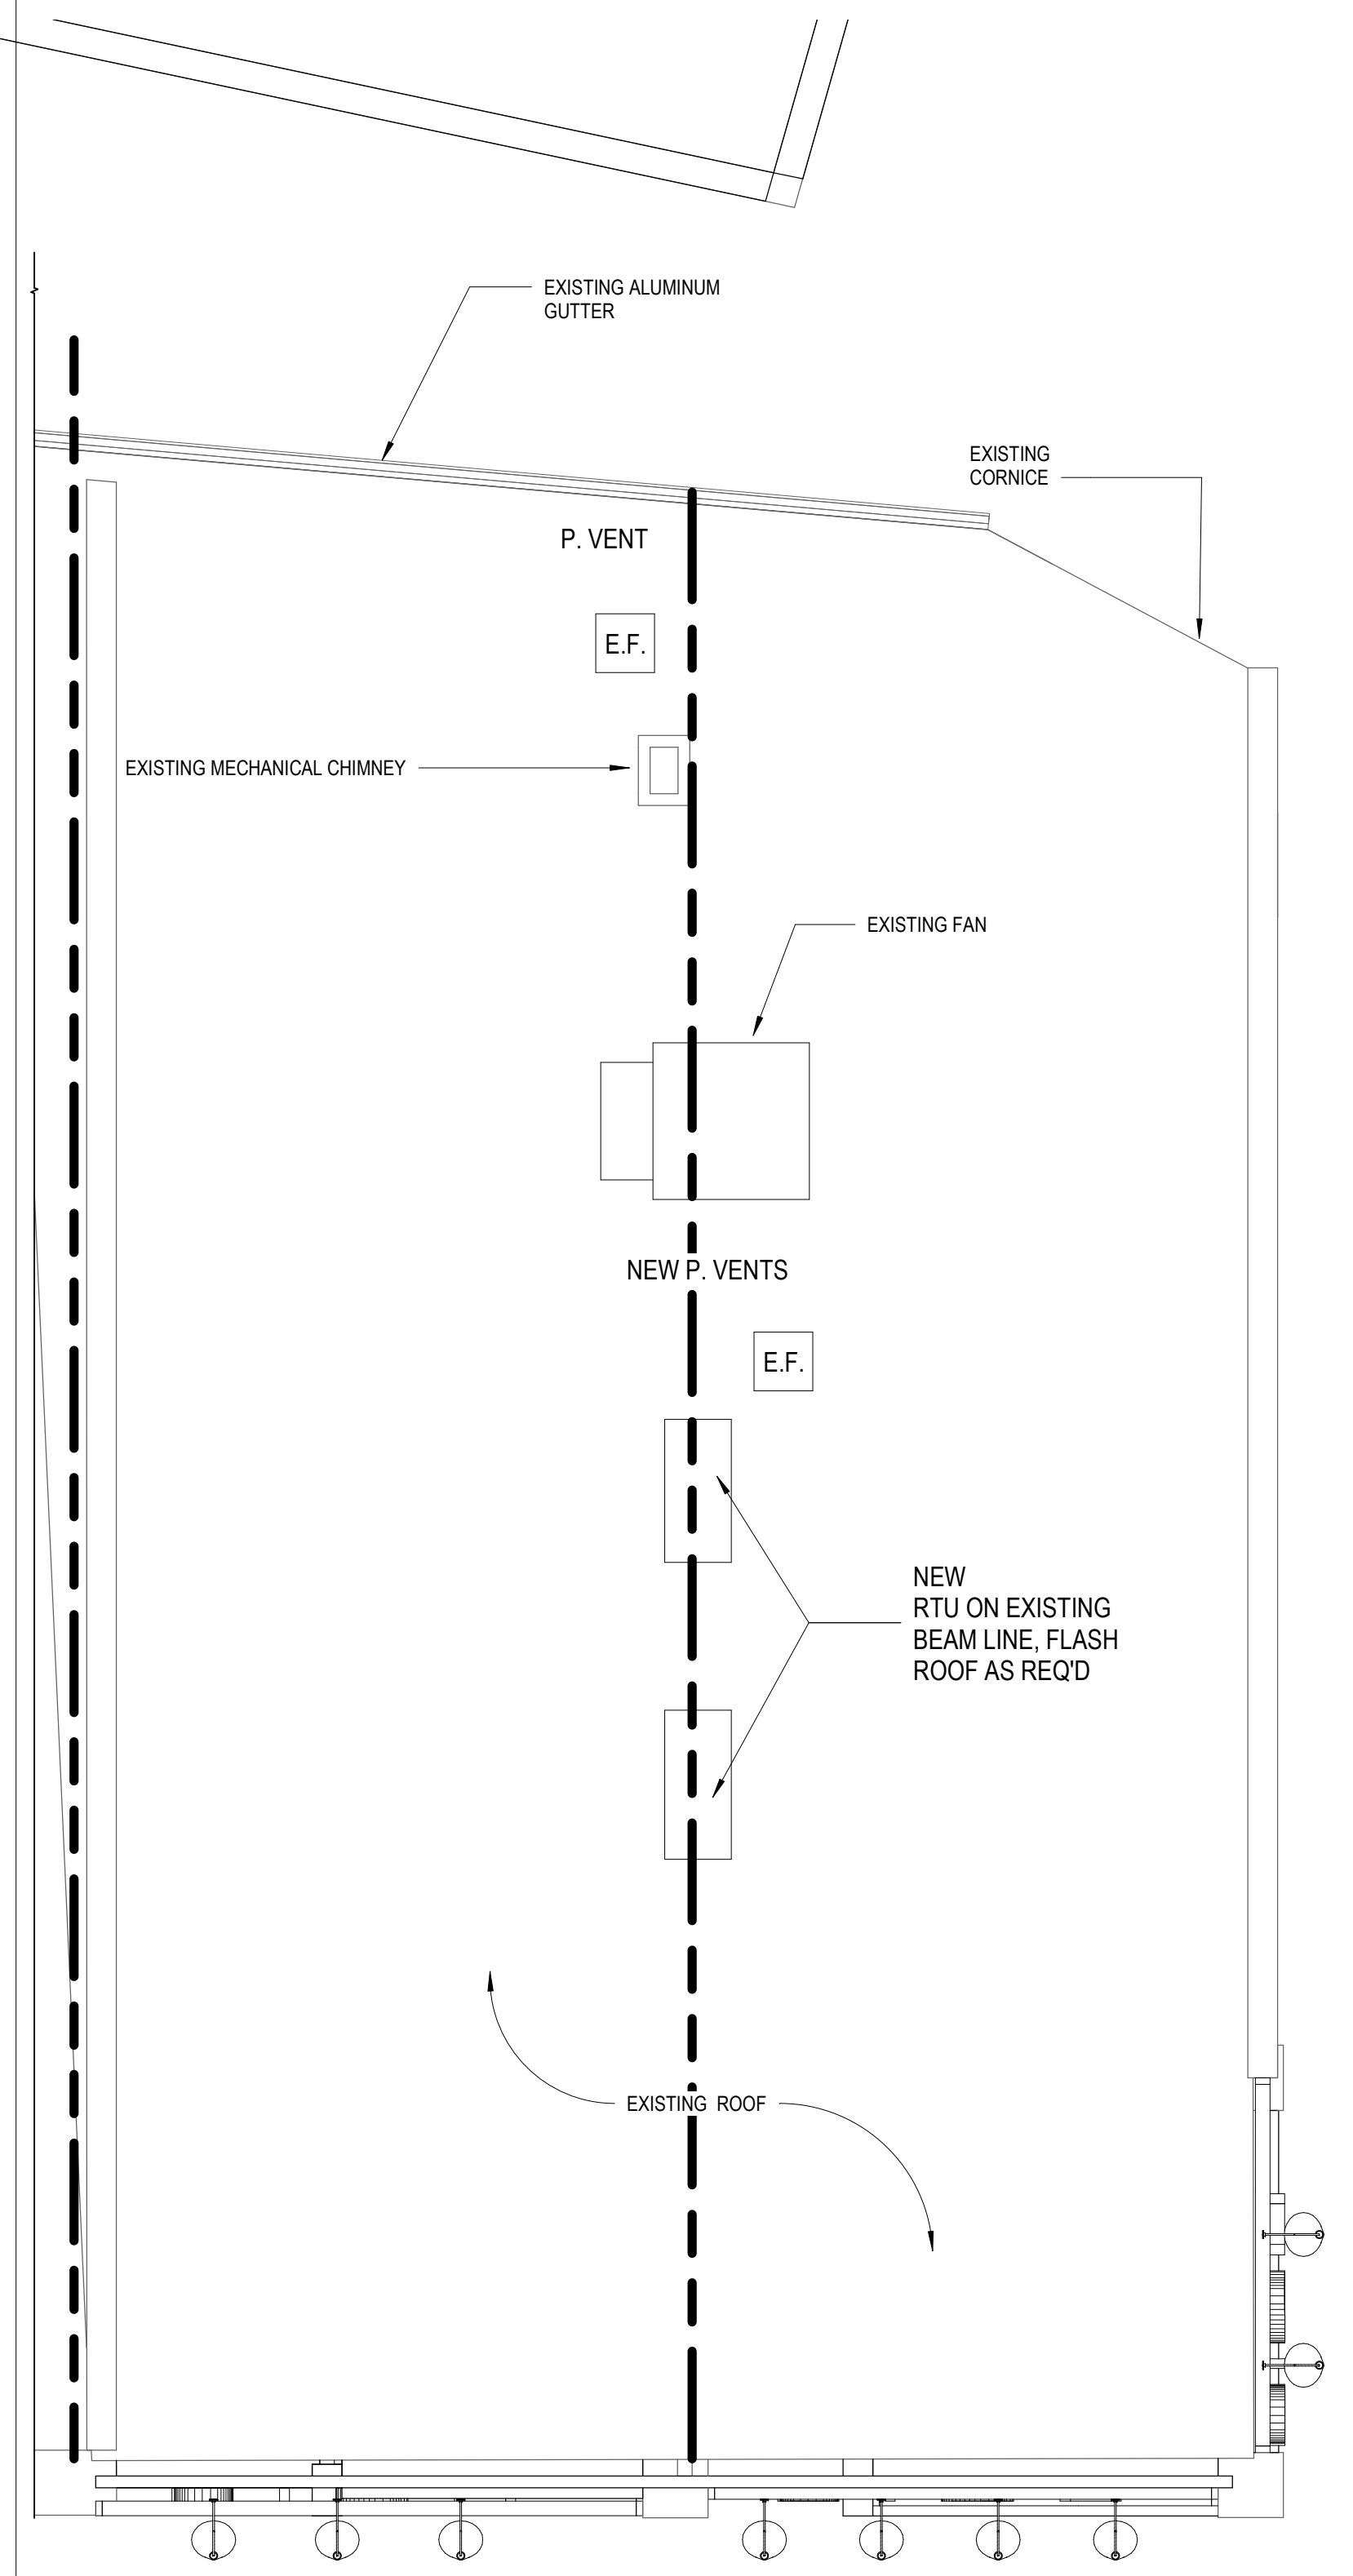

2 First Floor Plan (Proposed)  
 1/4" = 1'-0"

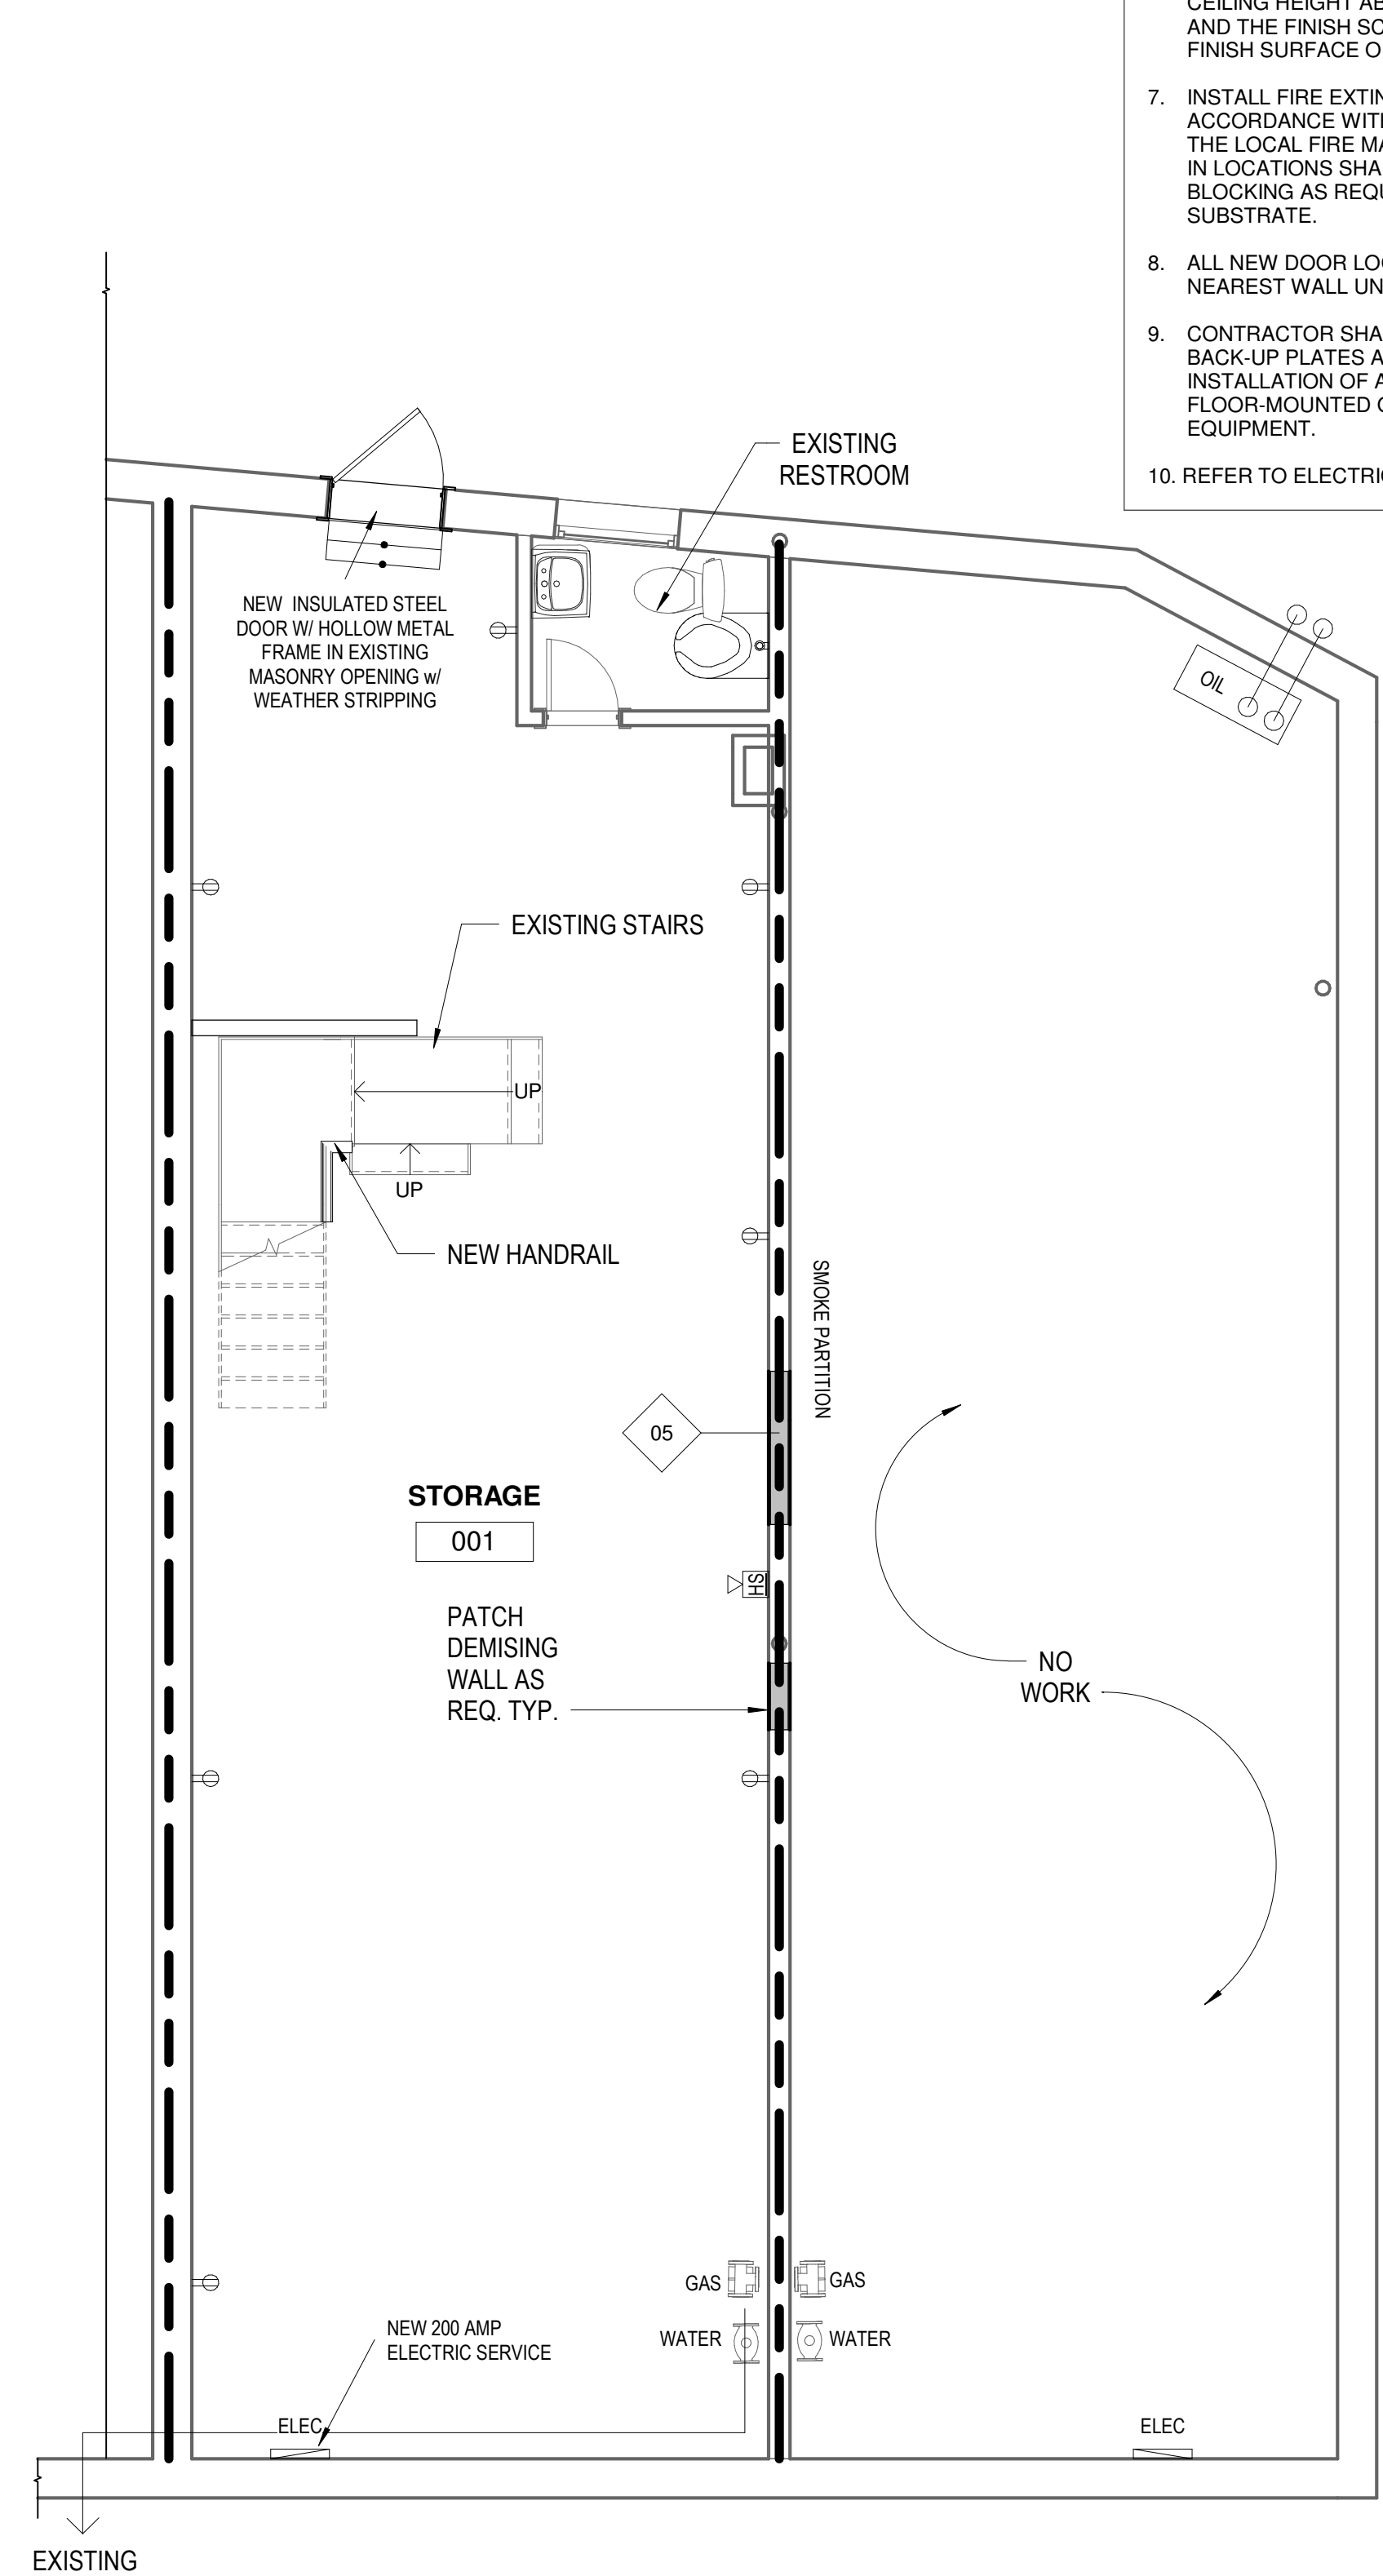

1 Basement Floor Plan (Proposed)  
 1/4" = 1'-0"

12/16/2019 8:53:08 AM


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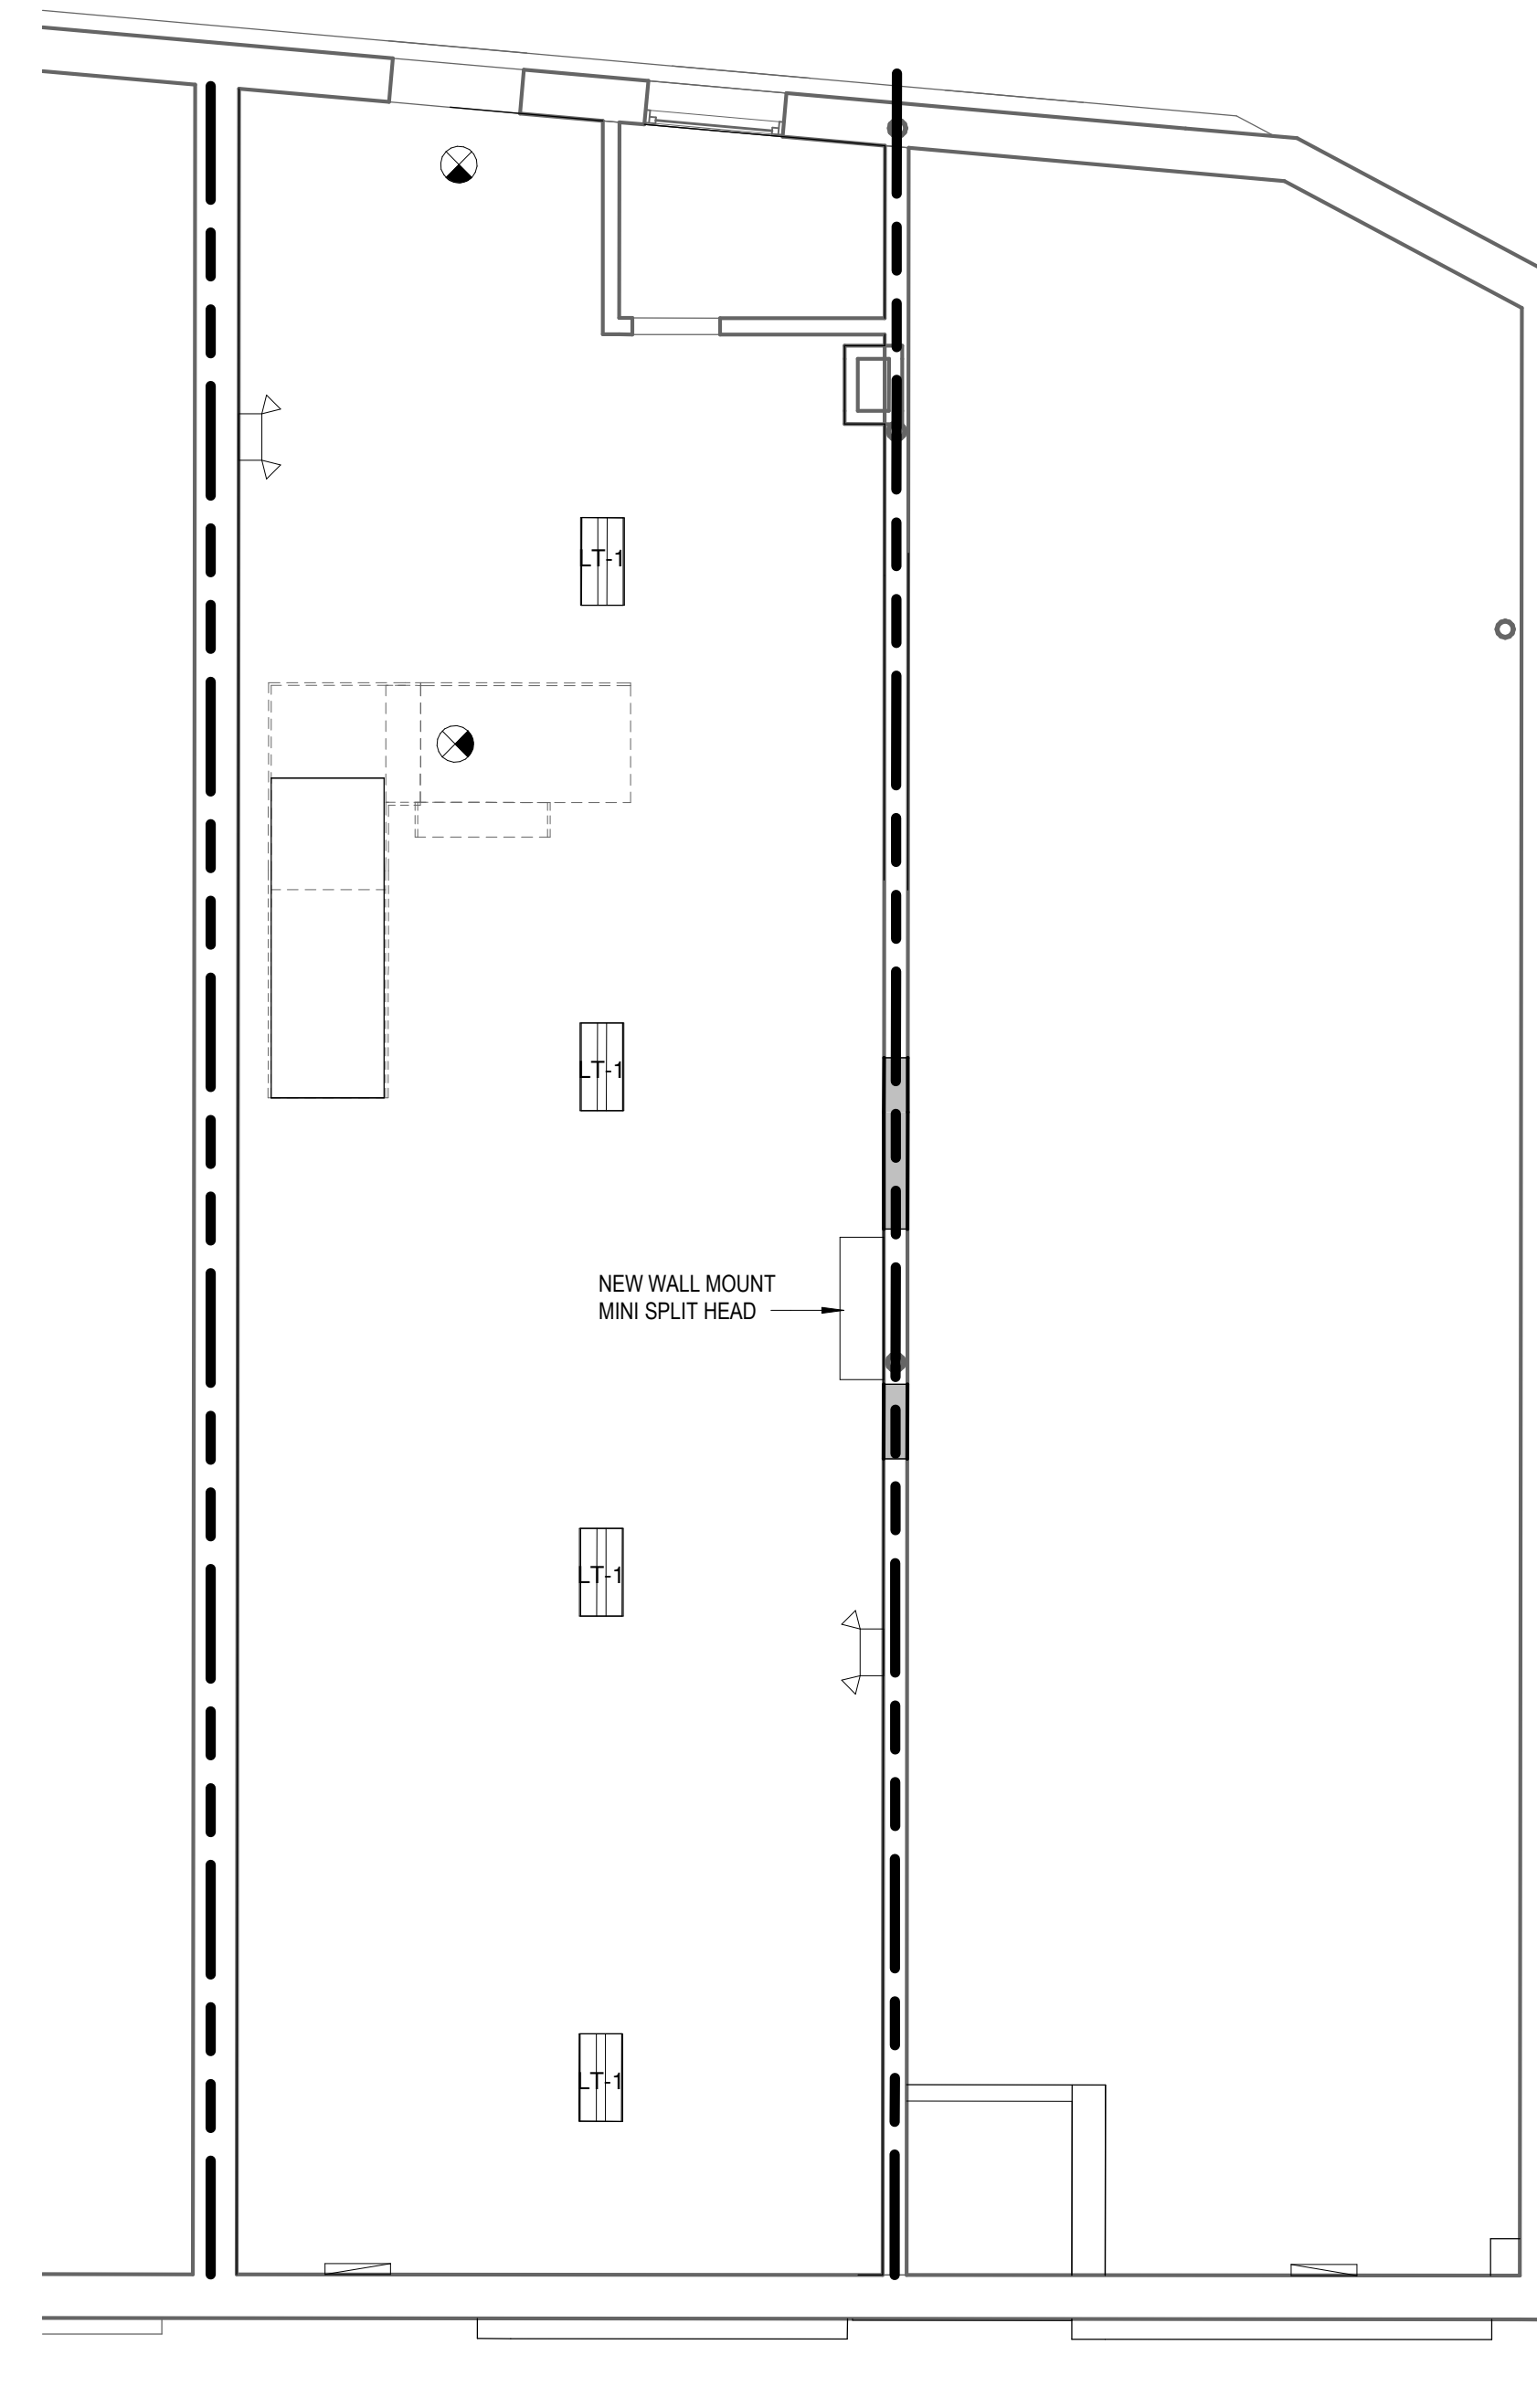
**LIFE SAFETY LEGEND**

	Emergency Light
	Emergency Pull Handle
	Horn Alarm
	Horn/Strobe Alarm
	Exit Sign


- PARTITION TYPES GENERAL NOTES**
- UNLESS OTHERWISE NOTED, ALL PARTITIONS SHALL BE TYPE 02A. ALL EXISTING PARTITIONS SHALL BE VERIFIED BY GC THAT THEY EXTEND TO THE UNDERSIDE OF STRUCTURE ABOVE.
  - UNLESS OTHERWISE NOTED, ALL NEW PARTITIONS RUN TO UNDERSIDE OF DECK ABOVE. FRAME NEW PARTITIONS AROUND OPEN WEB JOISTS TO DECK ABOVE.
  - TOILET ROOMS ARE TO HAVE CEMENTITIOUS BOARD UNDER ALL TILE AND MOISTURE RESISTANT BOARD IN ALL OTHER AREAS. IF A PARTITION TYPE CALLS FOR MULTI-LAYERS OF BOARD, ADDITIONAL LAYERS SHALL BE MOISTURE RESISTANT. WALLS WHERE ONLY A TILE BASE IS TO BE INSTALLED SHALL BE MOISTURE RESISTANT BOARD I.L.O CEMENTITIOUS BOARD.
  - ALL SPACES SHALL HAVE PARTITIONS WITH SOUND ATTENUATION BATTS. REFER TO PARTITION TYPES.
  - IN PARTITIONS, WHERE SOUND ATTENUATION BATTS ARE REQUIRED, ACOUSTIC SEALANT SHALL BE INSTALLED BETWEEN GWB AND STRUCTURE, TOP AND BOTTOM, AND AT ALL PENETRATIONS. THE INTENT IS TO PROVIDE A COMPLETE ACOUSTIC SEAL FOR THE ROOM.
  - ALL JOINTS SHALL BE TAPED AND COVERED WITH JOINT COMPOUND. ALL SCREW HEADS SHALL BE COVERED WITH JOINT COMPOUND.
  - ALL PARTITIONS SHALL HAVE SLIP TRACKS WHERE STUDS ARE ATTACHED TO THE UNDERSIDE OF THE ROOF, FLOOR AND/OR SUPPORTING STRUCTURE.
  - STUDS TO BE 25 MSG CORROSION PROTECTED STEEL @ 16" O.C., CUT 3/8" TO 3/4" LESS THAN ASSEMBLY HEIGHT. RUNNER CHANNELS TO BE 25 MSG CORROSION PROTECTED STEEL TOP & BOTTOM FASTENED @ 24" O.C. MAX.
  - REFER TO UNDERWRITERS LABORATORIES, INC. FOR ADDITIONAL INFORMATION AND REQUIREMENTS ON RATED PARTITIONS.
  - SMOKE PARTITIONS TO BE CAULKED AT JOINTS TO DISIMILAR MATERIALS.




④ 01 - First Floor RCP  
 1/4" = 1'-0"

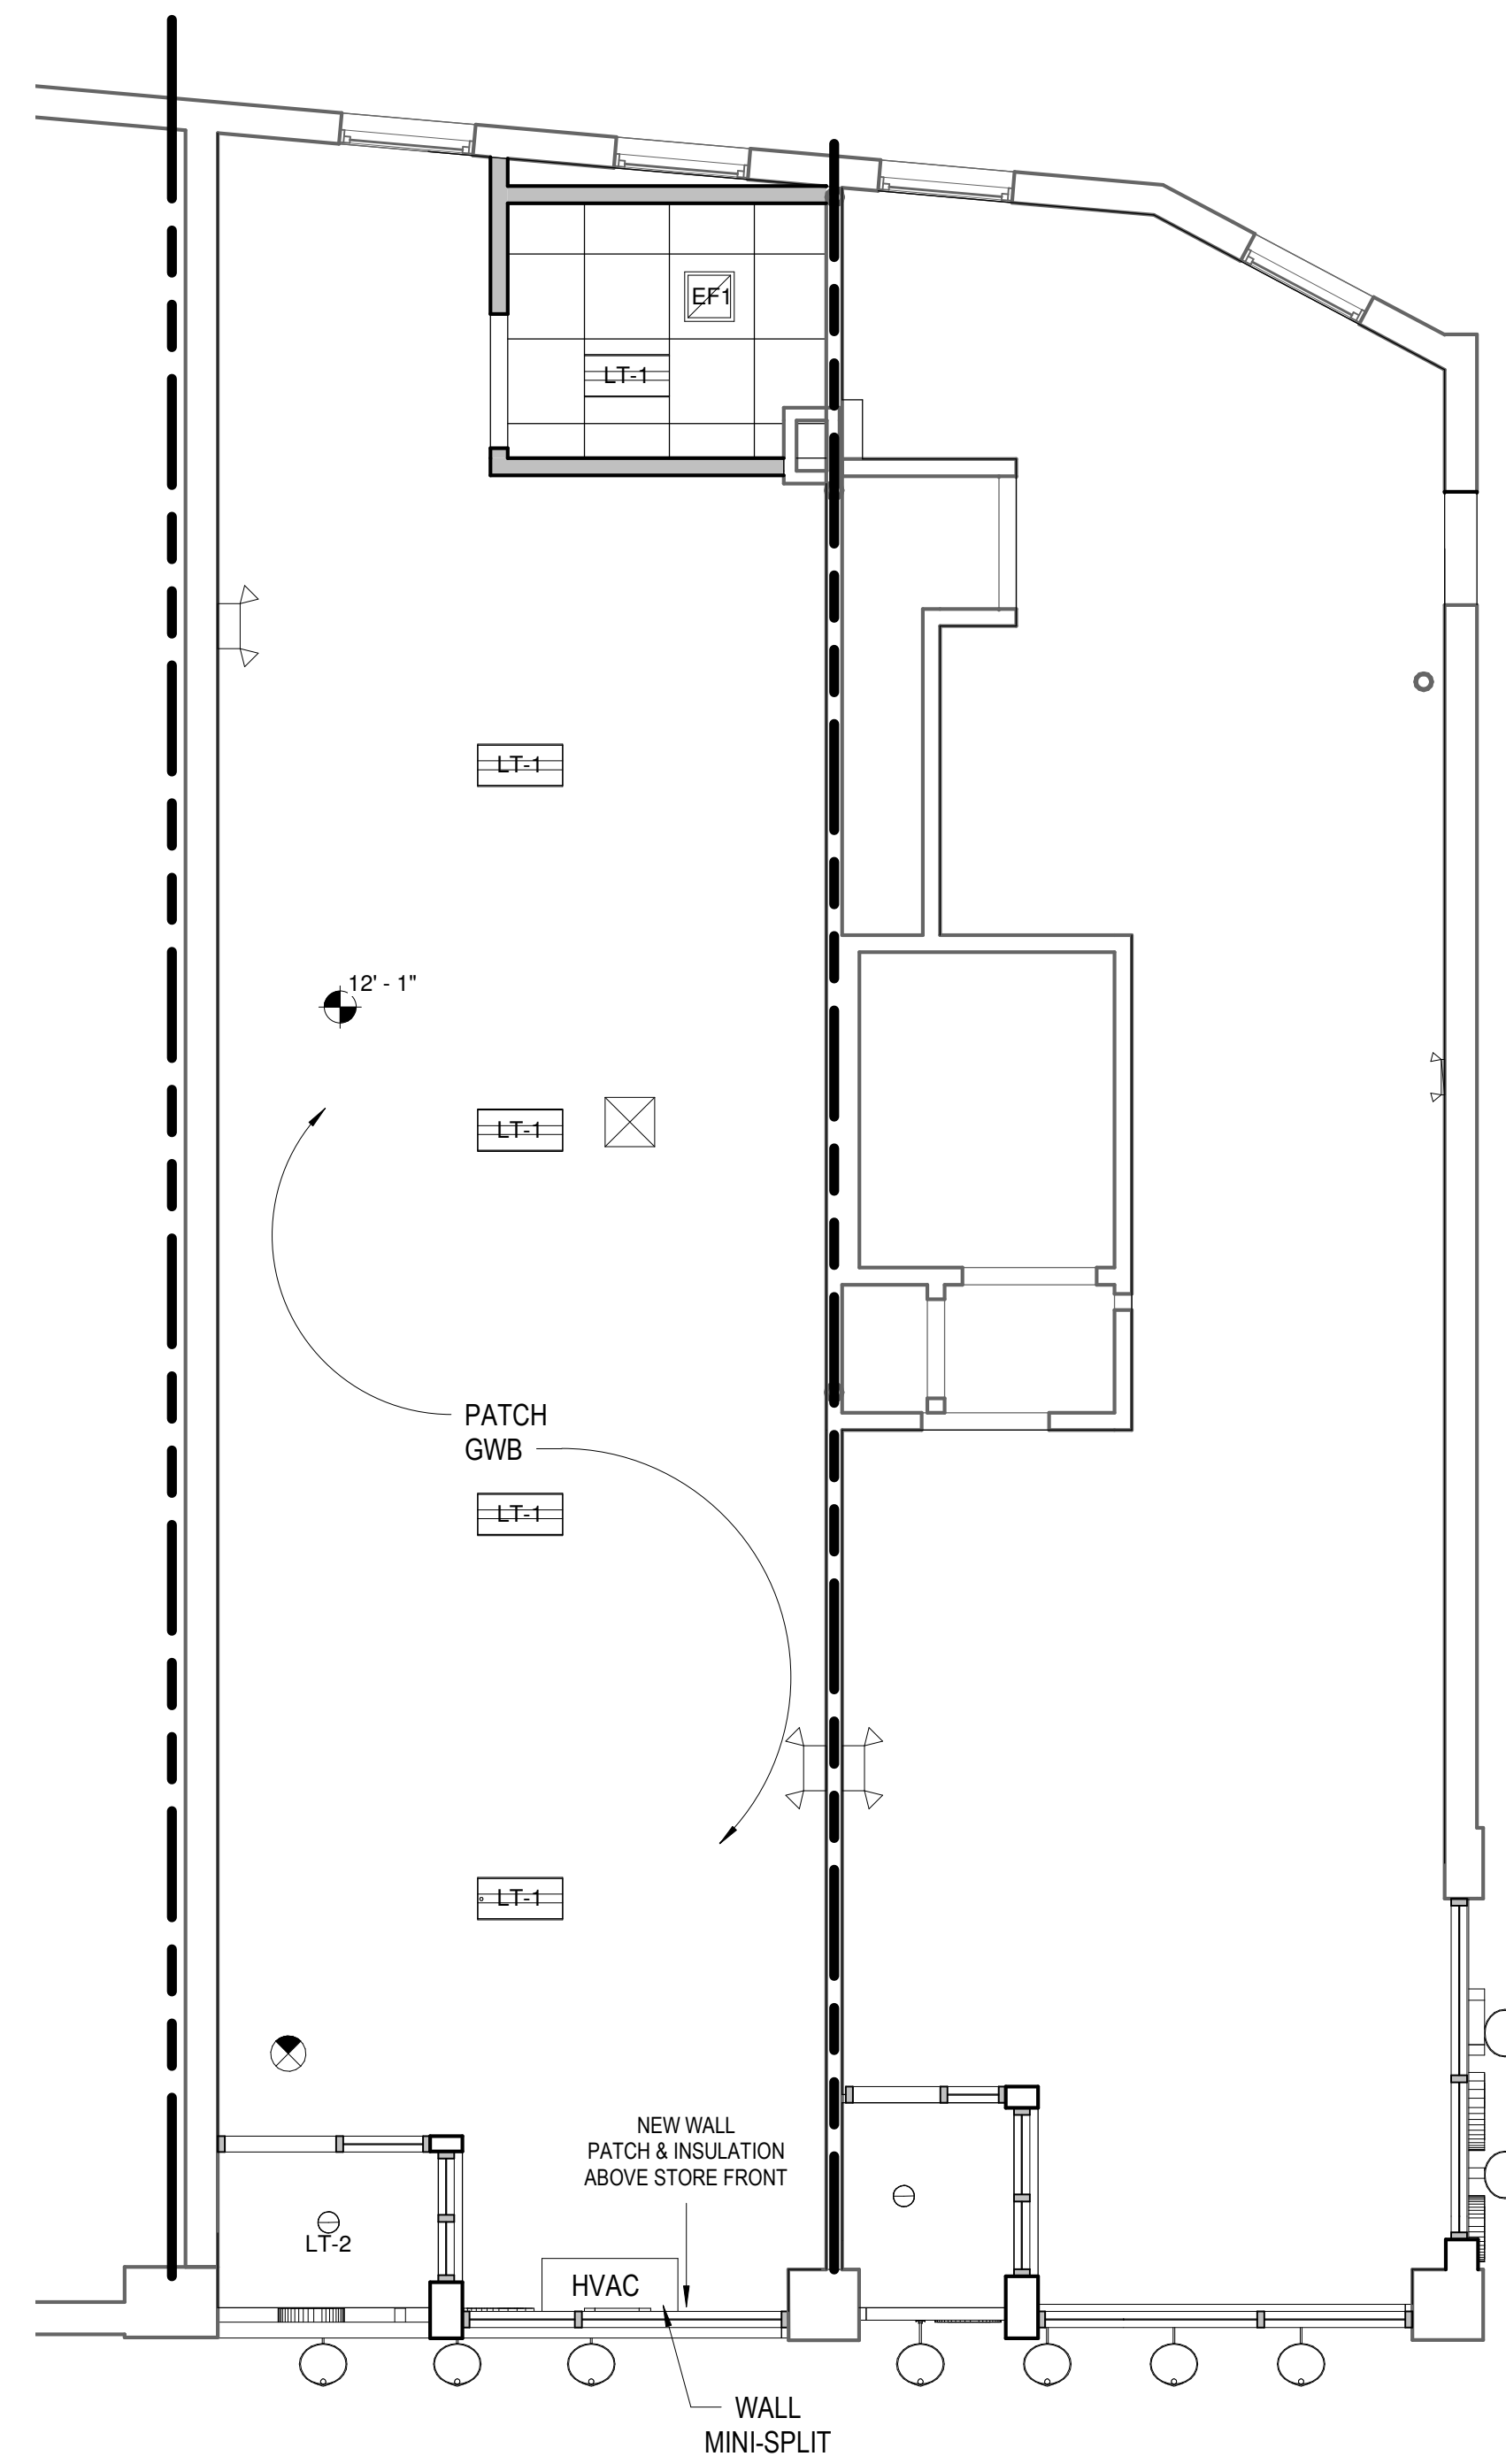


③ 00 - Basement RCP  
 1/4" = 1'-0"

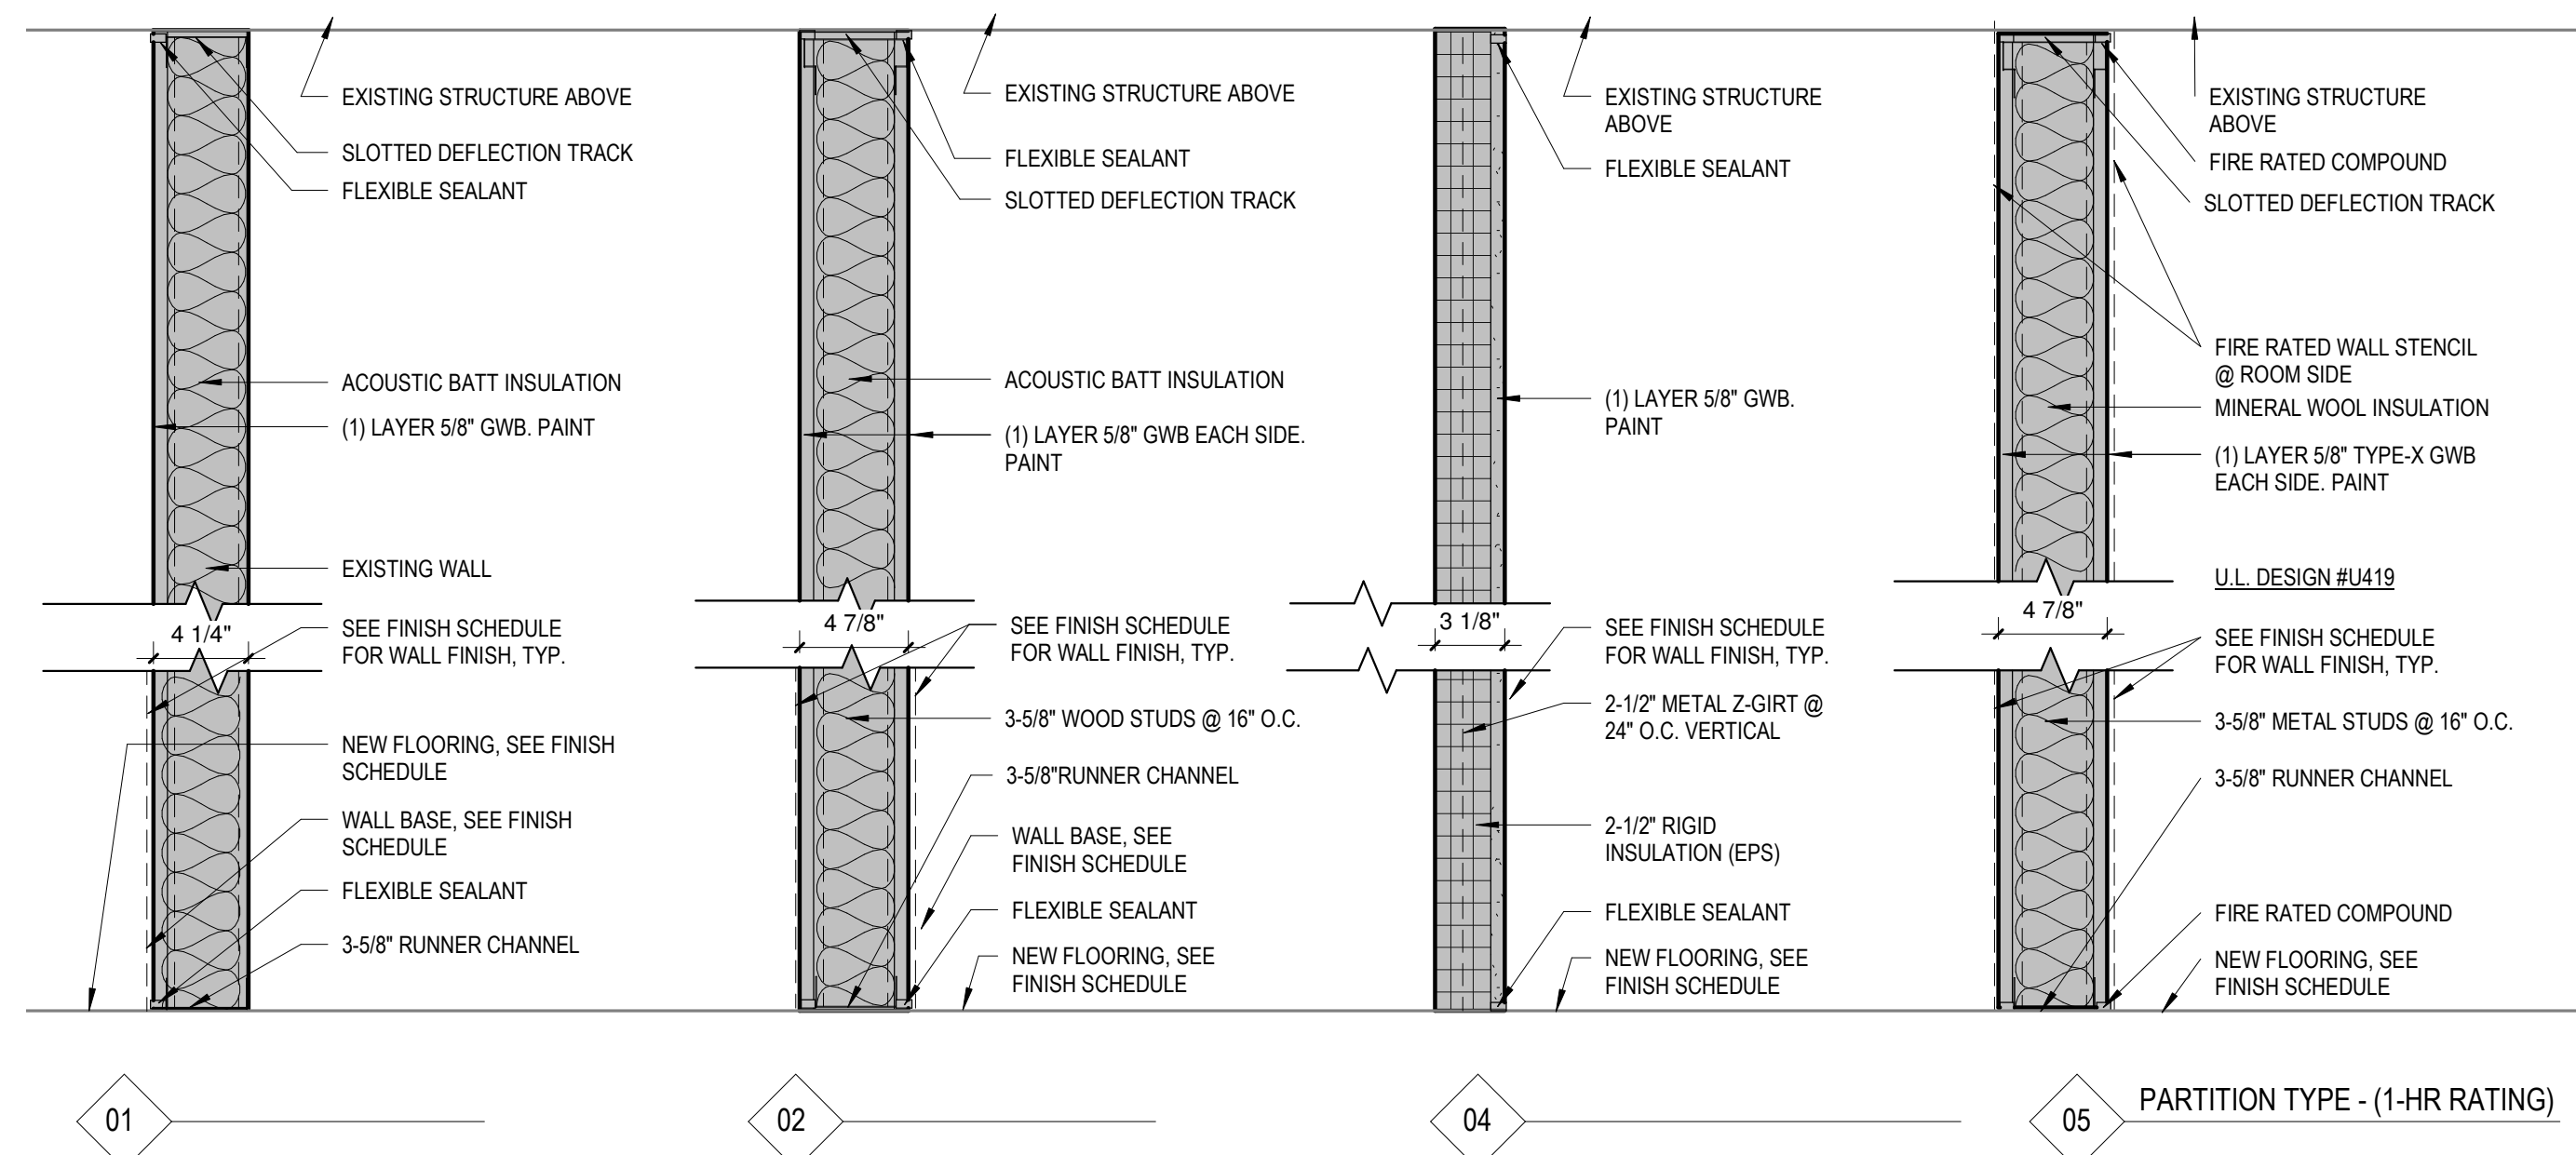


- PARTITION SPECIFICATIONS**
- BOARD-TYPE INSULATION AT EXTERIOR WALLS  
 A. Extruded-Polystyrene Board Insulation. Comply with ASTM C 578, Type X.  
 1. Manufacturer: Foamular 250 by Owens Corning or equal.  
 2. Compressive Strength, ASTM C 578: 15 pounds per square inch, minimum.  
 3. Thickness: 2 1/2" unless otherwise noted on the drawings.  
 4. Board Edge: Square.
  - SOUND ATTENUATION BATTS  
 A. Unfaced glass fiber acoustical insulation complying with ASTM C 665, Type I.  
 1. Manufacturer: Sound Attenuation Batts by Owens Corning or Equal.  
 2. Thickness: Varies, refer to drawings.

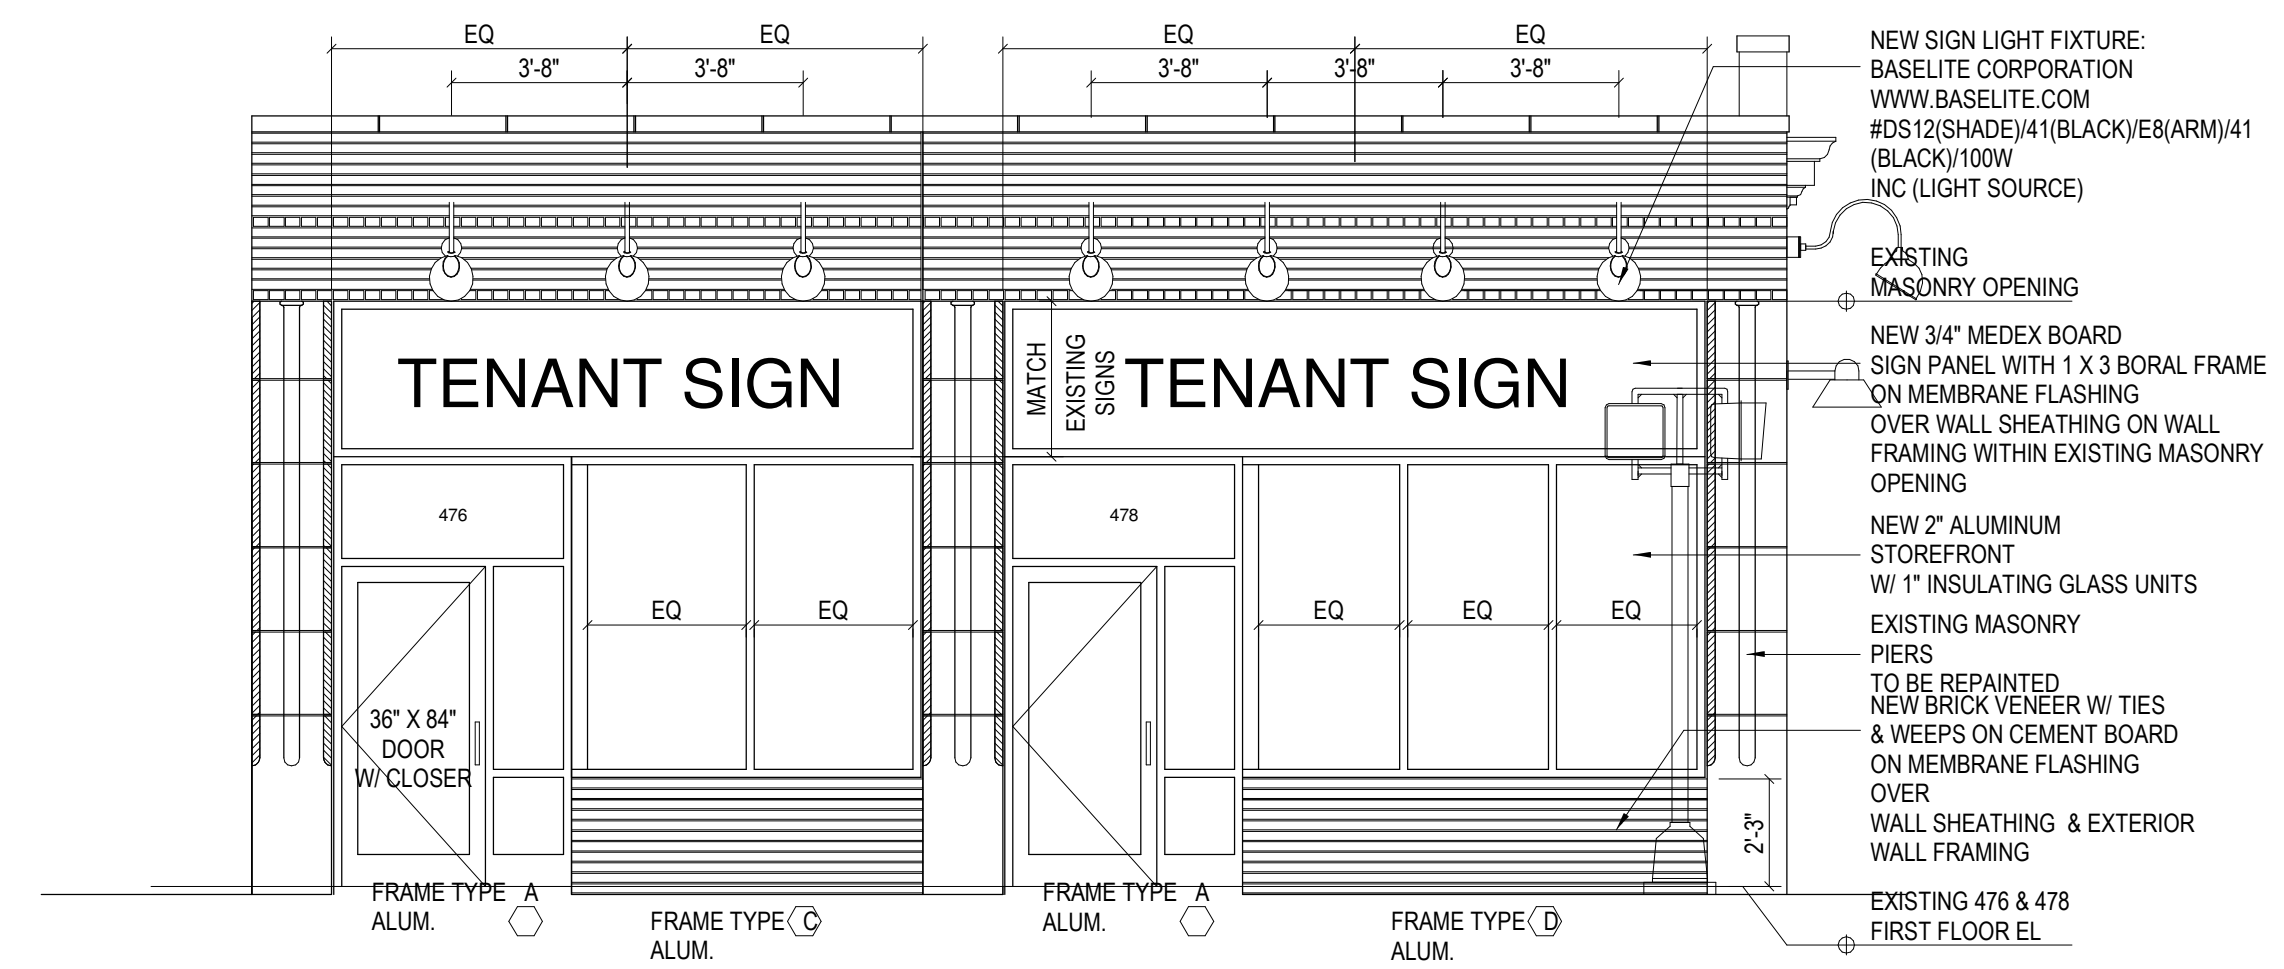


1 MASSACHUSETTS AVE (FRONT) ELEVATION

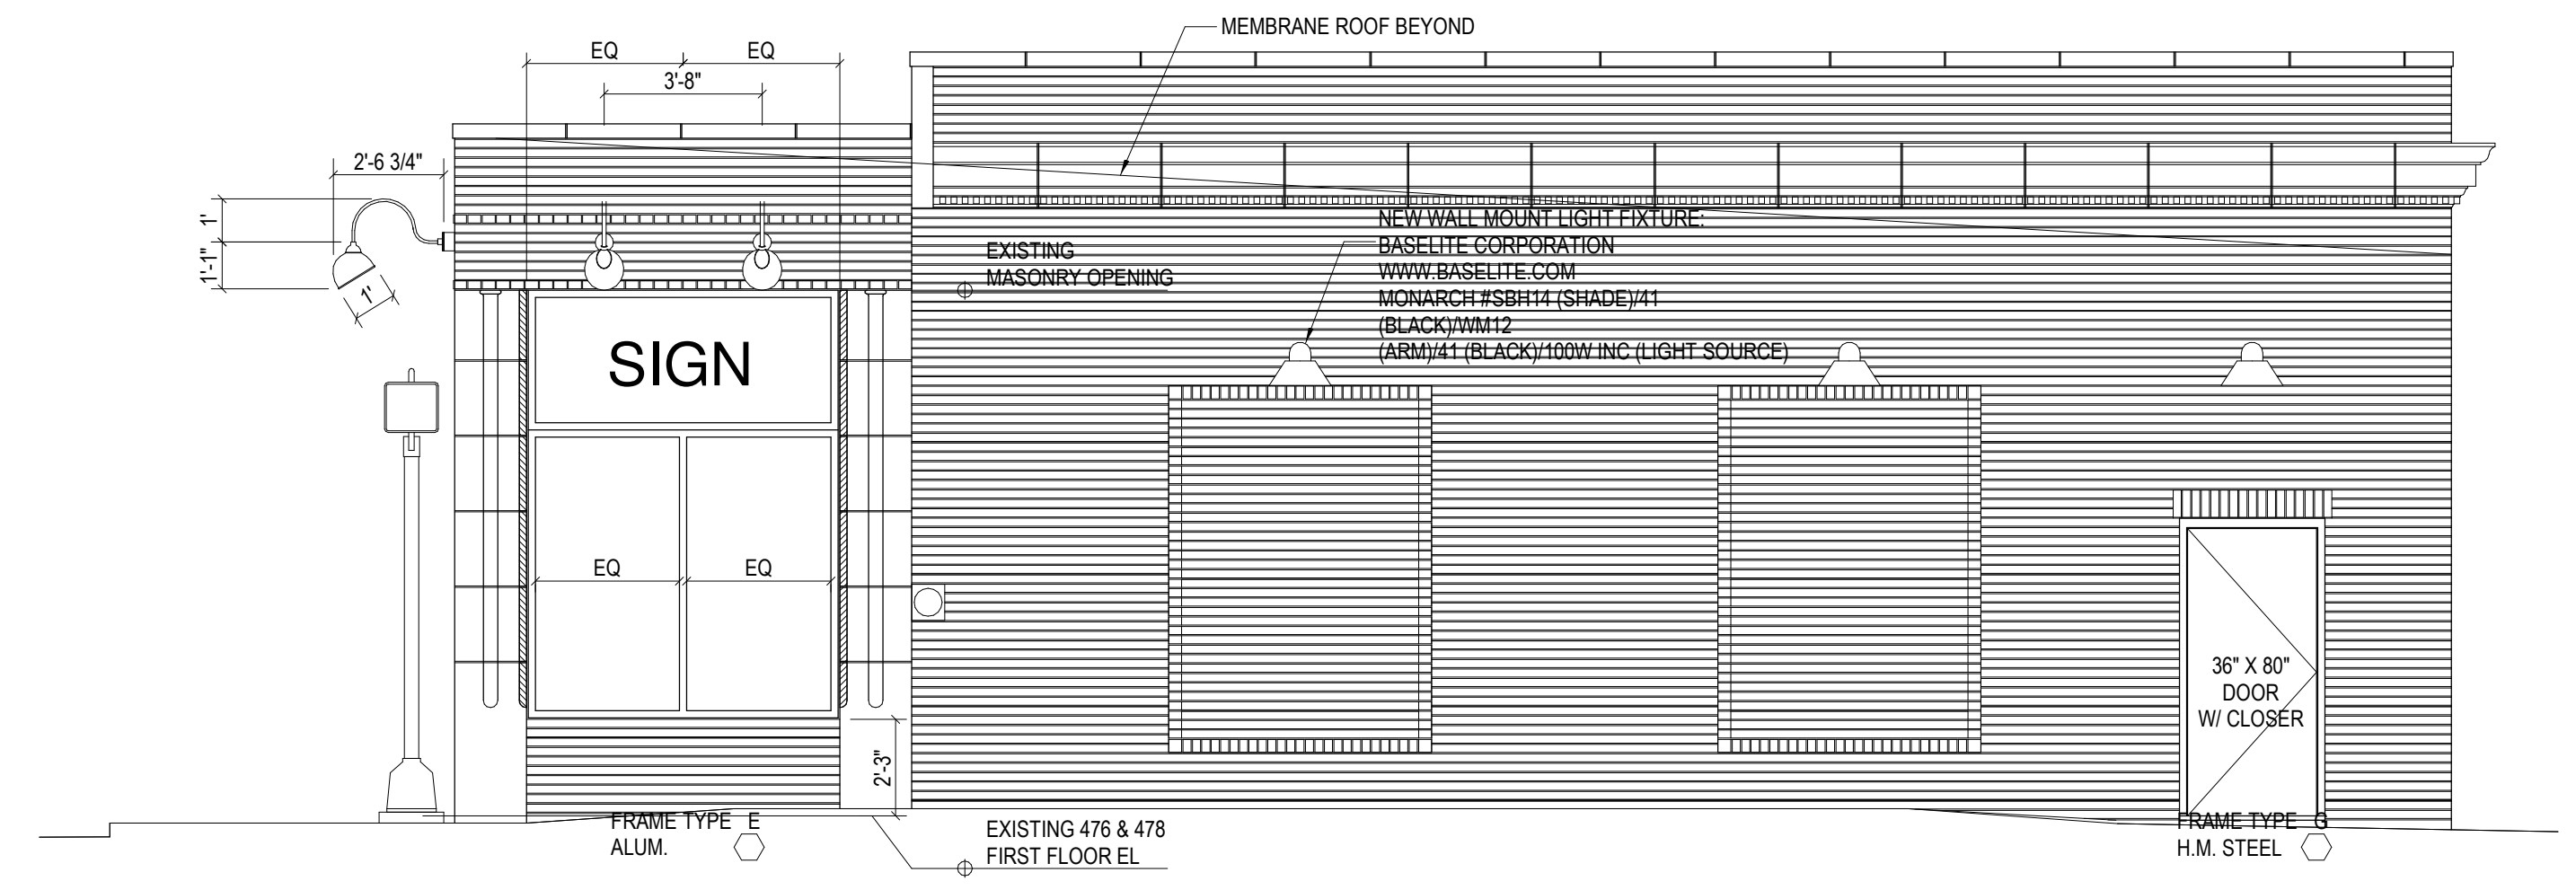


2 SWAN PLACE (RIGHT SIDE) ELEVATION

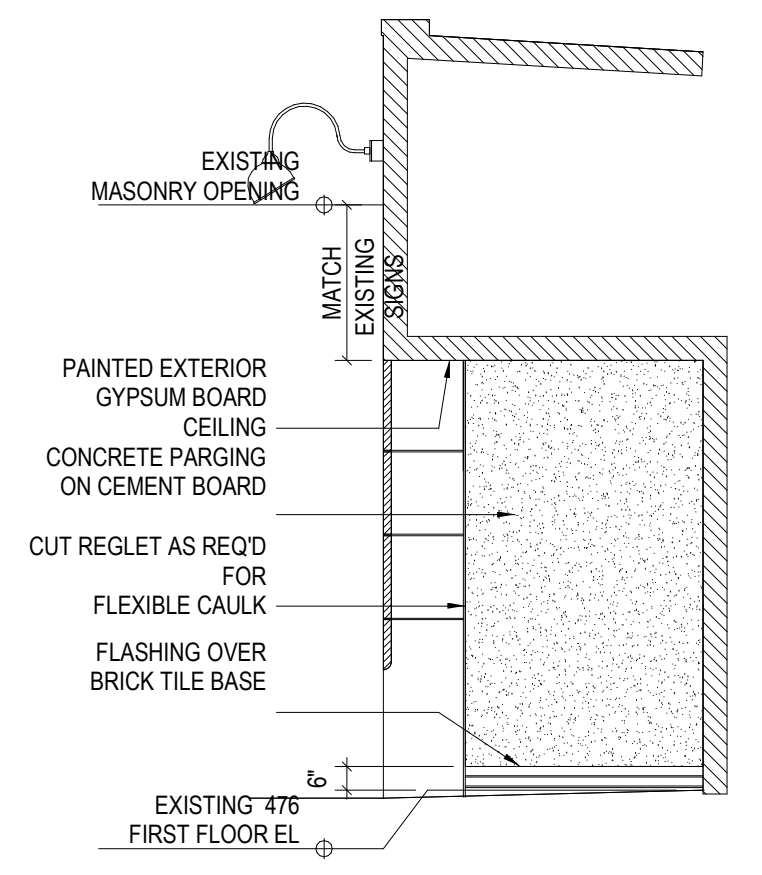


3 478 RECESSED ENTRANCE

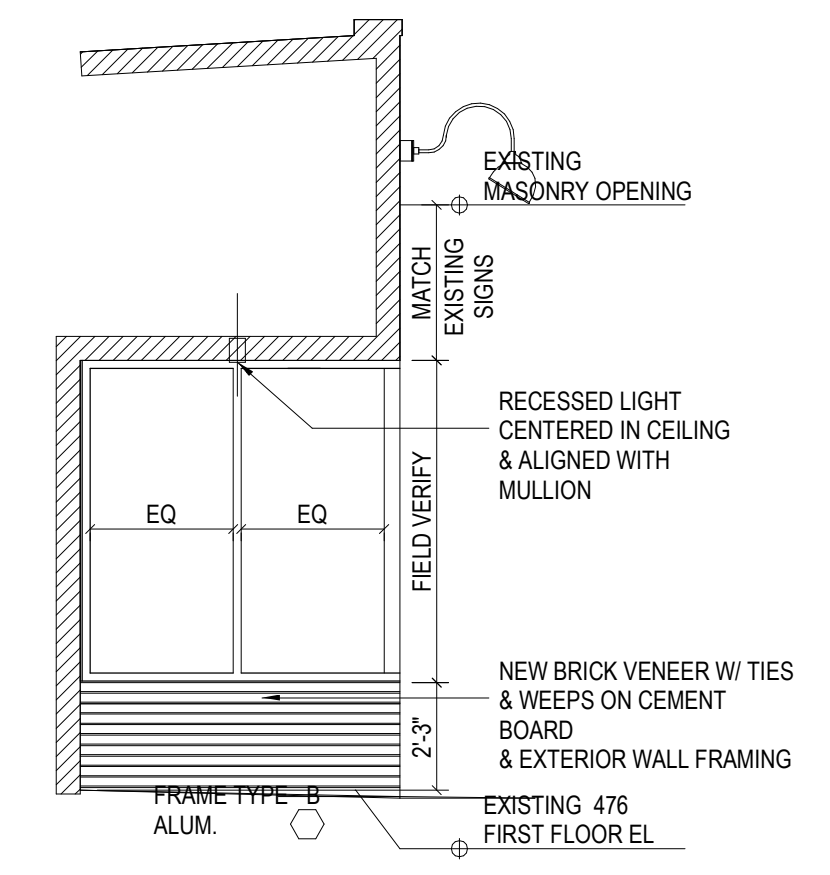


4 478 RECESSED ENTRANCE

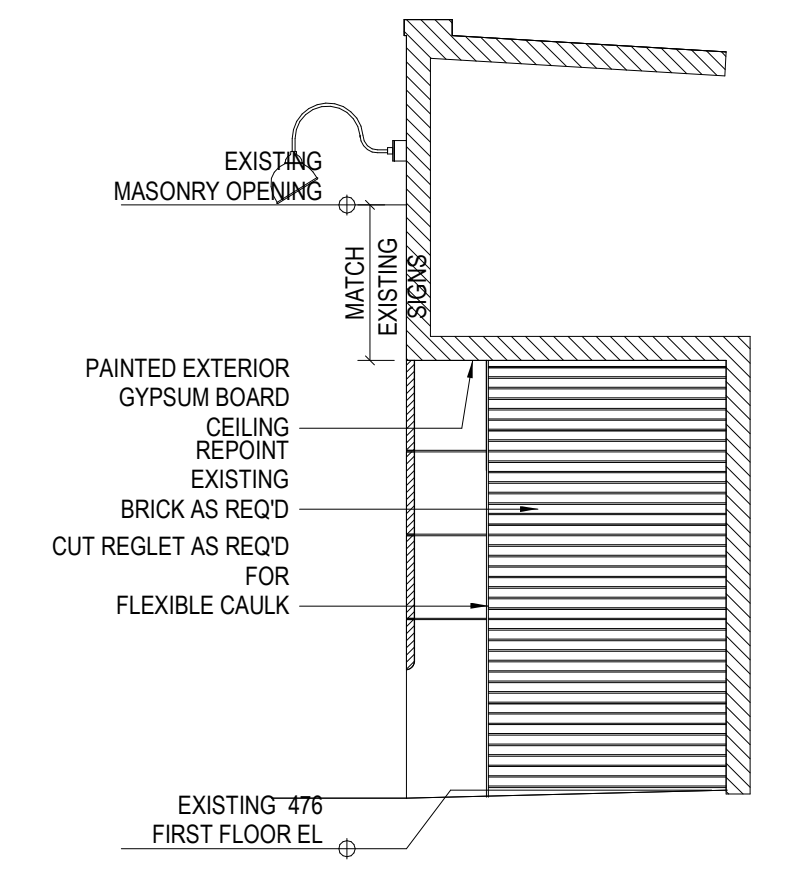

5 476 RECESSED ENTRANCE

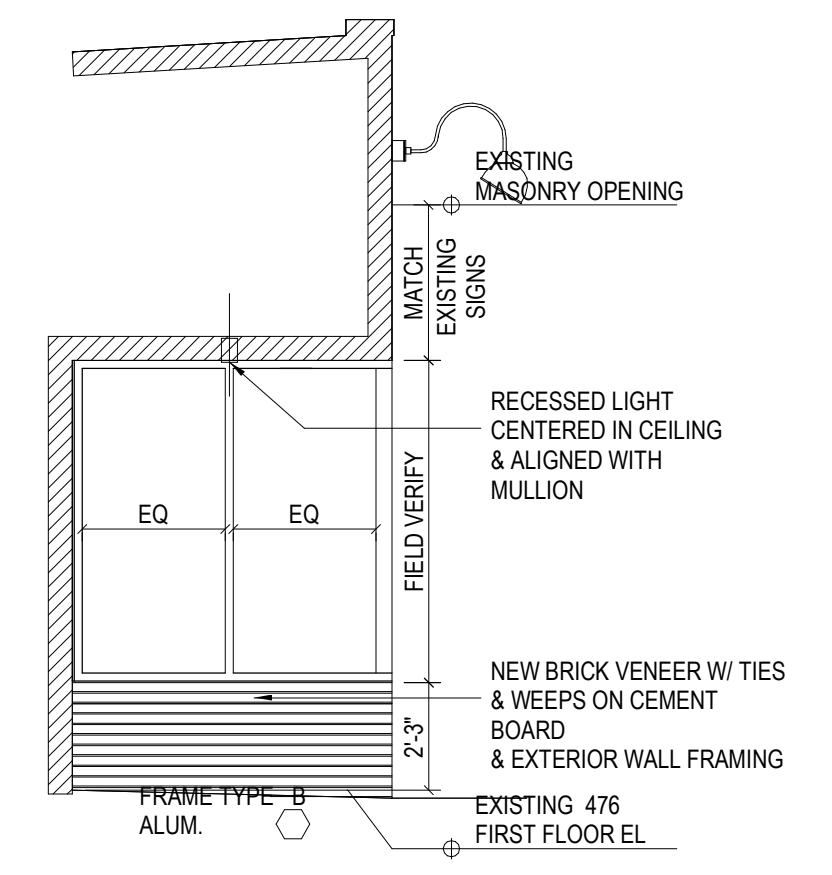

6 476 RECESSED ENTRANCE

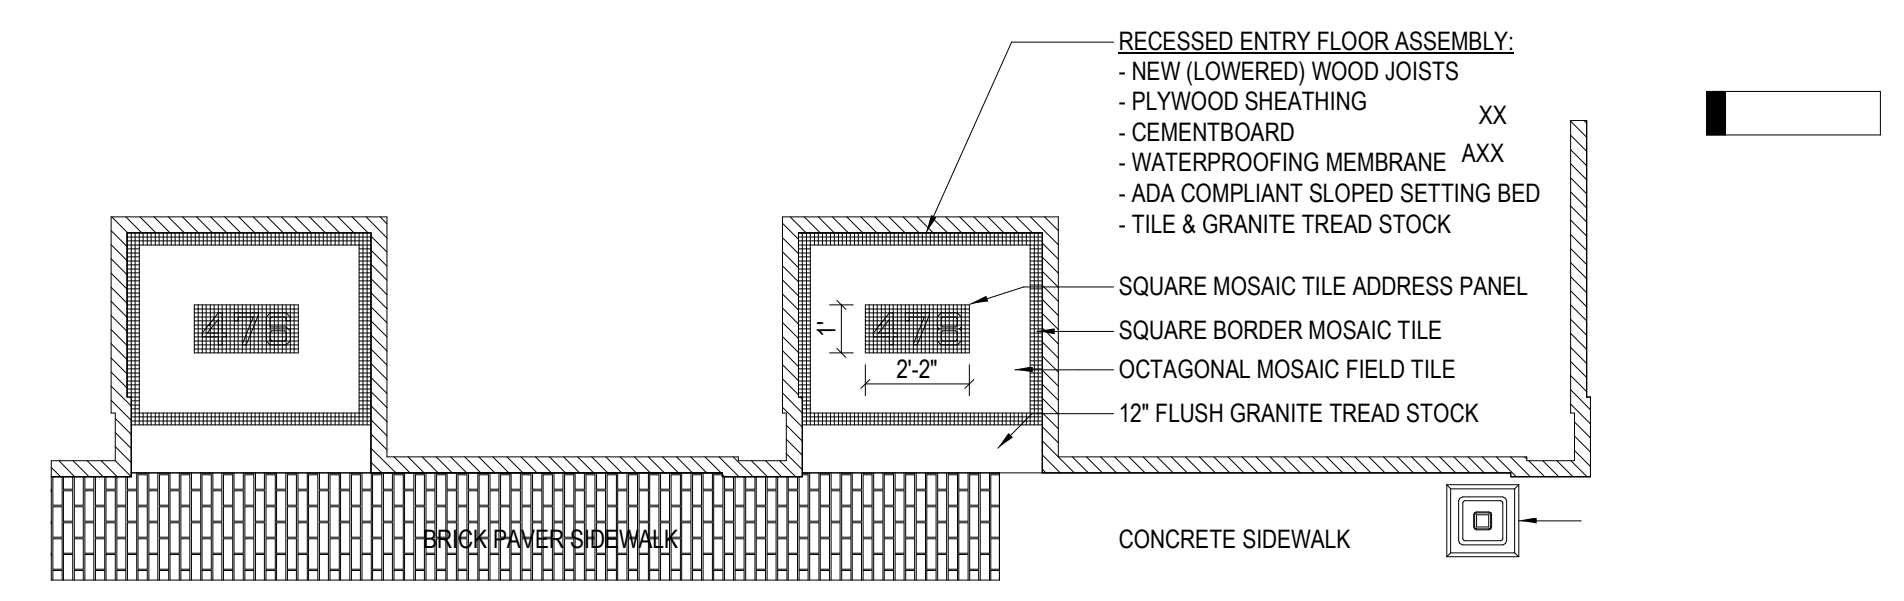

7 STOREFRONT ENTRY TILE PATTERN PLAN

PROJECT NAME  
**476 Massachusetts Ave**  
 PERMIT SET

#	Date	Description



SHEET NAME  
**Elevations**

SHEET ISSUED: 12/12/2019  
 SCALE: 1/4" = 1'-0"  
 DRAWN BY:  
 PROJECT #: 2018-40A

SHEET NUMBER  
**A3.0**