## TOWN OF ARLINGTON REDEVELOPMENT BOARD

PLANNING & COMMUNITY
DEVELOPMENT

Application for Special Permit In Accordance with Environmental Design 007 23 A 9: 24 Review Procedures (Section 3.4 of the Zoning Bylaw Docket No. Property Address: 10 Sunnyside Avenue, Arlington, MA 02474 Phone: 781-646-4911 Name of Record Owner(s): 10 Sunnyside Ave LLC Arlington, MA 02474 Address of Owner: 10 Sunnyside Avenue, Street City, State, ZIP 2. Name of Applicant(s) (if different than above): Chris Cormier Address: c/o Robert J. Annese, 1171 Massachusetts Ave., Arlington, MA 02476 Phone: 781-646-4911 Status Relative to Property (occupant, purchaser, etc.): Owner under agreement 3. Location of Property: 033.0-0002-0002.B Assessor's Block Plan, Block, Lot No. 4. Deed recorded in the Middlesex South District Registry of Deeds, Book 71763, Page 163; or-registered in Land Registration Office, Cert. No\_\_\_\_\_\_, Book \_\_\_\_\_, Page \_\_\_\_\_ 5. Present Use of Property (include # of dwelling units, if any): automotive garage & repair facility 6. Proposed Use of Property (include # of dwelling units, if any): mixed use residential; 26 residential units as well as one unit of retail space 7. Environmental Design Review Permit applied for in Section 3.4 Mixed Use Section 5.5 -B4 accordance with the Table of Off Street Parking Regulations Section 6.1 following Zoning Bylaw section(s): 8. Please attach a statement that describes your project and provide any additional information that may aid the ARB in understanding the permits you request. Include any reasons that you feel you should be granted the requested permission. See attached Statement incorporated by reference into the terms of this Application. (In the statement below, strike out the words that do not apply) The applicant states that it is the owner-or-occupant-or-purchaser under agreement of the property in Arlington located at 10 Sunnyside Avenue, Arlington which is the subject of this application; and that unfavorable action -or- no unfavorable action has been taken by the Zoning Board of Appeals on a similar application regarding this property within the last two years. The applicant expressly agrees to comply with any and all conditions and qualifications imposed upon this permission, either by the Zoning Bylaw or by the Redevelopment Board, should the permit be granted.

Signature of Applicant(s)
Chris Cormier

c/o Robert J. Annese, 1171 Mass Ave., Arlington, MA 02476

Address

781-646-4911

Phone

## Town of Arlington Redevelopment Board Application for Special Permit in accordance with Environmental Design Review (Section 3.4)

## Required Submittals Checklist

File each in triplicate except for model References are to Arlington Zoning Bylaw

$\checkmark$	Dimensional and Parking Information Form	
$\sqrt{}$	Site plan of proposal	
X	Model, if required	
$\sqrt{}$	Drawing of proposed structure	
$\sqrt{}$	Proposed landscaping. May be incorporated into site plan	
$\sqrt{}$	Photographs	
$\sqrt{}$	Impact statement	
$\sqrt{}$	Application and plans for sign permits	
√	Stormwater management plan (for stormwater management with new construction)	t during construction for projects
FOR (	OFFICE USE ONLY	
	Special Permit Granted	Date:
	Received evidence of filing with Registry of Deeds	Date:
F.7.	Notified Building Inspector of Special Permit filing	Date: 16/26/18

## TOWN OF ARLINGTON REDEVELOPMENT BOARD

Petition for Special Permit under Environmental Design Review (see Section 3.4 of the Arlington Zoning Bylaw for Applicability)

For projects subject to Environmental Design Review, (see section 3.4), please submit a statement that completely describes your proposal, and addresses each of the following standards.

- 1. **Preservation of Landscape**. The landscape shall be preserved in its natural state, insofar as practicable, by minimizing tree and soil removal, and any grade changes shall be in keeping with the general appearance of neighboring developed areas.
  - Currently the existing site is a one story structure surrounded by old pavement for parking along with a chain-link fence securing the property. There is currently very little to no landscaping or plantings. The new proposal will incorporate new plantings, trees and green open space to the site.
- 2. **Relation of Buildings to Environment**. Proposed development shall be related harmoniously to the terrain and to the use, scale, and architecture of existing buildings in the vicinity that have functional or visual relationship to the proposed buildings. The Arlington Redevelopment Board may require a modification in massing so as to reduce the effect of shadows on abutting property in an RU, RI or R2 district or on public open space.
  - The building which abuts the site on the left side of the property is a 3 story brick commercial building. One the right side, the abutting structure is a two story masonry commercial garage. Further down Sunnyside Avenue are a mixture of single and multifamily dwellings.
- 3. **Open Space**. All open space (landscaped and usable) shall be so designed as to add to the visual amenities of the vicinity by maximizing its visibility for persons passing the site or overlooking it from nearby properties. The location and configuration of usable open space shall be so designed as to encourage social interaction, maximize its utility, and facilitate maintenance.
  - The current building on the existing site sits approximately 4 feet from the edge of the street so the pavement goes to the edge of the building which does not allow for any landscaping. The new proposal pushes the new building back 15 feet from the sidewalk to allow for green open space at the front of the building as well as side yard setbacks for additional open space on the side of the building.
- 4. **Circulation**. With respect to vehicular, pedestrian and bicycle circulation, including entrances, ramps, walkways, drives, and parking, special attention shall be given to location and number of access points to the public streets (especially in relation to existing traffic controls and mass transit facilities), width of interior drives and access points, general interior circulation, separation of pedestrian and vehicular traffic, access to community facilities, and arrangement of vehicle parking and bicycle parking areas, including bicycle parking spaces required by Section 8.13 that are safe and convenient and, insofar as practicable, do not detract from the use and enjoyment of proposed buildings and structures and the neighboring properties.
  - Circulation within the site has been designed in a way to have the pedestrian / bike traffic at the left side of the site and the vehicular traffic entering and exiting the site on the far right side of the site. Having the pedestrian / bike traffic at the left side of the site keeps the circulation closer to the Broadway intersection as well as the Alewife Greenway Bike Path.

5. **Surface Water Drainage**. Special attention shall be given to proper site surface drainage so that removal of surface waters will not adversely affect neighboring properties or the public storm drainage system. Available Best Management Practices for the site should be employed, and include site planning to minimize impervious surface and reduce clearing and re-grading. Best Management Practices may include erosion control and storm water treatment by means of swales, filters, plantings, roof gardens, native vegetation, and leaching catch basins. Storm water should be treated at least minimally on the development site; that which cannot be handled on site shall be removed from all roofs, canopies, paved and pooling areas and carried away in an underground drainage system. Surface water in all paved areas shall be collected at intervals so that it will not obstruct the flow of vehicular or pedestrian traffic, and will not create puddles in the paved areas.

In accordance with Section 3.3.4, the Board may require from any applicant, after consultation with the Director of Public Works, security satisfactory to the Board to insure the maintenance of all storm water facilities such as catch basins, leaching catch basins, detention basins, swales, etc. within the site. The Board may use funds provided by such security to conduct maintenance that the applicant fails to do. The Board may adjust in its sole discretion the amount and type of financial security such that it is satisfied that the amount is sufficient to provide for the future maintenance needs.

The new proposal brings the new green open space onto the site which will help with natural drainage within the site. The civil engineer will also incorporate additional onsite drainage that will allow the site to manage all the rain runoff with the site itself.

6. **Utility Service**. Electric, telephone, cable TV and other such lines and equipment shall be underground. The proposed method of sanitary sewage disposal and solid waste disposal from all buildings shall be indicated.

All the new utility service will be underground.

7. **Advertising Features**. The size, location, design, color, texture, lighting and materials of all permanent signs and outdoor advertising structures or features shall not detract from the use and enjoyment of proposed buildings and structures and the surrounding properties. Advertising features are subject to the provisions of Section 6.2 of the Zoning Bylaw.

The proposed signage for the residential entry is detailed on drawing A7. The retail signage will be designed at a later date when a future tenant leases the space. All the signage will be done in accordance with the Arlington Bylaws and regulations.

8. **Special Features**. Exposed storage areas, exposed machinery installations, service areas, truck loading areas, utility buildings and structures, and similar accessory areas and structures shall be subject to such setbacks, screen plantings or other screening methods as shall reasonably be required to prevent their being incongruous with the existing or contemplated environment and the surrounding properties.

At this time, there are no special features designed for the project. If one is needed and designed, it would be designed in accordance with the Arlington Bylaws as well as having the proper setbacks and screening required by the Bylaw.

9. **Safety**. With respect to personal safety, all open and enclosed spaces shall be designed to facilitate building evacuation and maximize accessibility by fire, police, and other emergency personnel and equipment. Insofar as practicable, all exterior spaces and interior public and semi-public spaces shall be so designed as to minimize the fear and probability of personal harm or injury by increasing the potential surveillance by neighboring residents and passersby of any accident or attempted criminal act.

The new building design has large setbacks from the property lines giving the site more areas for landscaping, lighting as well as additional security features that will not negatively impact on the abutting neighborhood.

10. **Heritage**. With respect to Arlington's heritage, removal or disruption of historic, traditional or significant uses, structures, or architectural elements shall be minimized insofar as practicable, whether these exist on the site or on adjacent properties.

The existing one story masonry building was built approximately around 1920. The site and building does not appear to be historic or significant to Arlington's Heritage.

Microclimate. With respect to the localized climatic characteristics of a given area, any development which proposes new structures, new hard-surface ground coverage, or the installation of machinery which emits heat, vapor, or fumes, shall endeavor to minimize, insofar as practicable, any adverse impact on light, air, and water resources, or on noise and temperature levels of the immediate environment.

The Applicant's plans have been prepared to deal with minimizing any noise emanating from any air-conditioning or heating system servicing the property and there will be no vapor or fumes generated by the property construction and use.

In addition the building will be constructed in accordance with the plans submitted which comply with the height requirement's contained in the Zoning Bylaws with no significant massing effect which could impact abutting properties.

12. **Sustainable Building and Site Design**. Projects are encouraged to incorporate best practices related to sustainable sites, water efficiency, energy and atmosphere, materials and resources, and indoor environmental quality.

Applicants must submit a current Green Building Council Leadership in Energy and Environmental Design (LEED) checklist, appropriate to the type of development, annotated with narrative description that indicates how the LEED performance objectives will be incorporated into the project.

[LEED checklists can be found at <a href="http://www.usgbc.org/DisplayPage.aspx?CMSPageID=220b">http://www.usgbc.org/DisplayPage.aspx?CMSPageID=220b</a>]

The building will be designed to meet a number of the LEED performance objectives.

The building will be designed to comply with the Green Building Certification System standards prepared for the U.S. General Services Administration with respect to the guiding principles for new construction and major renovation as follows:

## 1. Robustness-Integrated Principals

The Building has been sited on the lot in such a manner as to add to the open space on the lot. There will be no generation of greenhouse gas emanating from the site whether during the construction phase or thereafter.

## 2. Energy

The Building has also been designed with energy efficiency in mind with respect to the physical characteristics of the building itself and with respect to the interior property and equipment such as stoves, sinks, refrigerators, etc. at the property.

## 3. Water

A storm water management plan is being worked on and generated with the engineering department and the Building Inspection and Department for the Town.

## 4. Resources/Materials

Proper waste disposal is being provided for with respect to the Applicant's plans and no ozone depleting compound will be used at the property.

## 5. Indoor Environment

Adequate lighting controls are also provided for with respect to the Applicant's plans so that there is no adverse impact with regard to neighboring properties as a result of any lighting emanating from the property.

Adequate steps will also be taken to protect indoor air quality during the construction phase and only low emitting materials will be used during the construction phase at the property.

All as shown on exhibit A affixed to this response and incorporated into its terms by reference

In addition, projects subject to Environmental Design Review must address and meet the following Special Permit Criteria (see Section 3.3.3 of the Zoning Bylaw)

1. The use requested is listed in the Table of Use Regulations as a special permit in the district for which application is made or is so designated elsewhere in this Bylaw.

The use is so listed.

2. The requested use is essential or desirable to the public convenience or welfare.

It has been apparent for many years that the Town and its inhabitants and potential inhabitants would benefit from mixed use development in the Town.

The Applicant's plans provide for a mixed use development and also provide additional residential living space in the Town and at the same time provides four (4) affordable housing residential units for families and individuals of lower economic means to have an opportunity to live in the Town.

3. The requested use will not create undue traffic congestion, or unduly impair pedestrian safety.

While the existing use of the property is an automobile garage and repair shop the new use will generate less traffic to and from the property and adequate steps have been taken to provide for pedestrian safety in accordance with Applicant's plan.

4. The requested use will not overload any public water, drainage or sewer system or any other municipal system to such an extent that the requested use or any developed use in the immediate area or in any other area of the Town will be unduly subjected to hazards affecting health, safety or the general welfare.

There will be no overload of any public water, drainage or sewer system or any other municipal system to such an extent that the requested use or any developed use in the immediate area or in any other area of the Town will be unduly subjected to hazards affecting health, safety or general welfare.

5. Any special regulations for the use, set forth in Article 11, are fulfilled.

This requirement is satisfied with respect to the Applicant's plans.

6. The requested use will not impair the integrity or character of the district or adjoining districts, nor be detrimental to the health, morals, or welfare.

Far from impairing the integrity and character of the district or adjoining districts, the Applicant's plans will decidedly improve the integrity or character of the district or adjoining district as a result of the building to be constructed at the site replacing the existing garage building.

The Applicant's plans will not be detrimental to the health, morals or welfare.

7. The requested use will not, by its addition to a neighborhood, cause an excess of that particular use that could be detrimental to the character of said neighborhood.

The requested use will not, by its addition to a neighborhood, cause an excess of the particular use that could be detrimental to the character of said neighborhood. As stated previously, the requested use will be an improvement to the neighborhood generating less traffic in an area in the Town which has historically been used for automotive repair purposes. The residential use will be by far a decadently less intensive use the neighborhood.

## PLANNING & COMMUNITY DEVELOPMENT:

2010 DEC 21 A 10: 51

## TOWN OF ARLINGTON

Distance to Nearest Building

Dimensional and Parking Information for Application to The Arlington Redevelopment Board

Docket No. 35810

Property Location 10 Sunnyside Ave	·		Zoning District 8	-4
Owner:	A	ddress: 10 Su	nnysicle Are	
Present Use/Occupancy: No. of Dwelling Units  Auto Garage	<b>.</b>		ross square feet:	
Proposed Use/Occupancy: No. of Dwelling Uni	ts:	5,389 G	·.S. F ross square feet:	
20 Residential Units		30,525 0		
	Present Conditions	Proposed <u>Conditions</u>	Min. or Max. Required by Zoning for Proposed Use	9
Lot Size	16,500	16,500	min. Ø	
Frontage	150'	150'	min. 50	
Floor Area Ratio	. 33	1.85	max. 1.875	
Lot Coverage (%), where applicable	.94	.20	max. • 40	
Lot Area per Dwelling Unit (square feet)	N/A	635	min. Ø	1
Front Yard Depth (feet)	4.3'	3'-6"/5'-6"	min. Ø	7
Side Yard Width (feet) right side	70.9	15' / 19'	min. Ø	
left side	1.0'	21'/25'	min. Ø	
Rear Yard Depth (feet)	Ø	21'/25'	min. 16 '	4
Height	<b></b>		min.	1
Stories	1	4	stories 4	1
Feet	14/201	50'	feet 50'	
Open Space (% of G.F.A.)	.018	.80	min.	
Landscaped (square feet)	978	7062	(s.f.) 3,052.5	_ 
Usable (square feet)	11.111	W125	(s.f.) 4,105	L'
Parking Spaces (No.)	40	33		
Parking Area Setbacks (feet), where applicable	31	3'	7	1
Loading Spaces (No.)	0	0		4
Type of Construction	1		min. 🗸	1

30.6/71

10'

24'/93'

5

(10%)

(20%)

## **■**Proposal:

garage with a total of 33 parking spaces will be provided on site with bike hooks at each parking space. the building has taken many helpful queues from the Arlington Design Standards, such as breaking the bike path and we felt it was important to take into account our exterior design so we added bike racks project itself does not directly abut the Alewife Greenway Bike Path, but it is in close proximity to the The project will include 1 retail space at grade along Sunnyside Avenue. In addition an upper & lower their bikes and not need a vehicle to get to and from the site. The project will create homeownership A dedicated Bike Storage Room will be located off of the main residential entry. The overall design of in front of the retail space so anyone visiting or going to the retail space would be encouraged to use To erect a new 4 story mixed use building with 26 residential units (mixture of 1 & 2 bedroom units). massing of the buildings elevations by adding bays, stepping the building back in places, making the residential entry very prominent by anchoring it's heavy features at the front of the building. The Adaptable. The project has been designed As-of-Right and will not need any zoning variances. including (4) Affordable Units and (2) Group 2 Units, with the remaining units being Group 1

## -Zoning District:

Section 5.5 / B-4

## Lot Size:

**16,500** square feet

## Proposed Gross Square Footage:

30,525 square feet / FAR: 1.85

## Building Height:

**20,-0** 

# Proposed Affordable Units

26 Units x 15% = 3.9 Units (4 - Affordable Units Proposed)

Unit #	Unit Type	Floor	Square Footage
2	2 Bedroom	2 Floor	801 sq. ft.
6	2 Bedroom	2 Floor	890 sq. ft.
17	1 Bedroom	3 Floor	814 sq. ft.
26	1 Bedroom	4 Floor	482 sq. ft.

## 4 Affordable Units

## Group 2 Units

26 Units x 5% = 1.3 Units  $(2 - Group \ 2$  Units Proposed)

Square Footage	801 sq. ft.	814 sq. ft.
Floor	2 Floor	3 Floor
Unit Type	2 Bedroom	1 Bedroom
Unit #	2	17

## 2 Group 2 Units



## LEED v4 for Building Design and Construction: Homes and Multifamily Lowrise

Project Checklist Project Name: 10 Sunnyside Ave. Arlington, MA

3

40 5.5 **62.5** TOTALS

Date: 12/28/18


Υ	?	N	_		
		2	Credit	Integrative Process	2
13	0.5	1.5	Loca	tion and Transportation	15
Y	0.5	1.5	Prereq	Floodplain Avoidance	Required
T			Prereq	PERFORMANCE PATH	Required
			Credit	LEED for Neighborhood Development Location	15
_			Orodic	PRESCRIPTIVE PATH	10
8			Credit	Site Selection	8
2		1	Credit	Compact Development	3
2			Credit	Community Resources	2
1	0.5	0.5	Credit	Access to Transit	2
•	0.0	0.0			-
1	0	6	Susta	ainable Sites	7
Υ			Prereq	Construction Activity Pollution Prevention	Required
Υ			Prereq	No Invasive Plants	Required
		2	Credit	Heat Island Reduction	2
		3	Credit	Rainwater Management	3
1		1	Credit	Non-Toxic Pest Control 2	
			_		
8	0	4	Wate	r Efficiency	12
Υ			Prereq	Water Metering	Required
			_	PERFORMANCE PATH	
		2	Credit	Total Water Use	12
			,	PRESCRIPTIVE PATH	
6			Credit	Indoor Water Use	6
2		2	Credit	Outdoor Water Use	4
			-	1.44	••
4 Y	0	34	Prereq	gy and Atmosphere	38
Y Y			Prereq	Minimum Energy Performance	Required
Υ			Prereq	Energy Metering	Required
1			ridioq	Education of the Homeowner, Tenant or Building Manager  PERFORMANCE PATH	Required
		29	Credit	Annual Energy Use	29
				BOTH PATHS	25
2		3	Credit	Efficient Hot Water Distribution System	5
1		1	Credit	Advanced Utility Tracking	2
		1	Credit	Active Solar Ready Design	1
1			Credit	HVAC Start-Up Credentialing	1
			_	PRESCRIPTIVE PATH	·
Υ			Prereq	Home Size	Required
			Credit	Building Orientation for Passive Solar	3
			Credit	Air Infiltration	2
			Credit	Envelope Insulation	2
			II.	· · · · · · · · · · · · · · · · · · ·	_

Space Heating & Cooling Equipment

			EA PRESCRIPTIVE PATH (continued)	
			Credit Heating & Cooling Distribution Systems	3
			Credit Efficient Domestic Hot Water Equipment	3
			Credit Lighting	2
			Credit High Efficiency Appliances	2
			Credit Renewable Energy	4
			•	
2	2	6	Materials and Resources	10
Υ			Prereq Certified Tropical Wood	Required
Υ			Prereq Durability Management	Required
		1	Credit Durability Management Verification	1
1	1	2	Credit Environmentally Preferable Products	4
1	1	1	Credit Construction Waste Management	3
		2	Credit Material Efficient Framing	2
7	1	8	Indoor Environmental Quality	16
Υ			Prereq Ventilation	Required
Υ			Prereq Combustion Venting	Required
Υ			Prereq Garage Pollutant Protection	Required
Υ			Prereq Radon-Resistant Construction	Required
Υ			Prereq Air FIltering	Required
Υ			Prereq Environmental Tobacco Smoke	Required
Υ			Prereq Compartmentalization	Required
		3	Credit Enhanced Ventilation	3
1		1	Credit Contaminant Control	2
		3	Credit Balancing of Heating and Cooling Distribution Systems	3
1			Credit Enhanced Compartmentalization	1
2			Credit Enhanced Combustion Venting	2
2			Credit Enhanced Garage Pollutant Protection	2
1	1	1	Credit Low Emitting Products	3
4	2	0	Innovation	6
Υ			Prereq Preliminary Rating	Required
3	2		Credit Innovation	5
1			Credit LEED AP Homes	1
1	0	3	Regional Priority	4
1			Credit WE Indoor Water Use; threshold = 6 points	1
		1	Credit Regional Priority: Specific Credit	1
		1	Credit Regional Priority: Specific Credit	1
		1	Credit Regional Priority: Specific Credit	1


Certified: 40 to 49 points, Silver: 50 to 59 points, Gold: 60 to 79 points, Platinum: 80 to 110

Possible Points: 110

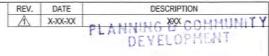

## 10 SUNNYSIDE AVENUE ARLINGTON, MA ZONING REVIEW

2018 DEC 21 A 10: 51

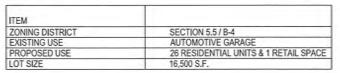

## DIMENSIONAL REGULATIONS SECTION 5.5

ITEM	REQUIRED	PROPOSED
MIN. LOT SIZE	NONE	16,500 S.F.
MIN. LOT FRONTAGE	50'	150'
MAX. FLOOR AREA RATIO	1.5 + 25% = 1.875	1.85 (30,525 S.F. 2)
MAX. ALLOWABLE STORIES	4	4
MAX. ALLOWABLE BUILDING HEIGHT	50'-0"	50'-0"
MIN. FRONT YARD	0'	3'-6" ± / 5'-6" ±
MIN. SIDE YARD	0'	15' - / 19' - / 21' - / 25' -
MIN. REAR YARD	16'	21" * / 25" *
MIN. LANDSCAPE AREA	10% (3,052.5 S.F.)	7,062 S.F. <sup>±</sup>
OPEN SPACE (20%)	3' BUFFER / 6.105 * S.F.	3' BUFFER / 6.125 * S.F.

UNIT BEDROO	OM BREAKDO	OWN
1 BEDROOM	7 UNITS	(482 SQ. FT 854 SQ. FT.)
2 BEDROOM	19 UNITS	(801 SQ. FT 1,173 SQ. FT.)
TOTAL:	26 UNITS	

RETAIL SPACE	1 UNIT	(2.124 SQ. FT.)	
TILL THE OF MOL	LOIN	(2,12400.11.)	

PARKING REG	QUIREMENT		
TYPE	# OF UNITS	ZONING REQUIREMENT	REQUIRED SPACES
1 BEDROOM	7 UNIT	1.15	8.05 SPACES
2 BEDROOM	19 UNITS	1.5	28.5 SPACES
RETAIL	1 UNIT	(2,124 S.F.) 1/300 SF*	0 SPACES
TOTAL PARK	NG		37 SPACES
10% REDUCT	ION FOR AFFO	ORDABLE HOUSING	4 SPACES
TOTAL REQU	IRED PARKIN	G	33 SPACES
*FIRST 3,000 S.F.	OF NON-RESIDE	ENTIAL SPACE IN MIXED USE IS EXE	MPT

GROUND LEVEL GARAGE: 13 PARKING SPACES 20 PARKING SPACES BASEMENT GARAGE: 33 PARKING SPACES

## 5.5 BUSINESS DISTRICTS:

B4: VEHICULAR ORIENTED BUSINESS DISTRICT. THE VEHICULAR ORIENTED BUSINESS DISTRICT PROVIDES FOR ESTABLISHMENTS THAT ARE PRIMARILY ORIENTED TO AUTOMOTIVE TRAFFIC, WHICH MEANS THEY REQUIRE LARGE AMOUNTS OF LAND IN PROPORTION TO BUILDING COVERAGE, THIS DISTRICT ALSO CONSISTS OF ESTABLISHMENTS DEVOTED TO THE SALE OR SERVICING OF MOTOR VEHICLES, THE SALE OF VEHICULAR PARTS AND ACCESSORIES, AND SERVICE STATIONS, ARLINGTON HAS AN ABUNDANCE OF AUTOMOTIVE AND AUTOMOTIVE ACCESSORY SALES AND SERVICE ESTABLISHMENTS. AS THESE BUSINESSES GRADUALLY CLOSE, THE TOWN HAS ENCOURAGED CONVERSION OF THE PROPERTY TO OTHER RETAIL, SERVICE, OFFICE OR RESIDENTIAL USE, PARTICULARLY AS PART OF MIXED-USE DEVELOPMENT.

VERIFY AND CONFIRM ALL CONDITIONS AND/OR DIMENSIONS SHOWN PROOK TO COMMENCING CONSTRUCTION OR ORDERING MATERIALS. NOTIFY ARCHITECT OF ANY INCONSISTENCIES FOR REVIEW AND APPROVAL BEFORE PROCEEDING WITH CONSTRUCTION.

K RC, Ø

10 Sunnyside Avenue Arlington, MA 02474

PROJECT# 18-084 DATE: 12-17-18 REV: SCALE: NONE DRAWN BY: C.D. CHECKED BY:

R.P.B.


AERIAL PHOTO & ZONING INFORMATION


GENERAL NOTE:





<sup>\*\* 2</sup> ACCESSIBLE PARKING SPACES PROVIDED

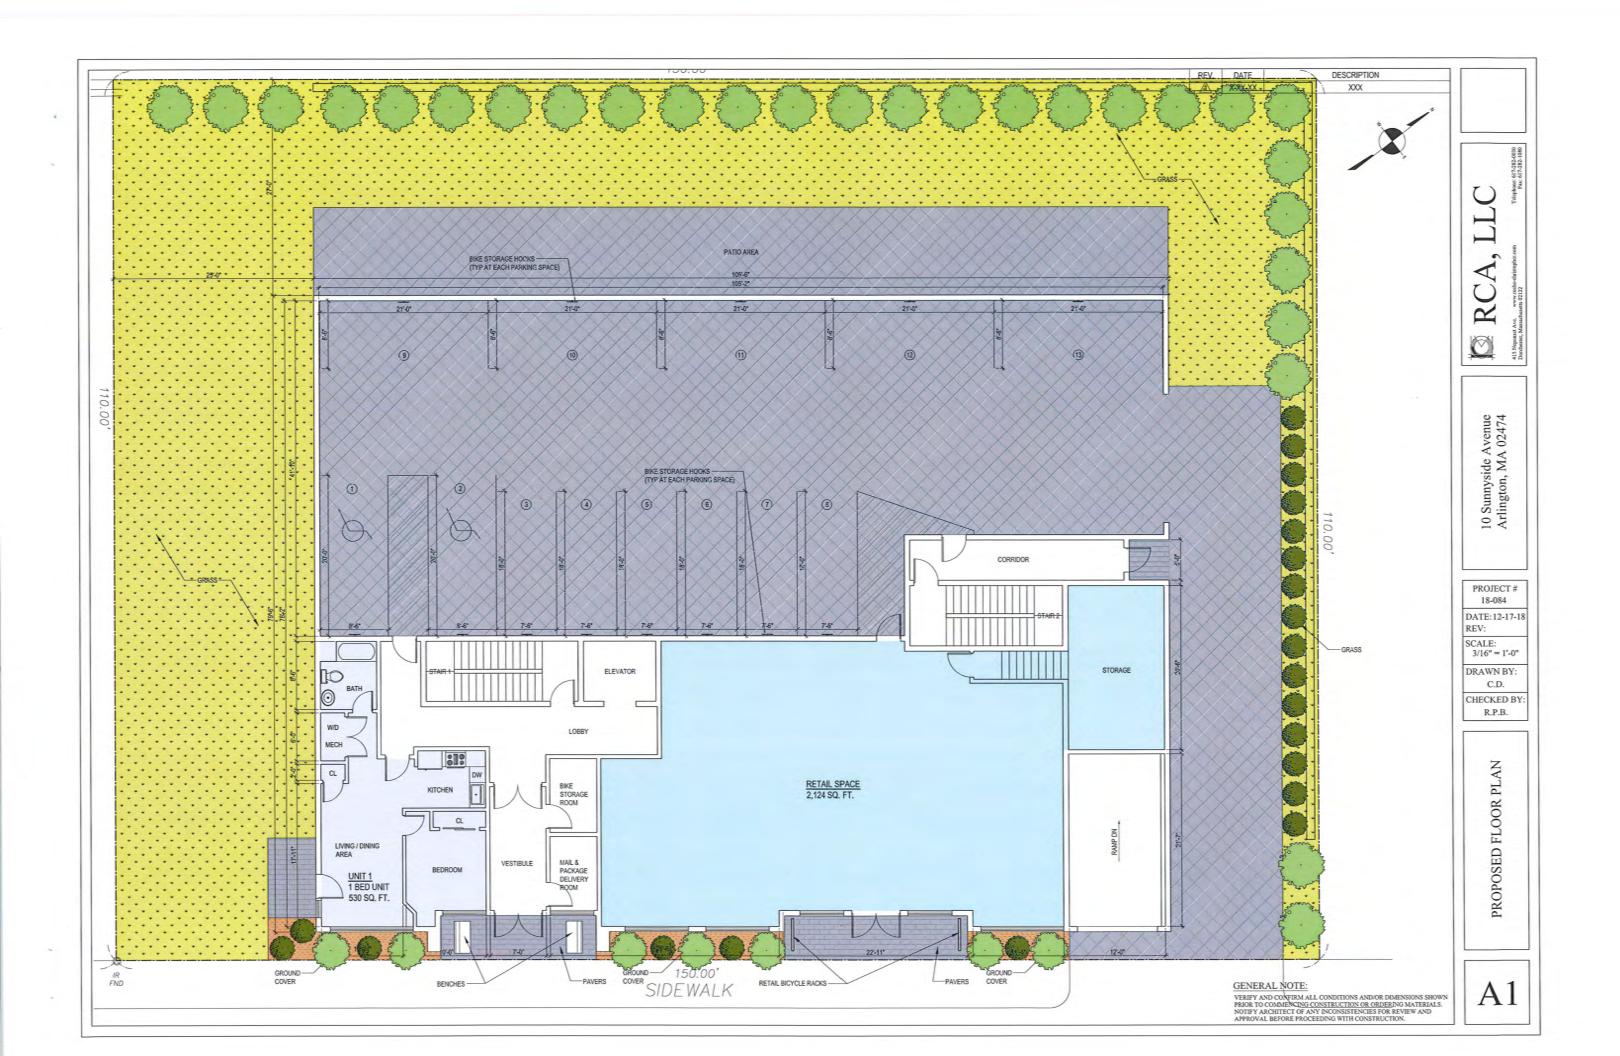

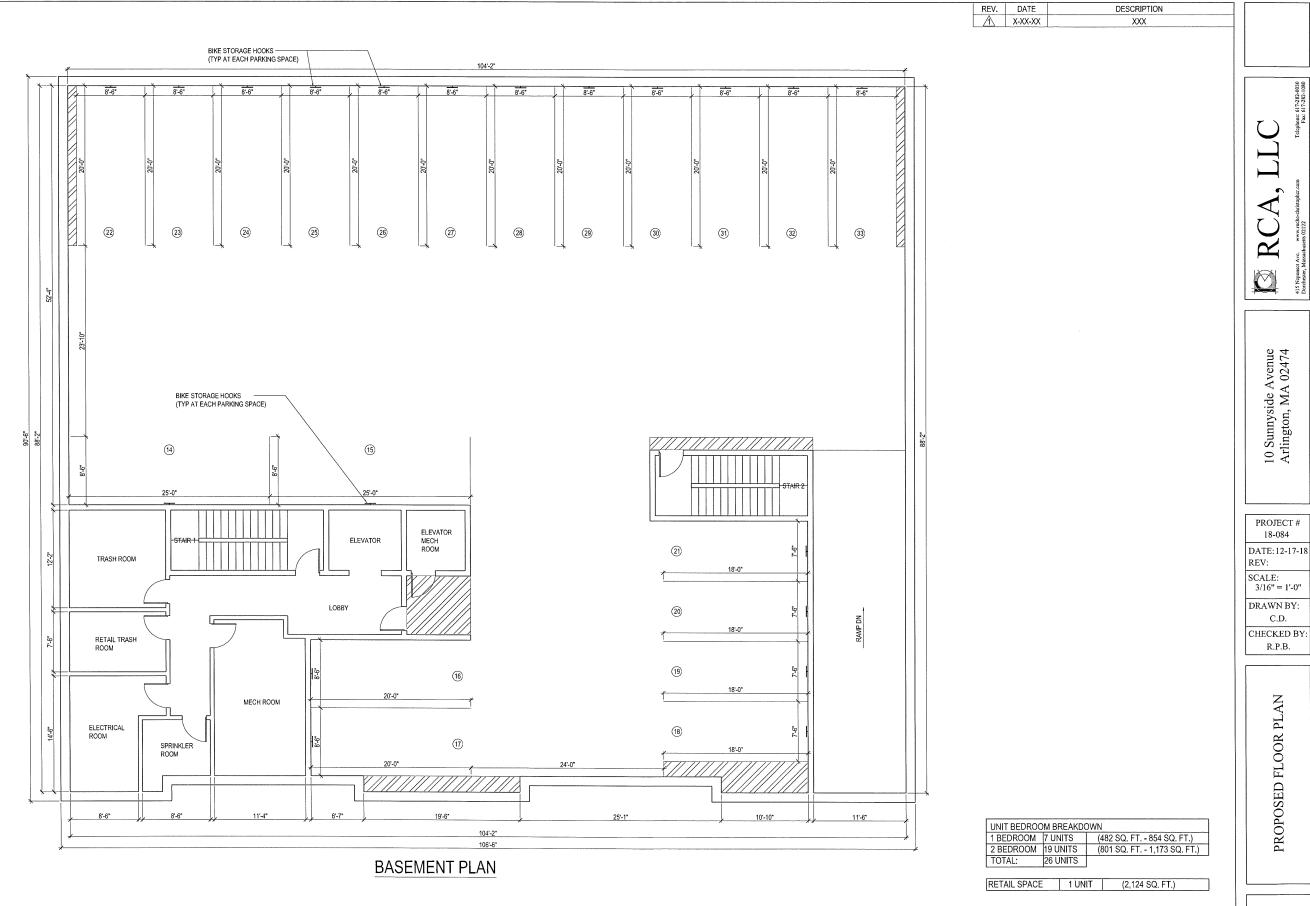

GENERAL NOTE:

VERIFY AND CONFIRM ALL CONDITIONS AND/OR DIMENSIONS SHOWN PRIOR TO COMMENCING CONSTRUCTION OR ORDERING MATERIALS. NOTIFY ARCHITECT OF ANY INCONSISTENCIES FOR REVIEW AND APPROVAL BEFORE PROCEEDING WITH CONSTRUCTION.

RC

10 Sunnyside Avenue Arlington, MA 02474

C.D.

R.P.B.

PROPOSED FLOOR PLAN



A3

A,

RC,

0

10 Sunnyside Avenue Arlington, MA 02474

PROJECT #

18-084


3/16" = 1'-0"

C.D.


R.P.B.

PROPOSED FLOOR PLAN

VERIFY AND CONFIRM ALL CONDITIONS AND/OR DIMENSIONS SHOWN PRIOR TO COMMENCING CONSTRUCTION OR ORDERING MATERIALS. NOTIFY ARCHITECT OF ANY INCONSISTENCIES FOR REVIEW AND APPROVAL BEFORE PROCEEDING WITH CONSTRUCTION.

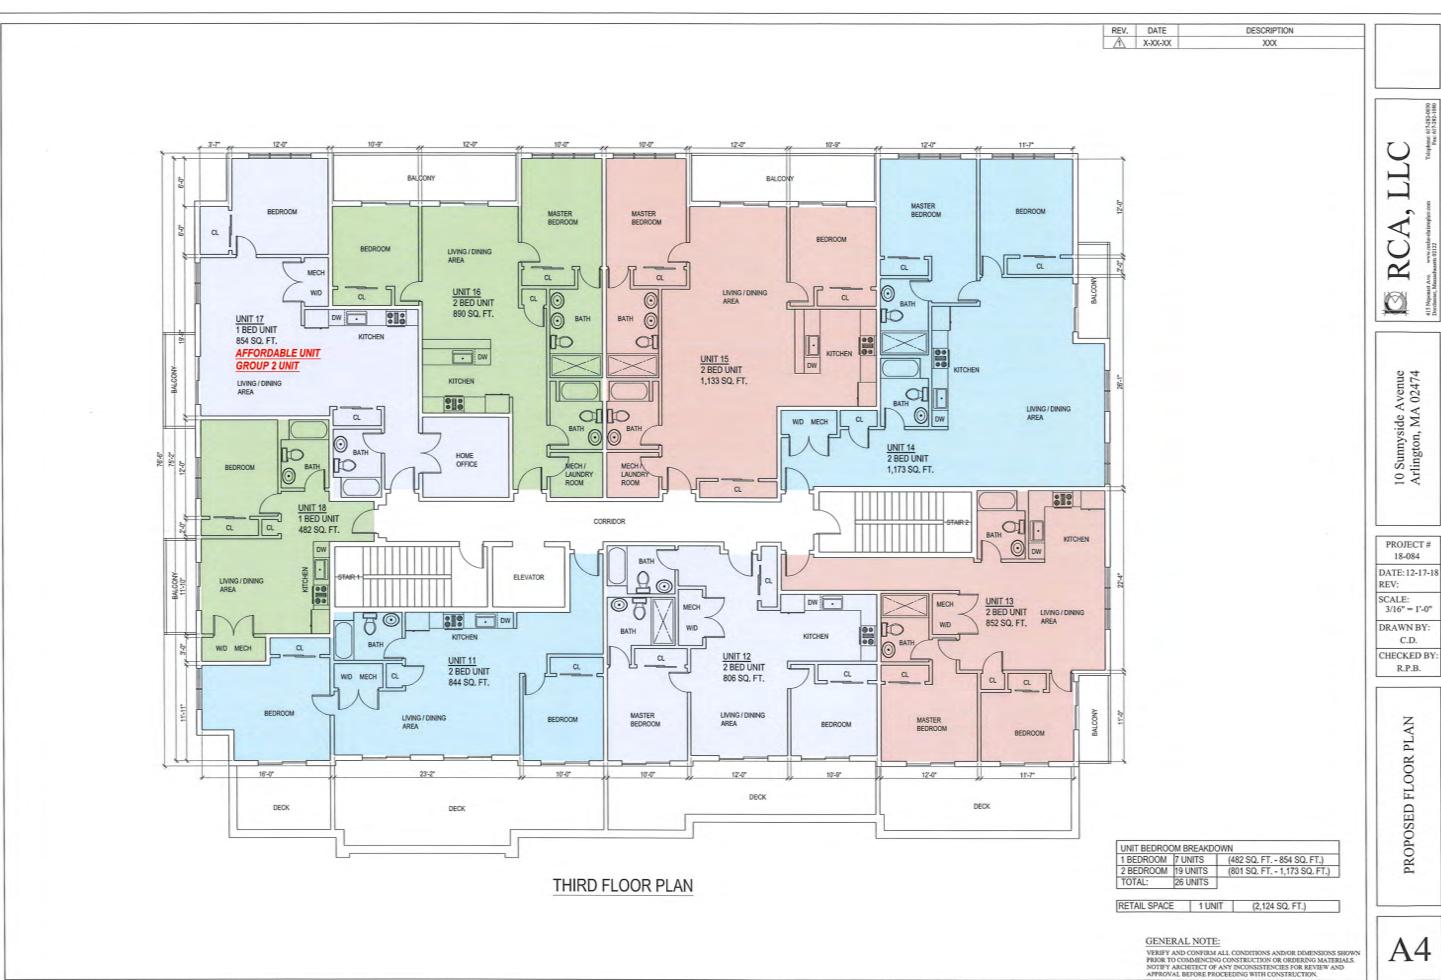

PROPOSED FLOOR PLAN

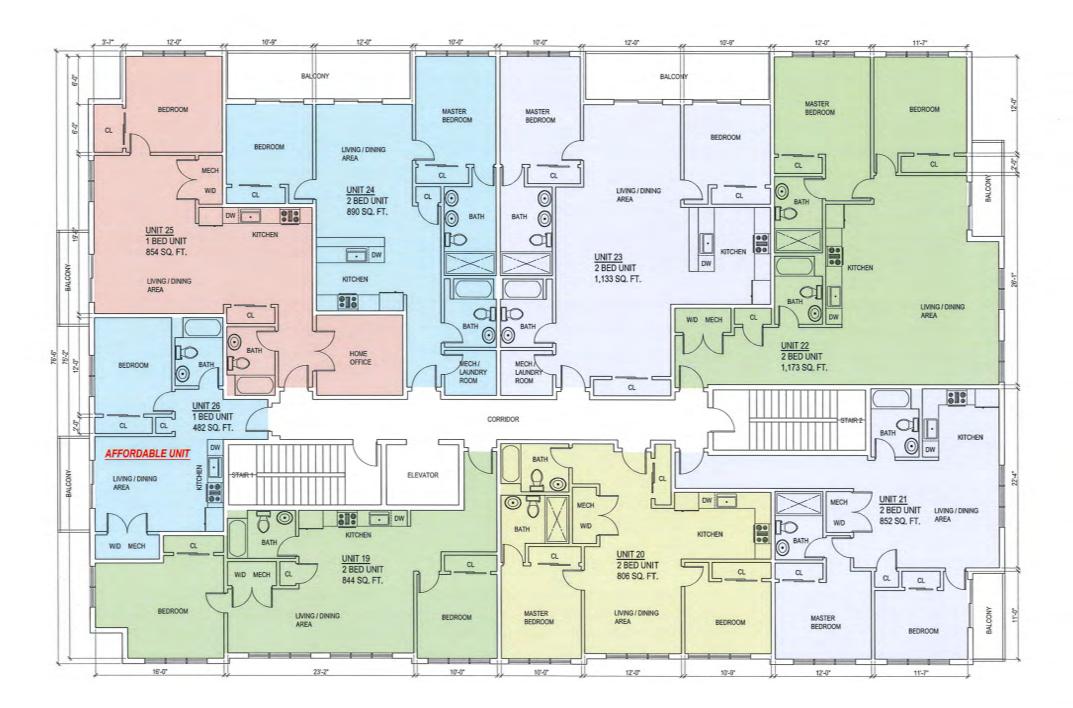

FOURTH FLOOR PLAN

1 BEDROOM	7.UNITS	(482 SQ. FT 854 SQ. FT.)
2 BEDROOM	19 UNITS	(801 SQ. FT 1,173 SQ. FT.
TOTAL:	26 UNITS	

RETAIL SPACE 1 UNIT (2,124 SQ. FT.)

## GENERAL NOTE

VERIFY AND CONFIRM ALL CONDITIONS AND/OR DIMENSIONS SHOWN PRIOR TO COMMENCING CONSTRUCTION OR ORDERING MATERIALS. NOTIFY ARCHITECT OF ANY INCONSISTENCIES FOR REVIEW AND APPROVAL BEFORE PROCEEDING WITH CONSTRUCTION.

A5

RCA, LLC

10 Sunnyside Avenue Arlington, MA 02474


PROJECT # 18-084 DATE: 12-17-18

REV: SCALE: 3/16" = 1'-0"

DRAWN BY: C.D.

CHECKED BY: R.P.B.

PROPOSED FLOOR PLAN

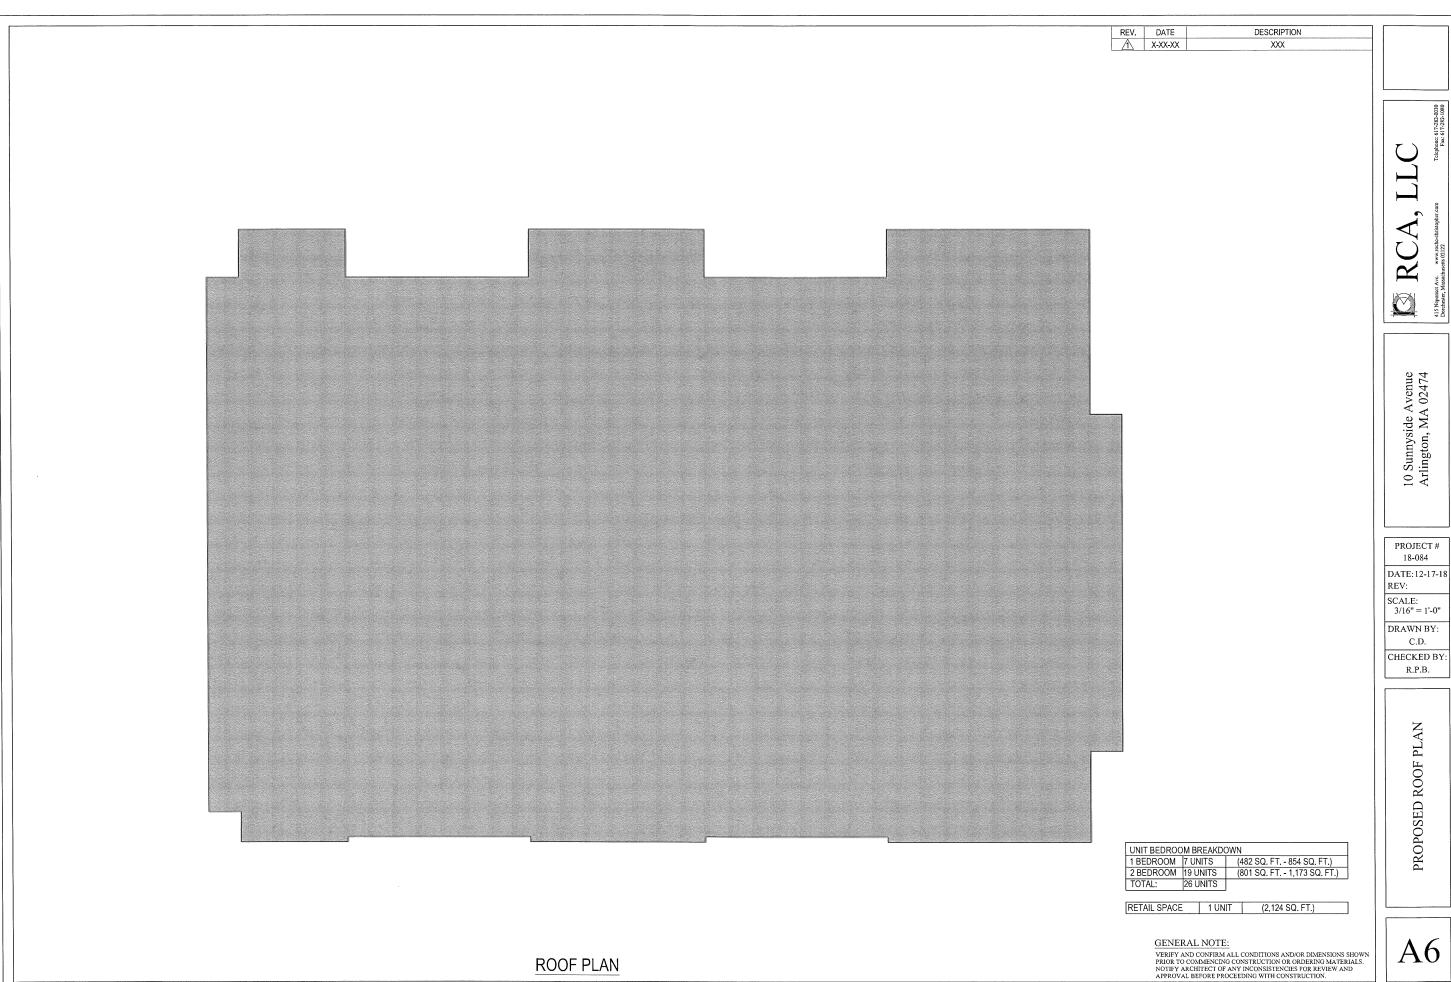

PROJECT # 18-084

CHECKED BY:

R.P.B.



A, RC/

10 Sunnyside Avenue Arlington, MA 02474

PROJECT #

18-084 DATE: 12-17-18

SCALE: 3/16" = 1'-0"

C.D. CHECKED BY:

R.P.B.

PROPOSED ELEVATION

RCA, L

10 Sunnyside Avenue Arlington, MA 02474

PROJECT #

DATE: 12-17-18 REV:

SCALE: 3/16" = 1'-0" DRAWN BY:

C.D. CHECKED BY:

CHECKED BY R.P.B.

PROPOSED ELEVATION

A8



VERIFY AND CONFIRM ALL CONDITIONS AND/OR DIMENSIONS SHOWN PRIOR TO COMMENCING CONSTRUCTION OR ORDERING MATERIALS. NOTIFY ARCHITECT OF ANY INCONSISTENCIES FOR REVIEW AND APPROVAL BEFORE PROCEEDING WITH CONSTRUCTION.

DESCRIPTION REV. DATE ⚠ x-xx-xx XXX 5" REVEAL HARDI -PLANK SIDING 7" REVEAL HARDI — PLANK SIDING 5" REVEAL HARDI — PLANK SIDING 7" REVEAL HARDI -PLANK SIDING 7" REVEAL HARDI -PLANK SIDING 5" REVEAL HARDI — PLANK SIDING PVC TRIM -SECOND FL BLACK ANDERSON — 100 SERIES WINDOWS BLACK WROUGHT IRON RAILING SYSTEM PVC BAND -**ELEVATION 3** 

GENERAL NOTE:

VERIFY AND CONFIRM ALL CONDITIONS AND/OR DIMENSIONS SHOWN PRIOR TO COMMENCING CONSTRUCTION OR ORDERING MATERIALS. NOTIFY ARCHITECT OF ANY INCONSISTENCIES FOR REVIEW AND APPROVAL BEFORE PROCEEDING WITH CONSTRUCTION.



RCA, LLC

415 Neponset Ave. www.rocho-christopher.com Dorchester, Massachusetts 02122

10 Sunnyside Avenue Arlington, MA 02474

PROJECT# 18-084

DATE: 12-17-18 REV:

SCALE: 3/16" = 1'-0" DRAWN BY:

C.D. CHECKED BY: R.P.B.

PROPOSED ELEVATION

REV. DATE

X-XX-XX DESCRIPTION XXX

7" REVEAL HARDI PLANK SIDING BLACK ANDERSON 100 SERIES WINDOWS BLACK WROUGHT IRON RAILING SYSTEM PVC TRIM -FOURTH FL 7" REVEAL HARDI — PLANK SIDING PVC BAND -**ELEVATION 4** BLACK FRAME ALUMINUM STOREFRONT WINDOWS 

RC, 

10 Sunnyside Avenue Arlington, MA 02474

PROJECT# 18-084

DATE: 12-17-18 REV: SCALE: 3/16" = 1'-0"

DRAWN BY: C.D.

CHECKED BY: R.P.B.

PROPOSED ELEVATION

GENERAL NOTE:

VERIFY AND CONFIRM ALL CONDITIONS AND/OR DIMENSIONS SHOWN PRIOR TO COMMENCING CONSTRUCTION OR ORDERING MATERIALS. MOTHEY ARCHITECT OF ANY INCONSISTENCIES FOR REVIEW AND APPROVAL BEFORE PROCEEDING WITH CONSTRUCTION.