PLANNING & COMMUNITY DEVELOPMENT

KRATTENMAKER O'CONNOR & INGBER P.C.

ATTORNEYS AT LAW

2020 JAN 2 I P 2: 08
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January 21, 2020

CHARLES G. KRATTENMAKER, JR. MARY WINSTANLEY O'CONNOR KENNETH INGBER

OF COUNSEL: RAYMOND SAYEG

VIA EMAIL

Jennifer Raitt, Director
Department of Planning and Community
Development
Town of Arlington
730 Massachusetts Avenue
Arlington, MA 02476

Re: Docket No. 3602 / 1207-1211 Massachusetts Avenue

Dear Jenny:

Thank you for your memorandum of January 7, 2020. I will respond to the items raised in the order in which you have listed them.

- 1. A traffic study will be submitted by Mr. Doherty.
- 2. See the revised plans.
- 3. The revised plans show screening where the proposed mechanical's will be located. This also reflects a reduction in the proposed venting for the building at this time. It should be noted that the final locations will be determined on the IFC (Issued for Construction) plans and will not be visible to the surrounding neighborhood.
- 4. See the updated information attached as Exhibit "A".
- 5. See the updated information attached as Exhibit "B".
- 6. The petitioner will not be providing this information as it is proprietary and is not relevant to the relief requested.
- 7. This information was provided in the materials delivered on January 2, 2020. There are two properties with solar panels behind the subject property 18 Pierce Street and 24 Clark Street. Neither is impacted.
- 8. See the updated information attached.
- 9. Resolved no response required.

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Jennifer Raitt, Director January 21, 2020 Page 2

Comments provided by ARB:

- 1. A draft traffic study will be submitted by Mr. Doherty.
- 2. Updated information was included in the package delivered on December 2, 2019. Additional information will be provided with the submission on January 20, 2020.
- 3. Resolved no response is required.
- 4. Resolved as indicated above. Additional detailed information will be included in the January 20, 2020 submission.
- 5. Detailed information will be included in the January 20, 2020 submission.
- 6. Resolved no response required.
- 7. Resolved no response required.
- 8. Resolved no response required.
- 9. This has been revised and was included in the December 2, 2019 submission.
- 10. I would suggest that no parking is required for the restaurant as it is a prior nonconforming use. The DAV had a kitchen and restaurant and had no parking. I would suggest that this is substantially similar to the restaurant use being proposed for the Balich 5 & 10, where no parking is available on site.
- 11. Resolved no response required.
- 12. Resolved no response required.
- 13. Resolved no response required.
- 14. Updated information will be provided with the January 20, 2020 submission.

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Jennifer Raitt, Director January 21, 2020 Page 3

Please do not hesitate to contact me to discuss this matter. In advance, I thank you.

Very wuly yours,

Mary Winstanley O'Connor

MWO/ccg Enclosures 6214

cc: James Doherty

Exhibit A

The FAR for this proposal is 1.5 as provided for by the mixed use bylaws. As mentioned in your correspondence, Section 5.3.6 provides for bonus space based on certain criteria.

For this proposal we are requesting a modest increase of 10% or 2,104 s.f.. This request is based on the 'Public Access' provision and will provide for a public art and presentation area located in the front right area of the lot. We intend to provide through an easement to allow various groups the opportunity to have presentations and events for the community.

Exhibit B

As detailed on our revised plans, we are providing open space on three sides of the proposed building; the rear, left side and in front of the building. The open space will consist of a grass landscaped area and pervious paver area. The total will be 2,741 s.f.

Lighting

The lighting proposed for the site will consist of energy efficient LED low profile lighting. Deflectors and other technology will be utilize to ensure lighting does not spill into the neighborhood. To ensure the desired results are achieved, we will be conducting a photometric study prior to finalizing the installation.





803 SUMMER STREET, BOSTON, MA 02127 - www.bscgroup.com TEL 617-896-4300 - 800-288-8123

To: James Doherty Date: January 16, 2020 1211 Massachusetts Avenue Realty Trust

From: Michael A. Santos, PE Proj. No. 28408.00

Re: 1211 Massachusetts Avenue – Arlington MA

Re: 1211 Massachusetts Avenue – Arlington, MA Traffic Information Summary

BSC Group, Inc. has conducted an evaluation of the transportation characteristics and impacts of the proposed hotel development to be located at 1211 Massachusetts Avenue (the "Project") in Arlington, Massachusetts. This evaluation provides information related to trip generation characteristics of the Project, vehicular circulation and operations on the site, and parking supply.

Project Description

The Project will consist of the construction of a new 50-room hotel and restaurant at 1211 Massachusetts Avenue. The Project site is located along the north side of Massachusetts Avenue and is adjacent to Clark Street on the west. Vehicular access will be provided by a valet operated pick-up/drop-off area with two curb cuts along Massachusetts Avenue. Access to the parking area will be along the east side of Clark Street, on the north side of the site.

The existing site consists of both 1207 and 1211 Massachusetts Avenue and contains a 2,500 square foot (sf) Disabled American Veterans (DAV) building, a used car dealership, an automobile service station, and a three-bedroom apartment, which contains 3,031 sf. There are currently two curb cuts along Massachusetts Avenue and one curb cut along Clark Street that provide access to the existing uses on the site. The DAV building recently closed and operated similarly to a restaurant. All uses on the existing site will be demolished as part of the Project.

Site Access

Vehicular access to the site will be limited to pick-up/drop-off and valet operations. A one-way, semi-circular driveway will be located at the front of the site, adjacent to Massachusetts Avenue. Two-curb cuts will be provided to allow westbound vehicular flow through the site, with the eastern curb cut operating as enter-only and the western curb cut operating as exit-only. An additional curb cut will be provided along the east side of Clark Street to provide access to the parking area in the rear of the building. Right-turns onto Clark Street northbound from the parking area will not occur, as the parking will be valet and controlled by the hotel operator.

Pedestrian access will be provided for the hotel lobby and the restaurant along Massachusetts Avenue. Sidewalks are currently provided along Massachusetts Avenue and Clark Street, with a painted crosswalk across Clark Street. The Project will upgrade all adjacent sidewalks, curb ramps, and crosswalks that serve the site to current standards set forth by the Americans with Disabilities Act (ADA). Bicycle racks will be provided for guests and visitors along Massachusetts Avenue. A secure and covered bicycle storage room will be provided within the lower level of the building for employees of the future uses on the site.

The Massachusetts Bay Transportation Authority (MBTA) operates the #77 and #79 buses along Massachusetts Avenue, adjacent to the Project site, with inbound and outbound stops immediately east of the site, near the intersection of Massachusetts Avenue/Appleton Street. Both buses provide access between Arlington Heights and the MBTA's Red Line. The #77 bus provides access to Harvard Station,

Rev. 2015-11-11 Page 1 of 4

MEMORANDUM



approximately 4.5 miles to the east, and the #79 bus provides access to Alewife Station, approximately 2.5 miles to the east.

Parking and Loading

The Project will provide a total of 27 parking spaces for the hotel uses. A tandem-style garage will be located in the rear of the building on the north side of the site and will contain 24 parking spaces. An additional three spaces will be located along the north side of the site in a surface lot. All parking on the site will be valet and will serve both the hotel and restaurant uses. The Project will not have any spaces for self-parking. On-street parking is allowed along both sides of Massachusetts Avenue. The Project will not change the overall number of available on-street parking spaces.

All loading and trash operations will occur in the rear of the building via the Clark Street curb cut. Deliveries will occur either in the pick-up/drop-off area or in the rear of the building, depending on the anticipated duration. Deliveries and loading operations will be limited to single-unit box trucks and smaller vehicles.

Trip Generation

Trip generation estimates for the Project are based on the Institute of Transportation Engineers (ITE) Trip Generation Manual, 10th Edition. Trip generation estimates were developed for the proposed 50-room hotel. Table 1 presents the trip generation for the Project.

Table 1
Trip Generation Summary

| | | Project Trips | | | F | Existing Trips | | | |
|----------------|--------------------|-------------------------|-----------|-------------------|-------------------------|----------------------|------------------------|-----------|------------|
| | | | | | | Automobile | | | |
| | | | | DAV | Auto | Service | | | Net |
| Time Period | Hotel ¹ | Restaurant ² | Total | Club ² | Dealership ³ | Station ⁴ | Apartment ⁵ | Total | Change |
| AM Peak Hour | | | | | | | | | |
| Entering | 14 | 15 | 29 | 15 | 1 | 3 | 0 | 19 | +10 |
| Exiting | <u>10</u> | <u>13</u> | <u>23</u> | <u>13</u> | <u>0</u> | 1 | <u>1</u> | <u>15</u> | <u>+8</u> |
| Total | 24 | 28 | 52 | 28 | 1 | 4 | 1 | 34 | +18 |
| PM Peak Hour | | | | | | | | | |
| Entering | 15 | 17 | 32 | 17 | 0 | 3 | 1 | 21 | +11 |
| Exiting | <u>15</u> | <u>10</u> | <u>25</u> | <u>10</u> | <u>1</u> | <u>2</u> | <u>0</u> | <u>13</u> | <u>+12</u> |
| Total | 30 | 27 | 57 | 27 | 1 | 5 | 1 | 34 | +23 |

¹ Based on ITE Land Use Code (LUC) 310 - Hotel (50 Rooms)

Based on the trip generation and mode share data, the Project is expected to generate 52 vehicle trips during the weekday morning peak hour and 57 vehicle trips during the weekday evening peak hour. When compared to the existing uses on the site, this results in a net increase of 18 trips during the weekday morning peak hour and 23 trips during the weekday evening peak hour.

The peak hour trips are typically the most critical because those time periods are when the adjacent roadways experience the highest traffic demands throughout the course of the day. The peak hour increases represent

² Based on ITE LUC 932 – High Turnover Sit Down Restaurant (2,800 sf)

³ Based on ITE LUC 841 – Automobile Sales, Used (264 sf)

⁴ Based on ITE LUC 942 - Automobile Care Center (1,650 sf)

⁵ Based on ITE LUC 220 - Multi-Family Housing, Low-Rise (1 unit)

MEMORANDUM



approximately one additional trip every 2-4 minutes.


The trip generation estimates provided in Table 1 do not consider alternative modes of transportation such as walking, bicycling, and transit usage. Based on the location of the site and the proximity to two highly used MBTA bus routes (Routes #77 and #79), it is expected that a portion of the trips will be made by public transportation. It is also expected that a portion of the hotel-related trips will be made by taxi or ride-hailing service and will not use Clark Street for parking purposes. The following section discusses the mode shares for travel in the vicinity of the Project.

Modes of Travel

Mode-split data for the census tract in Arlington in which the Project site is located were obtained from the United States Census. The primary modes of travel for the Project are expected to be transit, walk/bicycling, and vehicular usage. The US Census provides travel mode shares over the course of an average weekday for commuting purposes only. However, the mode shares to provide an insight into the availability and convenience of non-vehicular modes of travel. The mode shares for the census tract in which the Project site is located are presented in **Figure 1**.

Figure 1
Modes of Travel

DAILY MODE SHARE ARLINGTON, MASSACHUSETTS

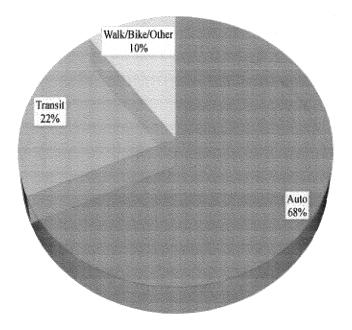

As shown in Figure 1, the predominant mode of commuting travel in this area of Arlington is by vehicle (68 percent). Transit trips account for approximately 22 percent of travel and the remaining 10 percent of trips are made by walking, biking, or other travel modes.

As previously stated, the mode shares represent daily commuting trips. It is expected that the hotel and restaurant usage of the Project will include taxi trips and may not exactly reflect commuting patterns. Additionally, the restaurant will serve the hotel guests and residents of the surrounding neighborhoods, allowing for a further reduction in vehicle-based trips. Further, the commuter mode share percentages do indicate that there are opportunities other than driving for guests of the hotel once they are on-site.

Summary

This evaluation indicates that the proposed development is expected to generate a minimal amount of vehicular traffic during the commuter peak hours (approximately one new trip every 3-4 minutes). The Project is expected to have a minimal impact on the surrounding roadway network throughout most of the day. The periods that will experience the most impact will occur mostly during off-peak hours. Hotels typically have check-in times in the early afternoon and check-out times in the late morning, which occur



MEMORANDUM

outside of commuter peaks. The restaurant will have the highest impacts after the weekday evening commuter peak hour when traffic volumes are typically lower.

The Project will provide on-site parking for 27 vehicles, which will be operated by the hotel's valet service. Self-parking will not be provided on the site. The parking will be valet-only and will be operated by te hotel. Right-turns from the parking area on to Clark Street northbound will not occur and the Project will have minimal impact to the residential neighborhood north of the site. All loading, trash servicing, and deliveries will occur on the Project site and will not have impacts to Massachusetts Avenue or Clark Street. As part of the Project, all adjacent sidewalks, crosswalks, and curb ramps will be upgraded in accordance with ADA standards.



Representation Project Checklist

Y ? N

credit Integrative Process

Project Name: Date:

 \vdash

Lexington Hotel

1/20/2020

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| × | | | credit High Priority Site | Ν |
| ĸ | | | credit Surrounding Density and Diverse Uses | Сī |
| × | | | credit Access to Quality Transit | (Ji |
| к | | | credit Bicycle Facilities | Ľ |
| ĸ | | | credit Reduced Parking Footprint | 1 |
| | | | credit Electric Vehicles | ┙ |

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| Light Pollution Reduction | Heat Island Reduction | Rainwater Management | Open Space | Protect or Restore Habitat | Site Assessment | Preseg Construction Activity Pollution Prevention | 0 0 0 Sustainable Sites |
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| 0 | 0 | 0 | Water | 0 0 0 Water Efficiency | |
|---|---|---|--------|------------------------------------|----------|
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| ĸ | | | Prereq | Building-Level Water Metering | Required |
| ۲ | | | Credit | Outdoor Water Use Reduction | |
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| | | | Credit | Cooling Tower Water Use | |
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| 1 | σ | 2 | 1 | 18 | თ | Required | Required | Required | Required | 33 |

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|----|---|---|---|--------|--|----------|
| 6 | к | | | Prereq | Storage and Collection of Recyclables | Required |
| 1 | к | | | Prereq | Construction and Demolition Waste Management Planning | Required |
| N | | | | Credit | Building Life-Cycle Impact Reduction | Сī |
| U1 | | | | Credit | Building Product Disclosure and Optimization - Environmental Product | 12 |
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| к | | Prereq | Minimum Indoor Air Quality Performance | Required |
| к | | Prereq | Environmental Tobacco Smoke Control | Required |
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| к | | Credit | Low-Emitting Materials | ω |
| | | Credit | Construction Indoor Air Quality Management Plan | щ |
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| к | | Credit | Thermal Comfort | Ъ |
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| Silver: 50 to 59 points, | |
| Gold: 60 to 79 points, | Possible Points: |
| Platinum | 110 |

SPECIAL PERMIT - SITE PLAN REVIEW

1211 Massachusetts Avenue Arlington, MA 02476

December 12, 2019



LINCON ARCHITECTS LLC

1 Mount Vernon Street, Suite 203
Winchester, MA 01890
781.721.7721

LOCUS PLAN



DRAWING LIST

ARCHITECTURAL

COVER SHEET

- L1.1 EXISTING CONDITION DIAGRAM
- L1.2 PROPOSED PLOT PLAN
- L1.3 SITE PLAN / LANDSCAPING PLAN
- A0.1 RENDERING IMAGE / VIEW FROM MASSACHUSETTS AVENUE
- A0.2 RENDERING IMAGE / BIRDS EYE VIEW FROM MASSACHUSETTS AVENUE
- A1.1 LOWER LEVEL/MAIN LEVEL FLOOR PLAN
- A1.2 SECOND & THIRD FLOOR PLAN/FOURTH FLOOR PLAN
- A4.1 BUILDING ELEVATIONS
- A4.2 BUILDING ELEVATIONS
- A5.1 EXISTING BUILDING SHADOW STYDY/SUMMER SOLSTICE
- A5.2 EXISTING BUILDING SHADOW STYDY/WINTER SOLSTICE
- A5.3 EXISTING BUILDING SHADOW STYDY/AUTUMN EQUINOX
- A5.4 EXISTING BUILDING SHADOW STYDY/SPRING EQUINOX
- A6.1 PROPOSED BUILDING SHADOW STYDY/SUMMER SOLSTICE
- A6.2 PROPOSED BUILDING SHADOW STYDY/WINTER SOLSTICE
- A6.3 PROPOSED BUILDING SHADOW STYDY/AUTUMN EQUINOX
- A6.4 PROPOSED BUILDING SHADOW STYDY/SPRING EQUINOX



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Revisions

PROPOSED HOTEL COMPLEX 1211 Massachusetts Avenue Arlington, MA


EXISTING CONDIRTIONS

Project Number 2017.032

Drawing Scale
1" = 20'

Drawn By **GMc**

Checked

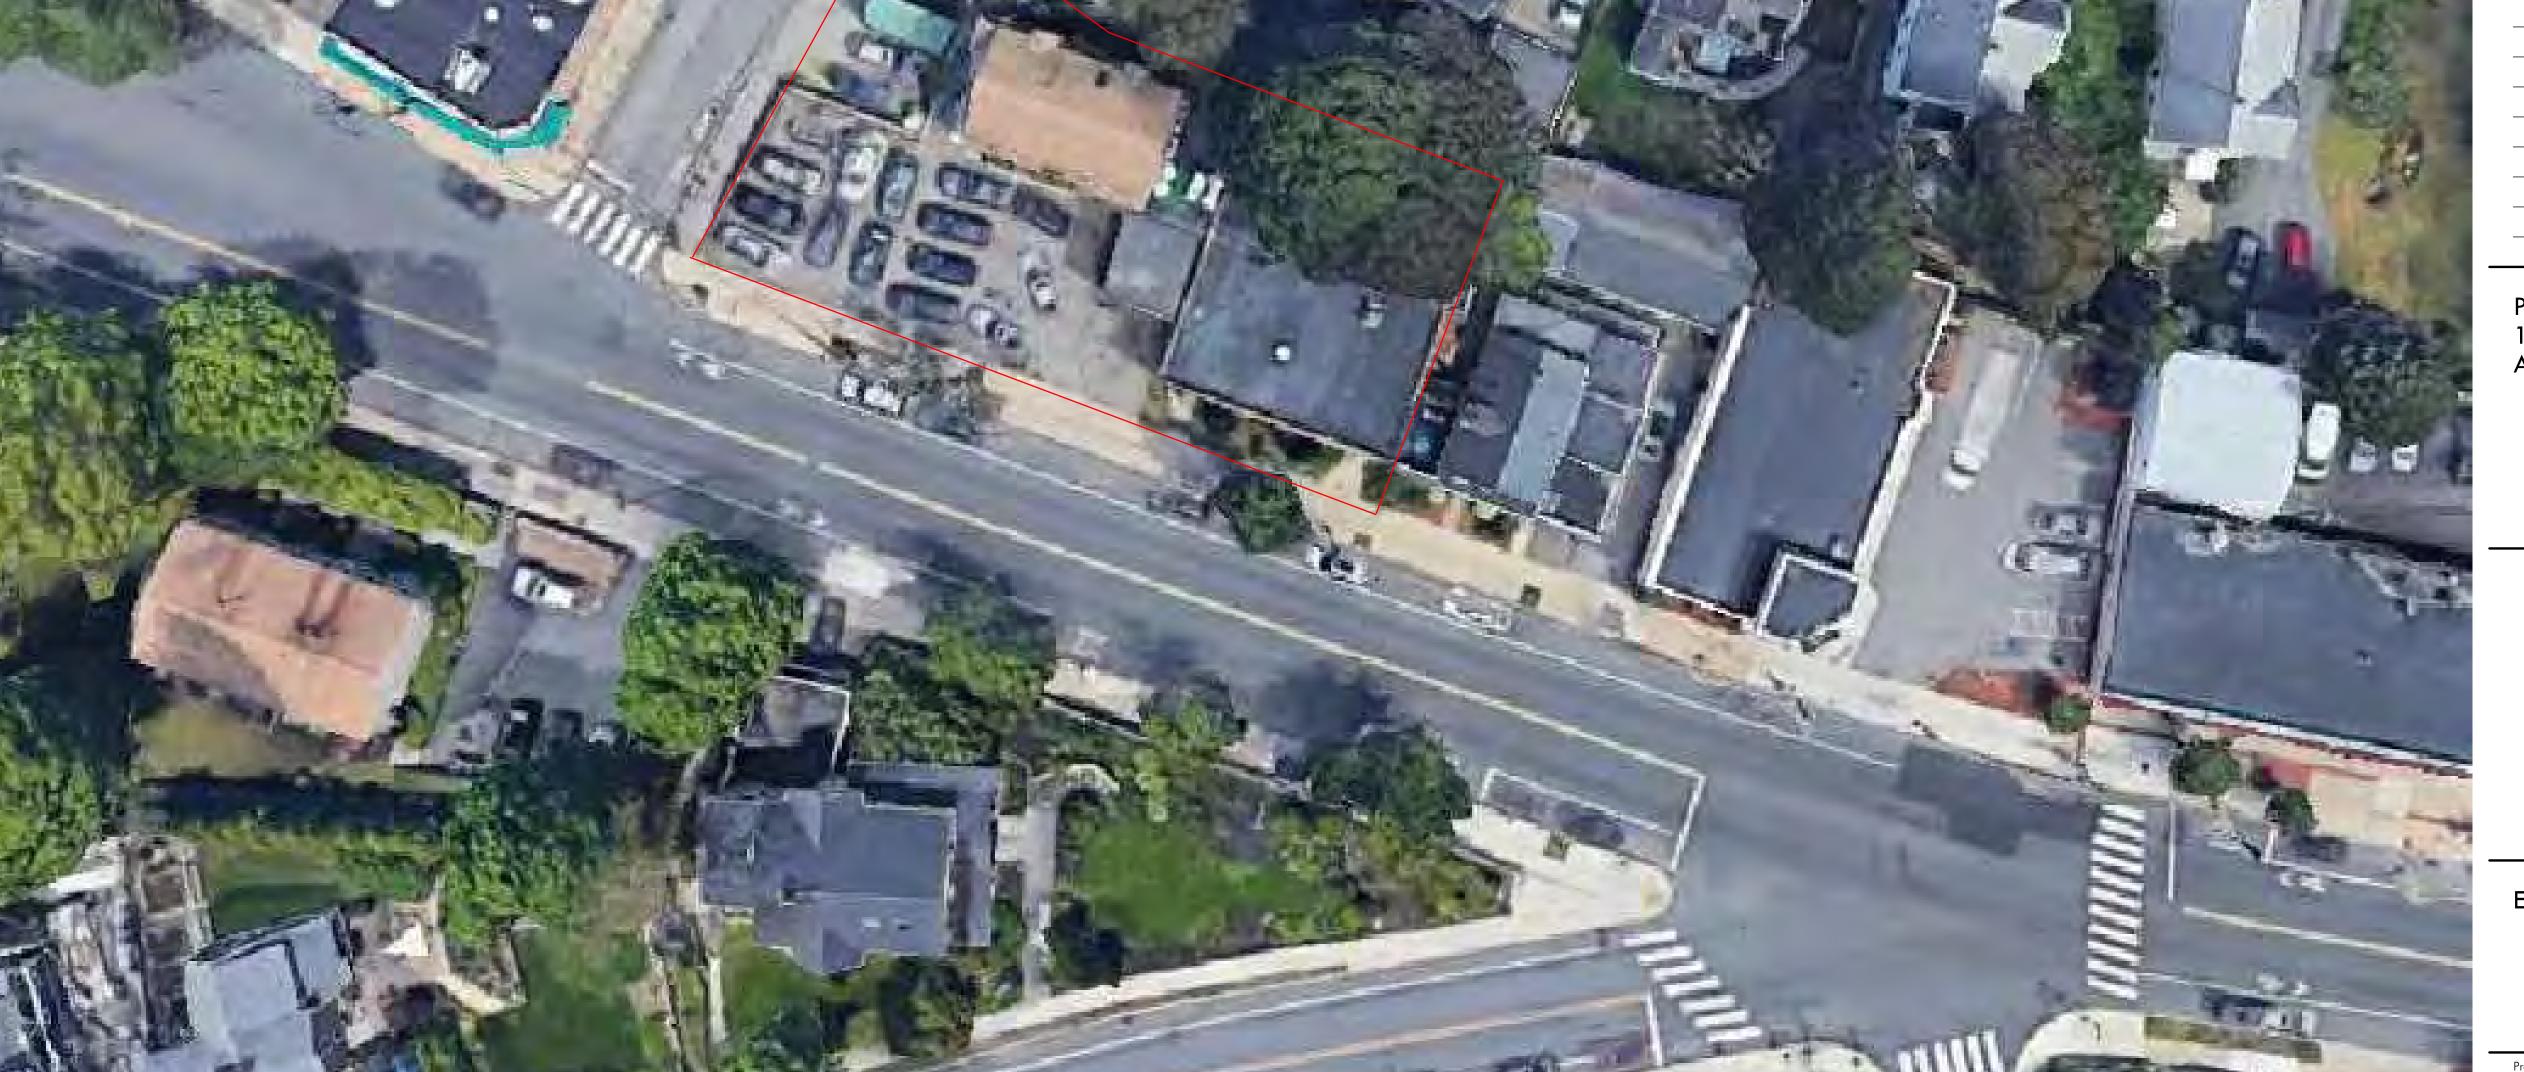



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Revisions

Arlington, MA

PROPOSED HOTEL COMPLEX
1211 Massachusetts Avenue


SITE PLAN

Project Number

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Drawn By GMc

Checked By GMc



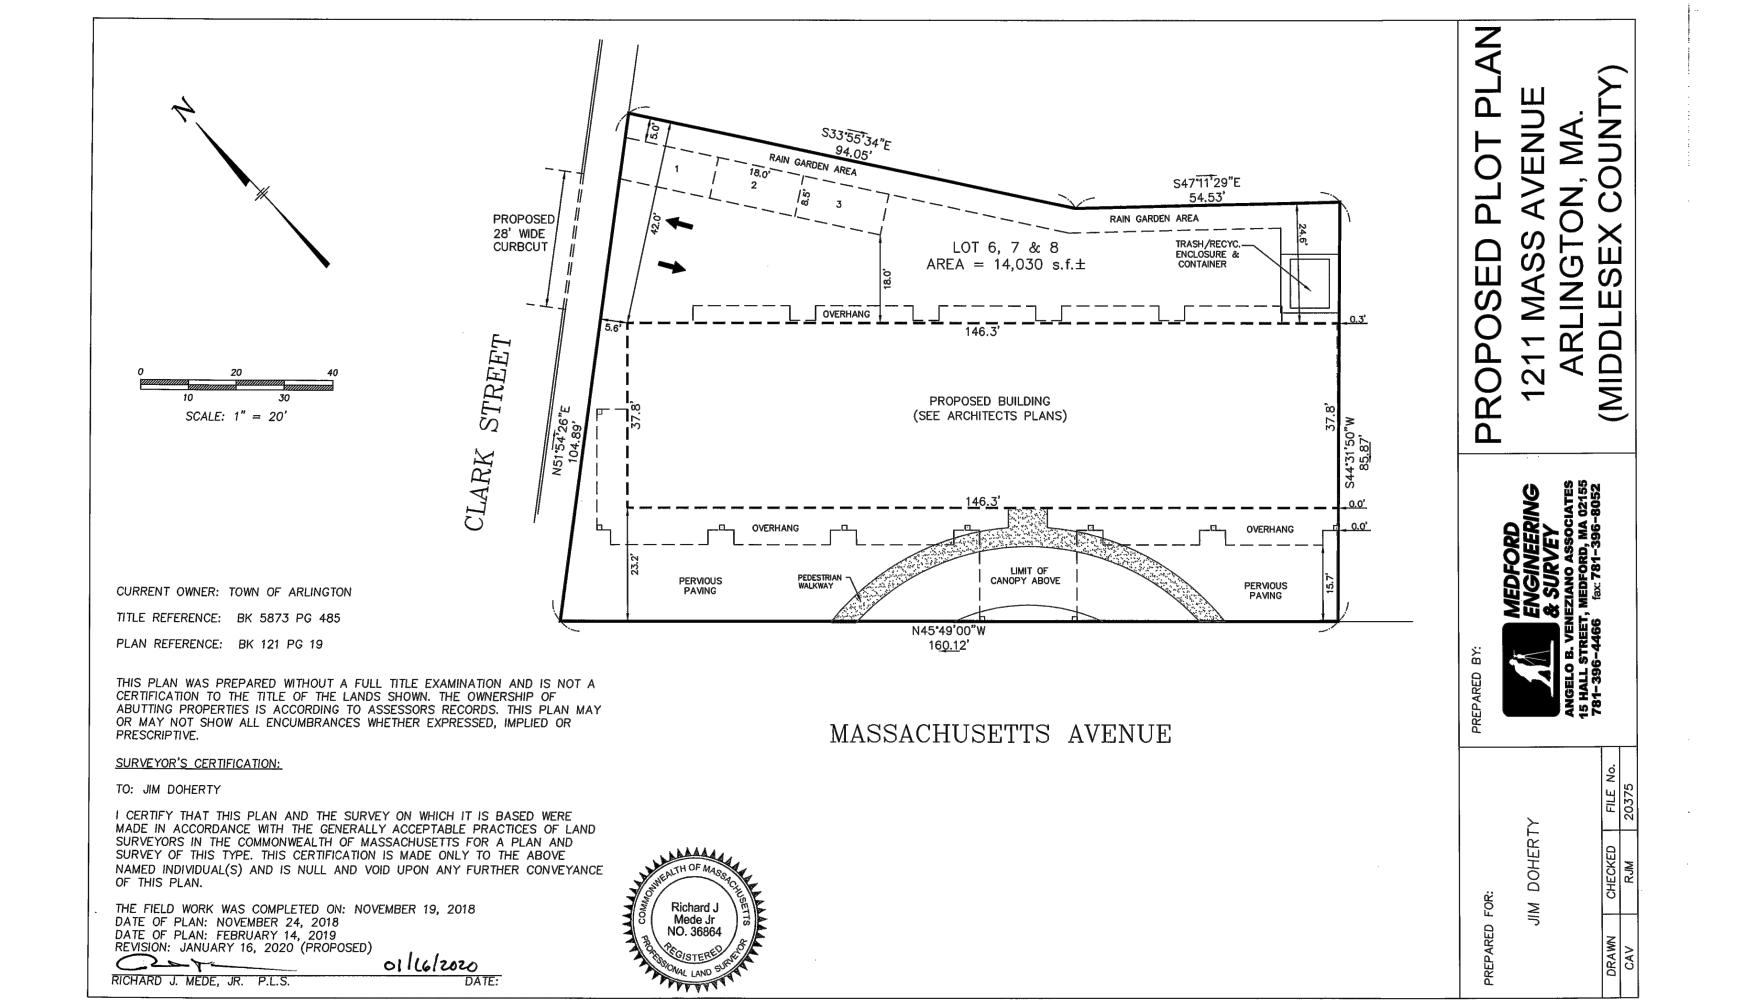

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PROPOSED HOTEL COMPLEX 1211 Massachusetts Avenue Arlington, MA

RENDERING

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PROPOSED HOTEL COMPLEX 1211 Massachusetts Avenue Arlington, MA

RENDERING

Project Number 2017.032

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Drawn B

Checked

GMc

Date Issued
12/12/19

A0.2





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| Revisions | | |
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PROPOSED HOTEL COMPLEX 1211 Massachusetts Avenue Arlington, MA

RENDERING STREET VIEW #1

Project Number 2017.032

Drawing

Drawn By

Checked By

Date Issued 12/12/19 A0.3





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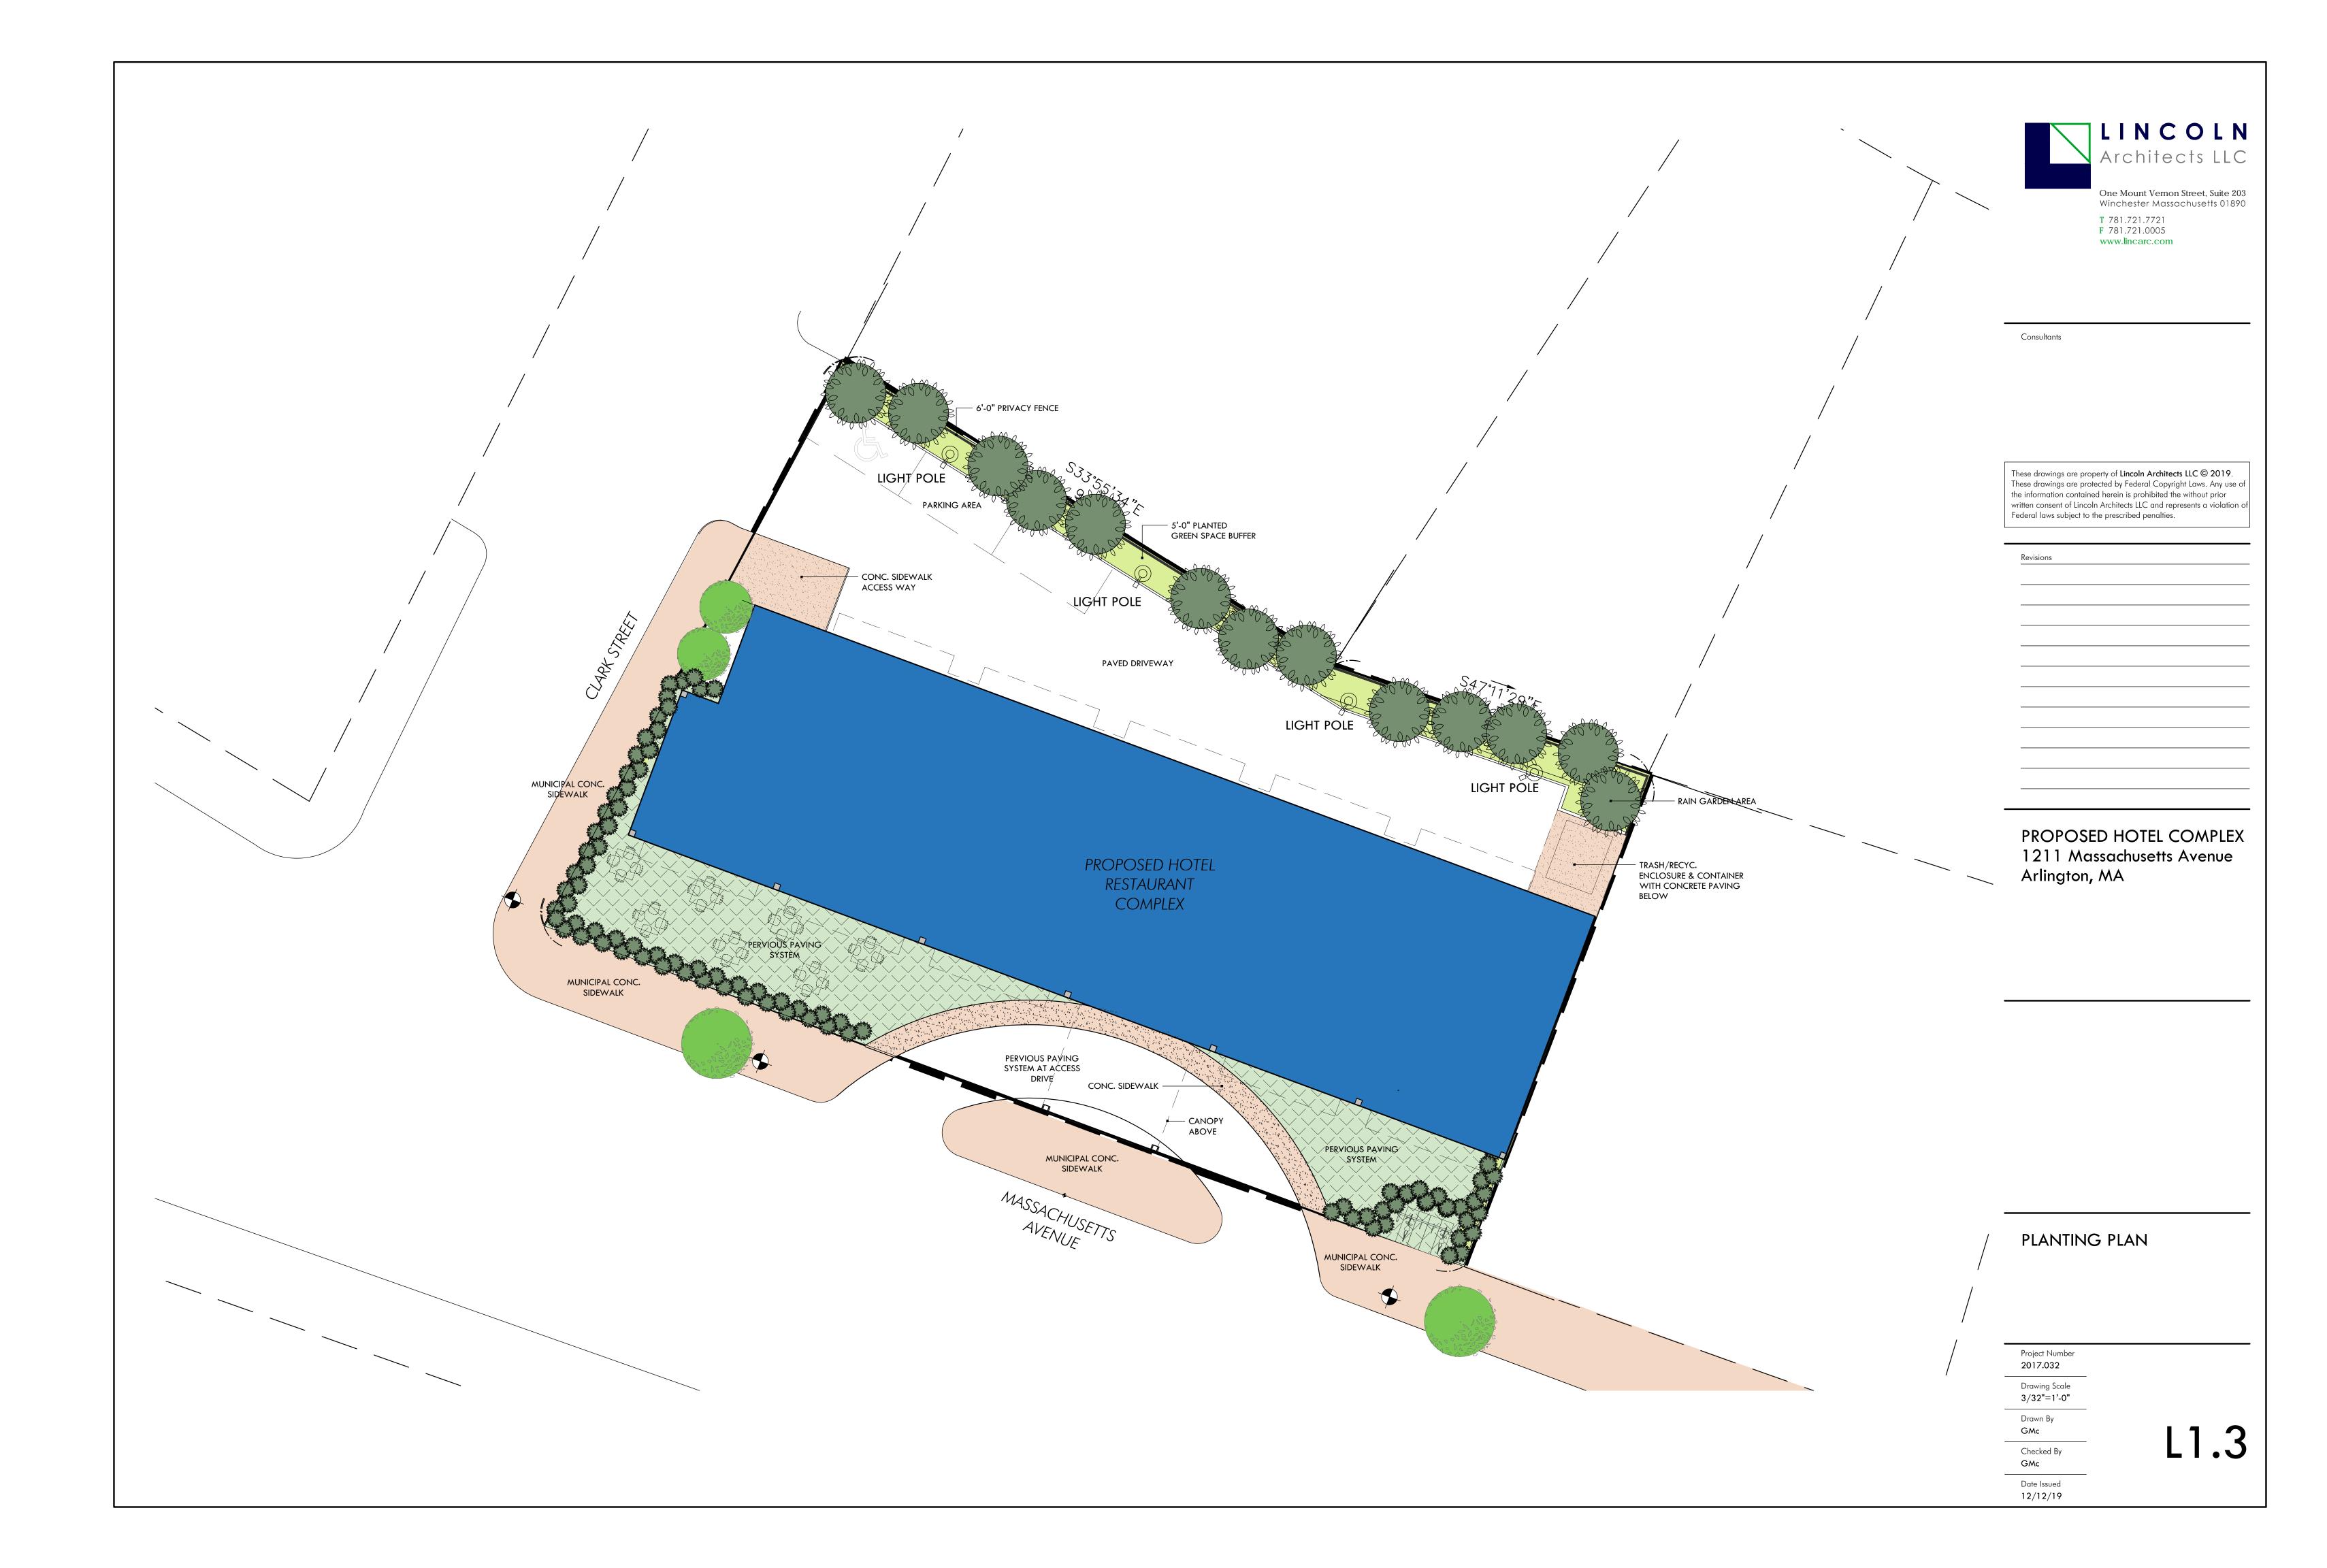
PROPOSED HOTEL COMPLEX 1211 Massachusetts Avenue Arlington, MA

RENDERING STREET VIEW #2

Project Number 2017.032


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2 FIRST FLOOR PLAN A1.1 SCALE: 3/32"=1'-0"



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PROPOSED HOTEL COMPLEX 1211 Massachusetts Avenue Arlington, MA

LOWER LEVEL FIRST FLOOR FLOOR PLANS

Project Number 2017.032
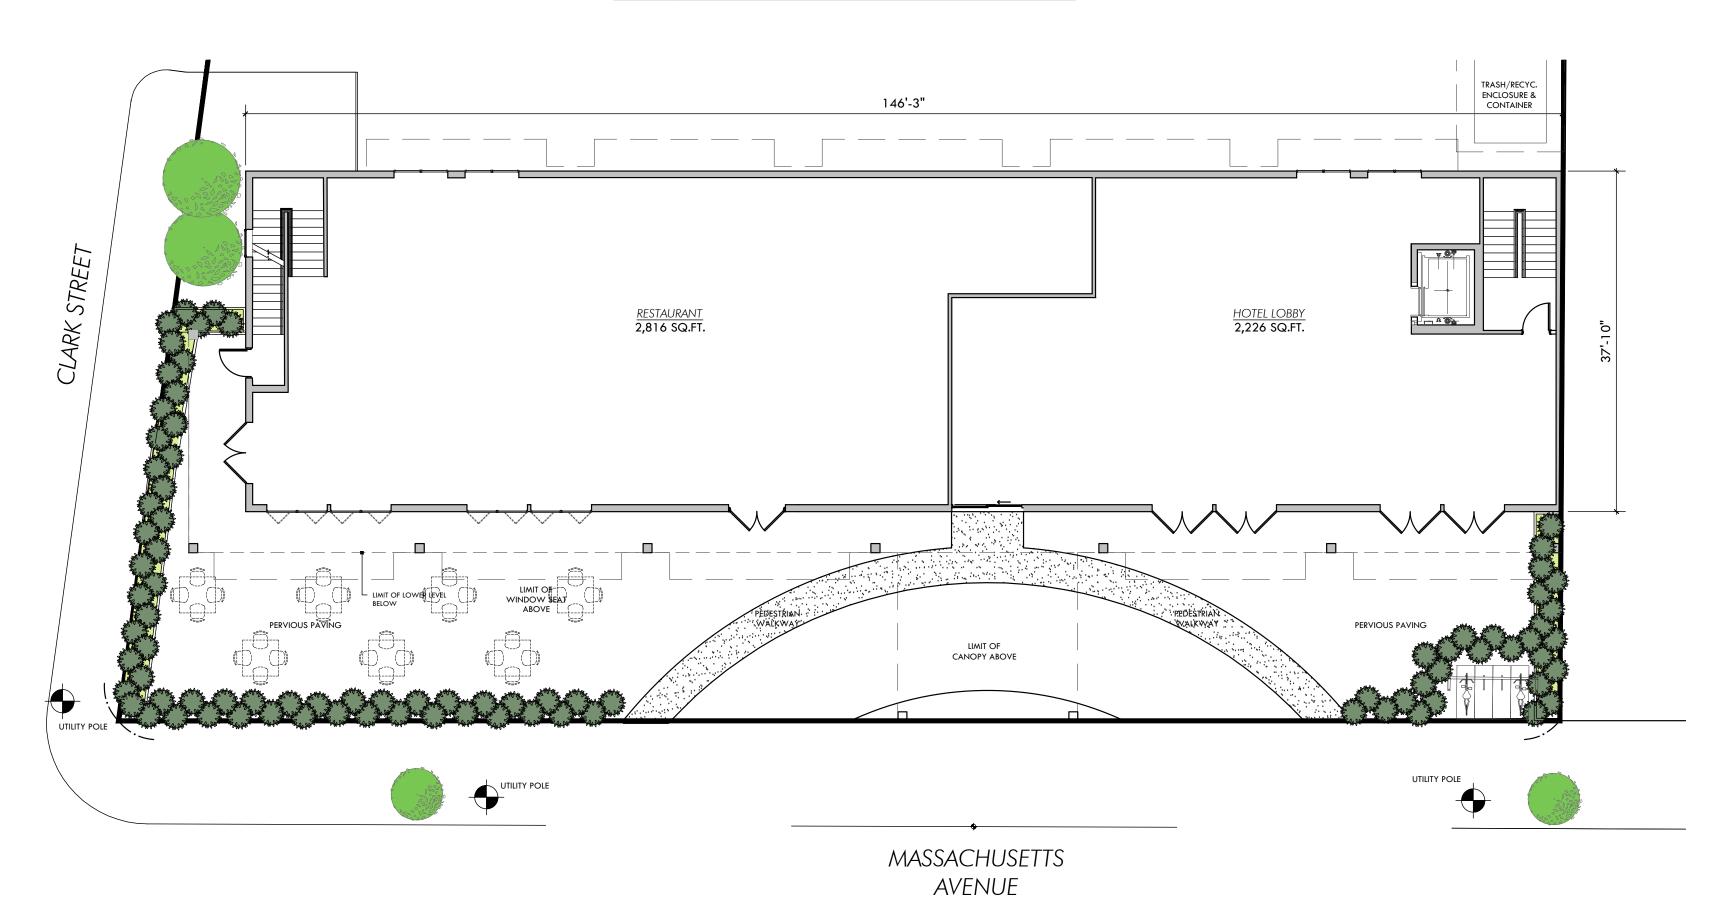
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PROPOSED HOTEL COMPLEX 1211 Massachusetts Avenue Arlington, MA

SECOND & THIRD FLOOR PLAN FOURTH FLOOR PLAN

Project Number 2017.032


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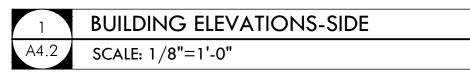
Date Issued 11/21/19

152'-2" SECOND & THIRD FLOOR PLAN SCALE: 3/32"=1'-0"







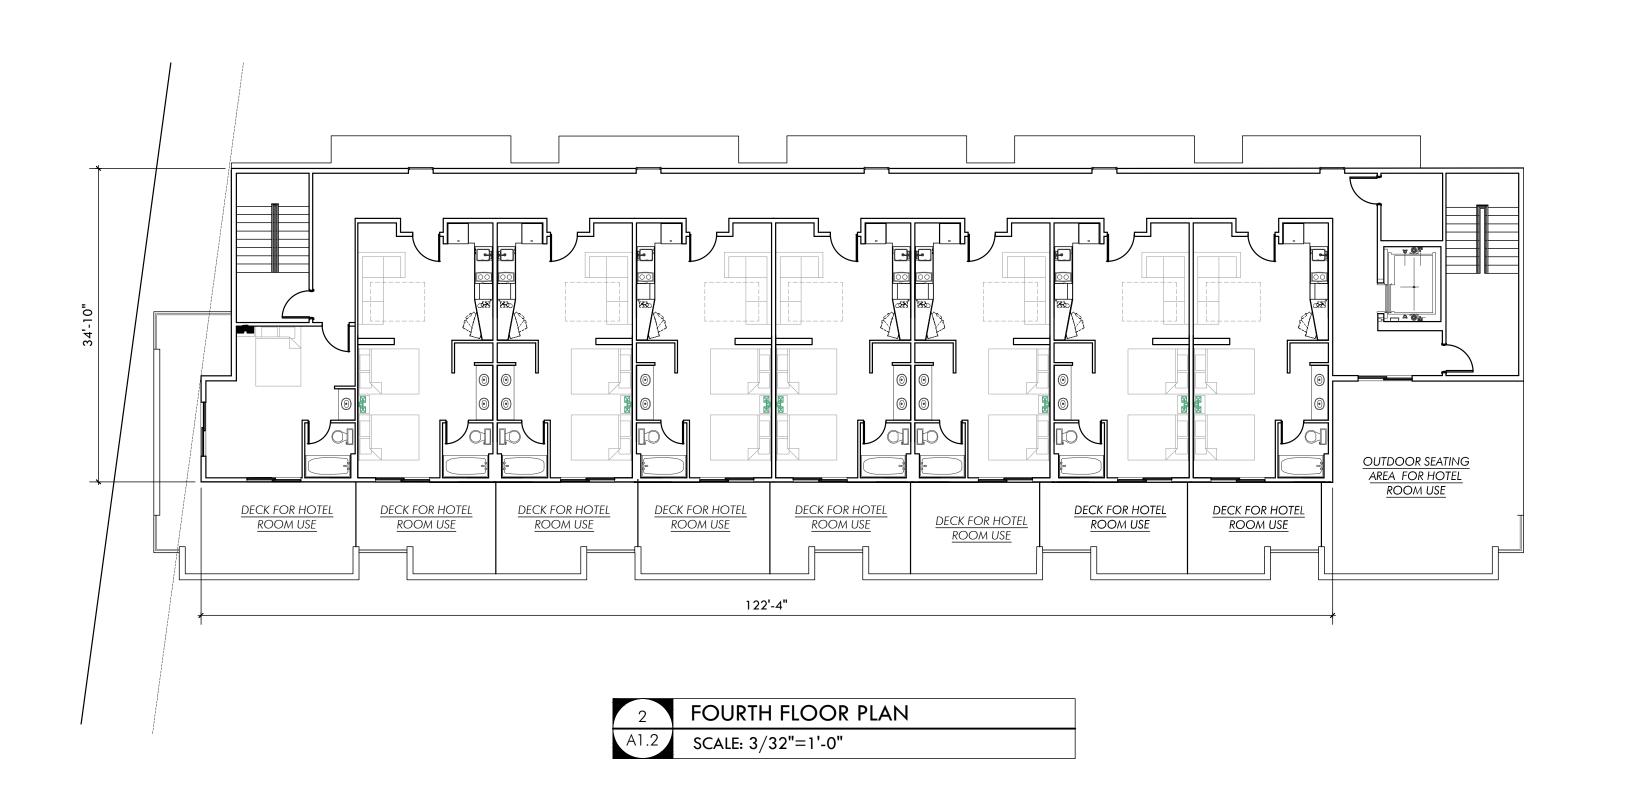



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PROPOSED HOTEL COMPLEX 1211 Massachusetts Avenue

Arlington, MA

BUILDING ELEVATIONS


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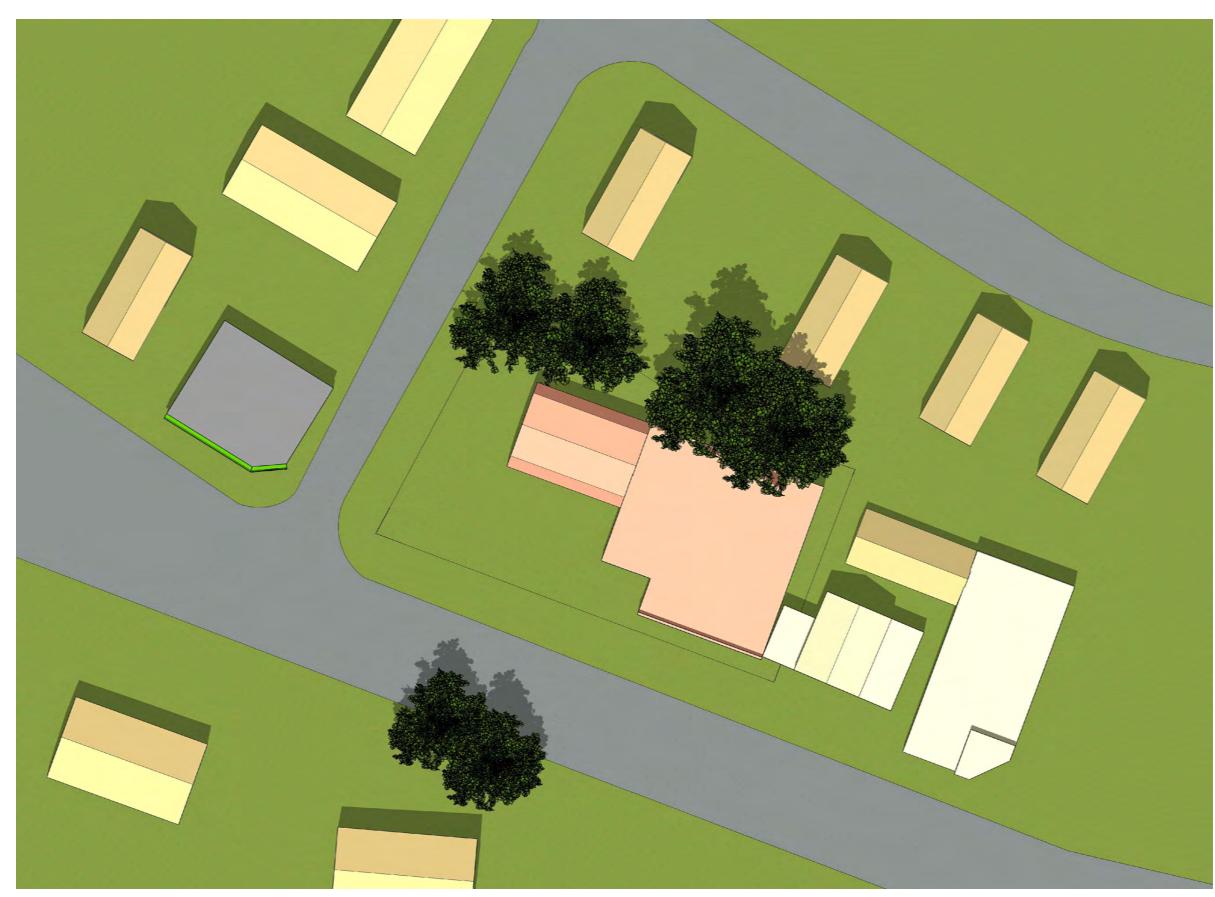
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PROPOSED HOTEL COMPLEX 1211 Massachusetts Avenue Arlington, MA

SHADOW STUDY EXISTING CONDITIONS SUMMER SOLSTICE

A5.1

Project Number 2017.032


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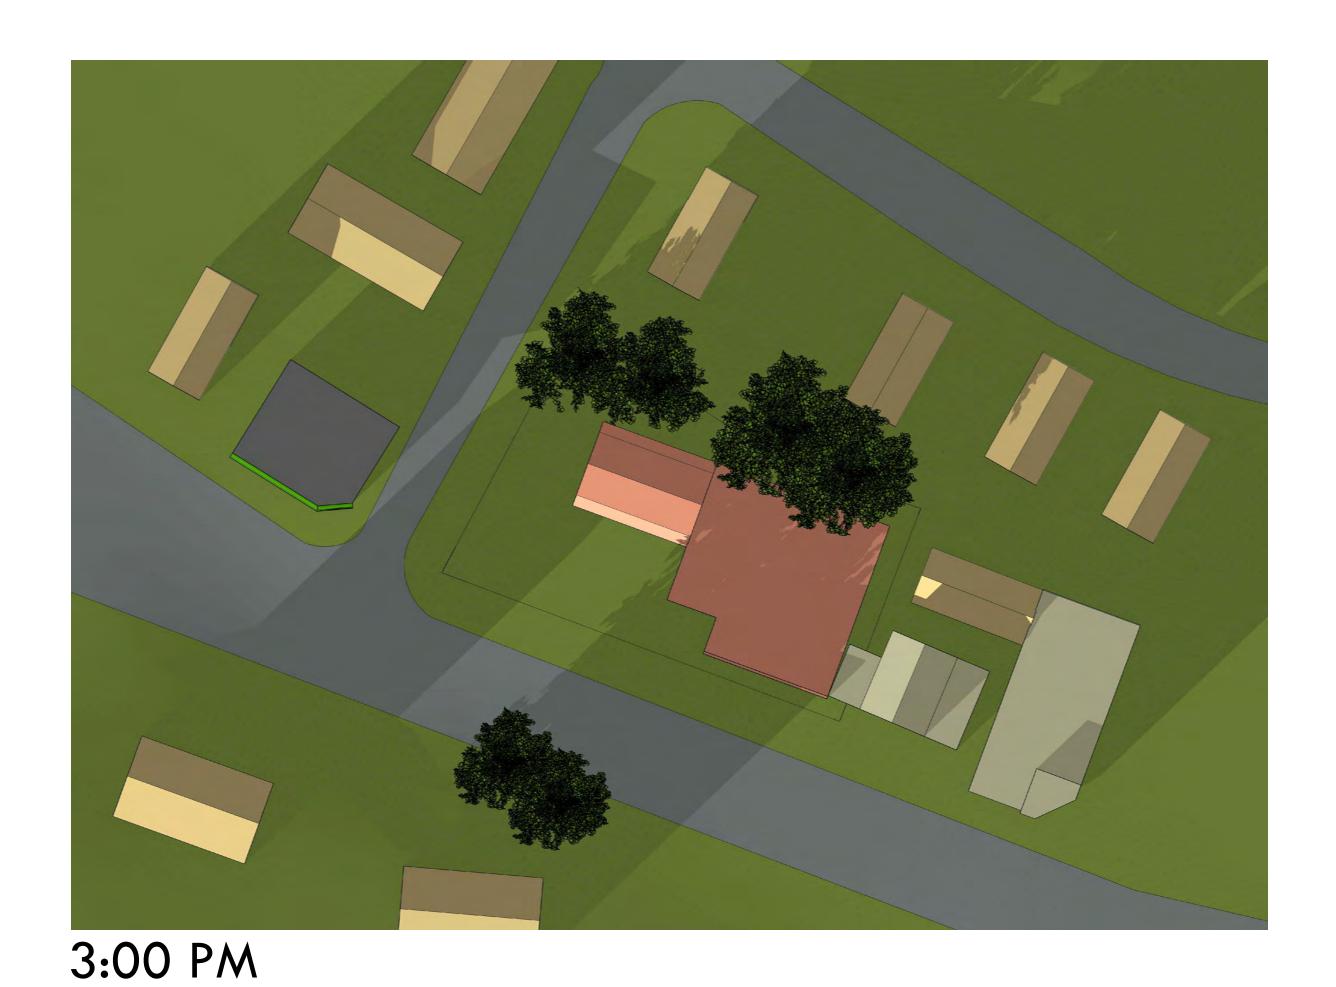
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PROPOSED HOTEL COMPLEX 1211 Massachusetts Avenue Arlington, MA

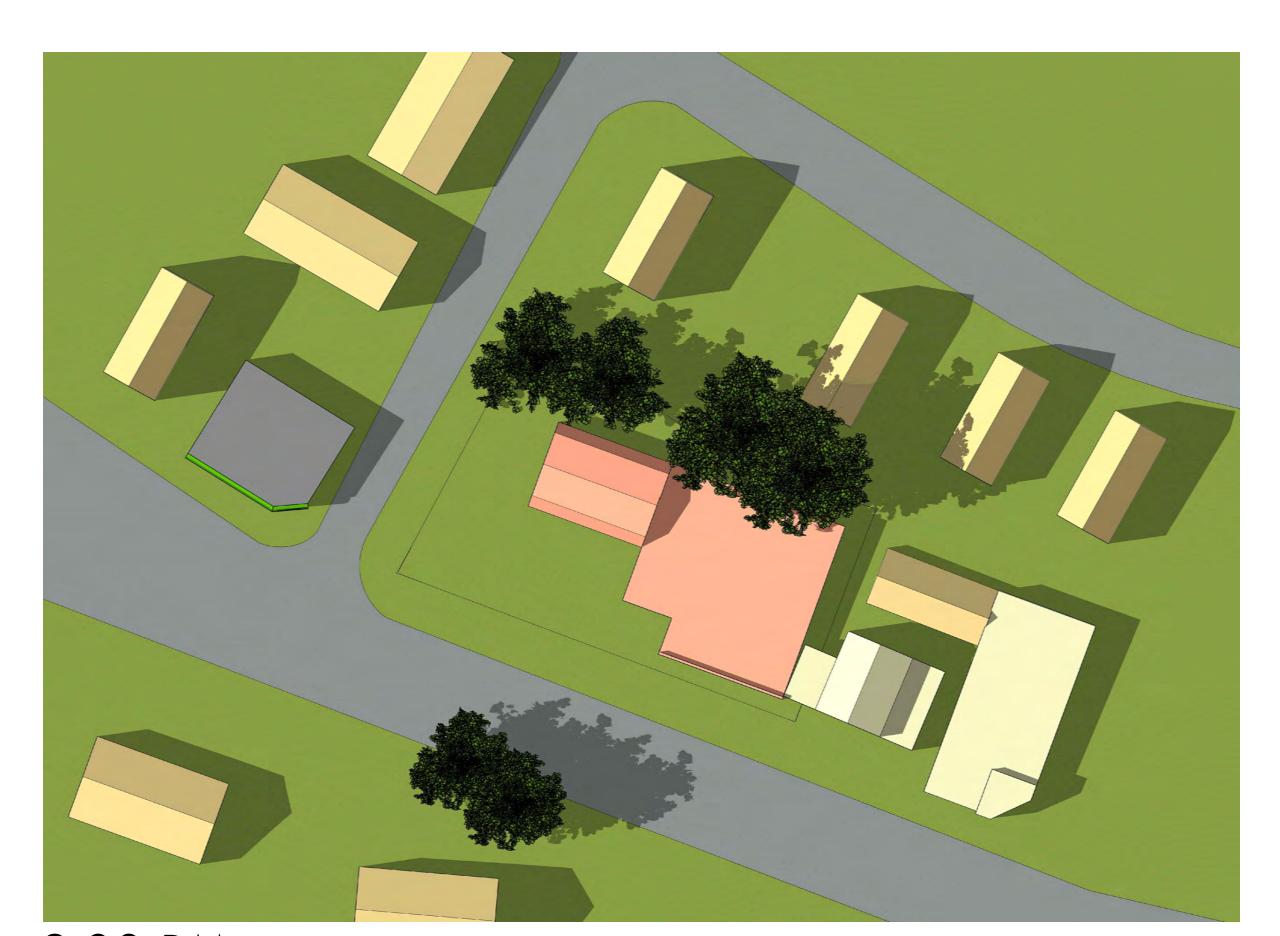

6:00 PM

SHADOW STUDY EXISTING CONDITIONS WINTER SOLSTICE

A5.2

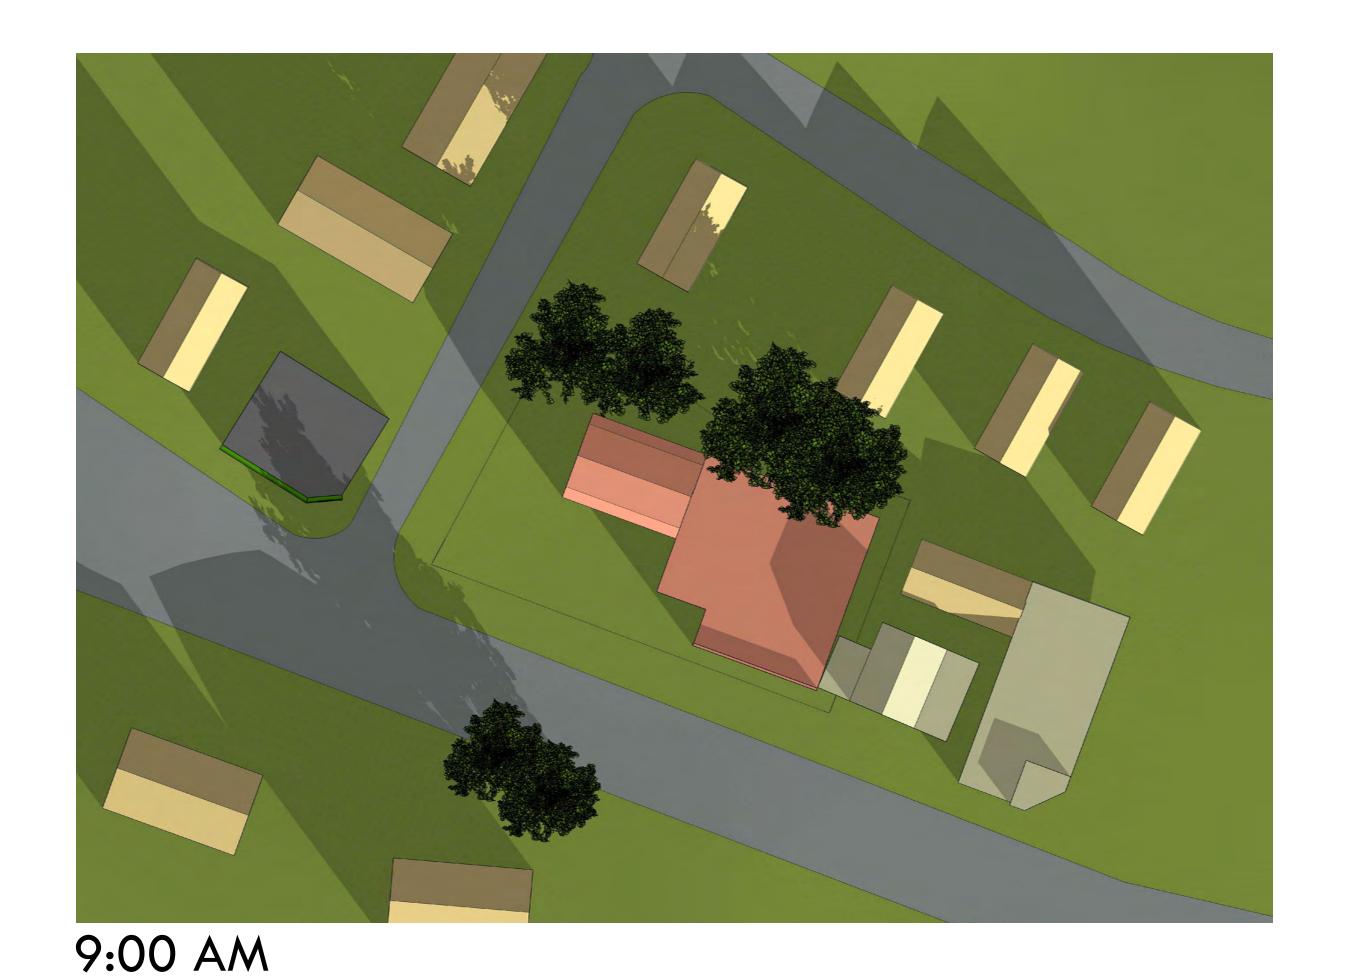Project Number 2017.032







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PROPOSED HOTEL COMPLEX 1211 Massachusetts Avenue Arlington, MA

SHADOW STUDY EXISTING CONDITIONS AUTUMN EQUINOX

| Project Num |
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| 2017.032 |

Date Issued 12/12/19

A5.3








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PROPOSED HOTEL COMPLEX 1211 Massachusetts Avenue Arlington, MA

SHADOW STUDY EXISTING CONDITIONS SPRING EQUINOX

Project Number 2017.032

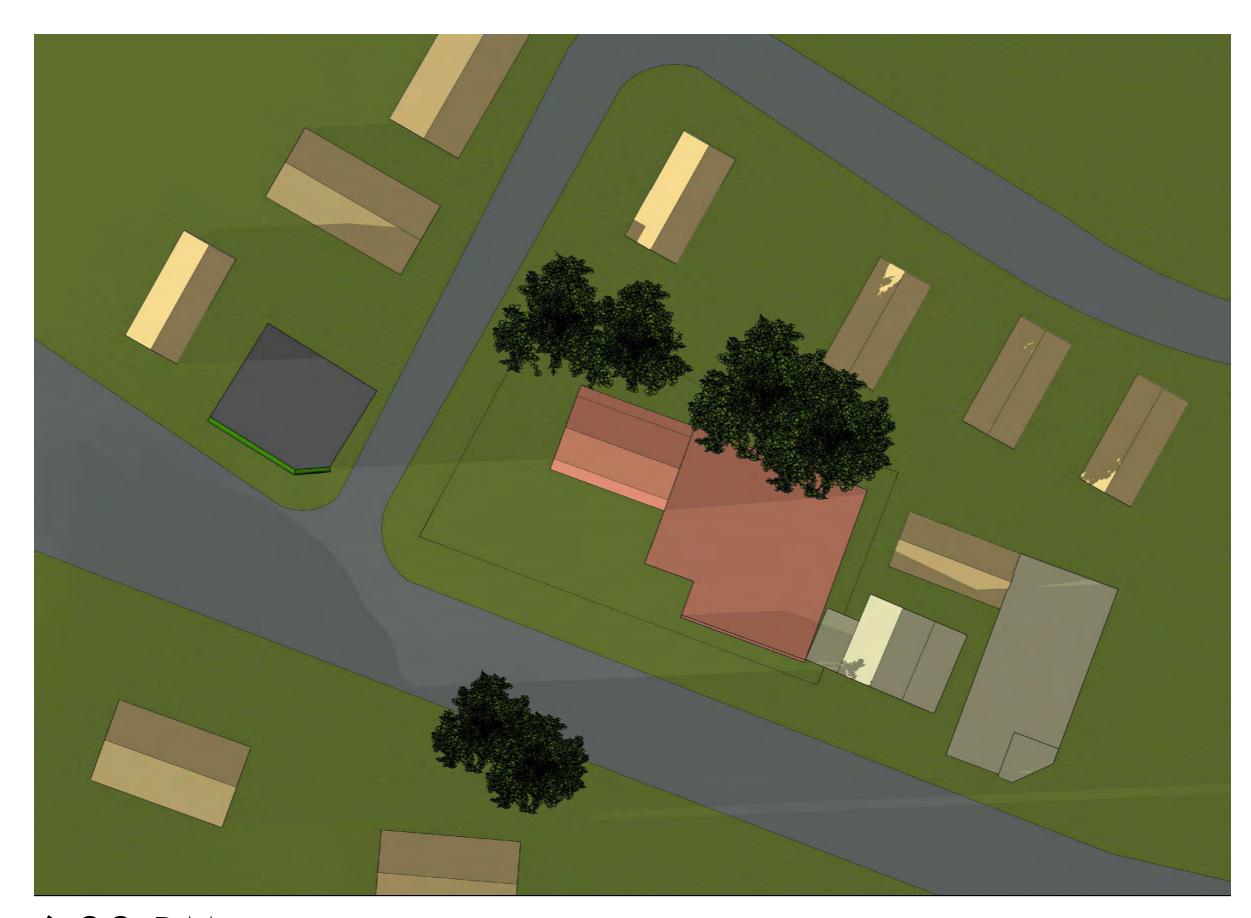Drawing Sc

Drawn By **GMc**

Checked By


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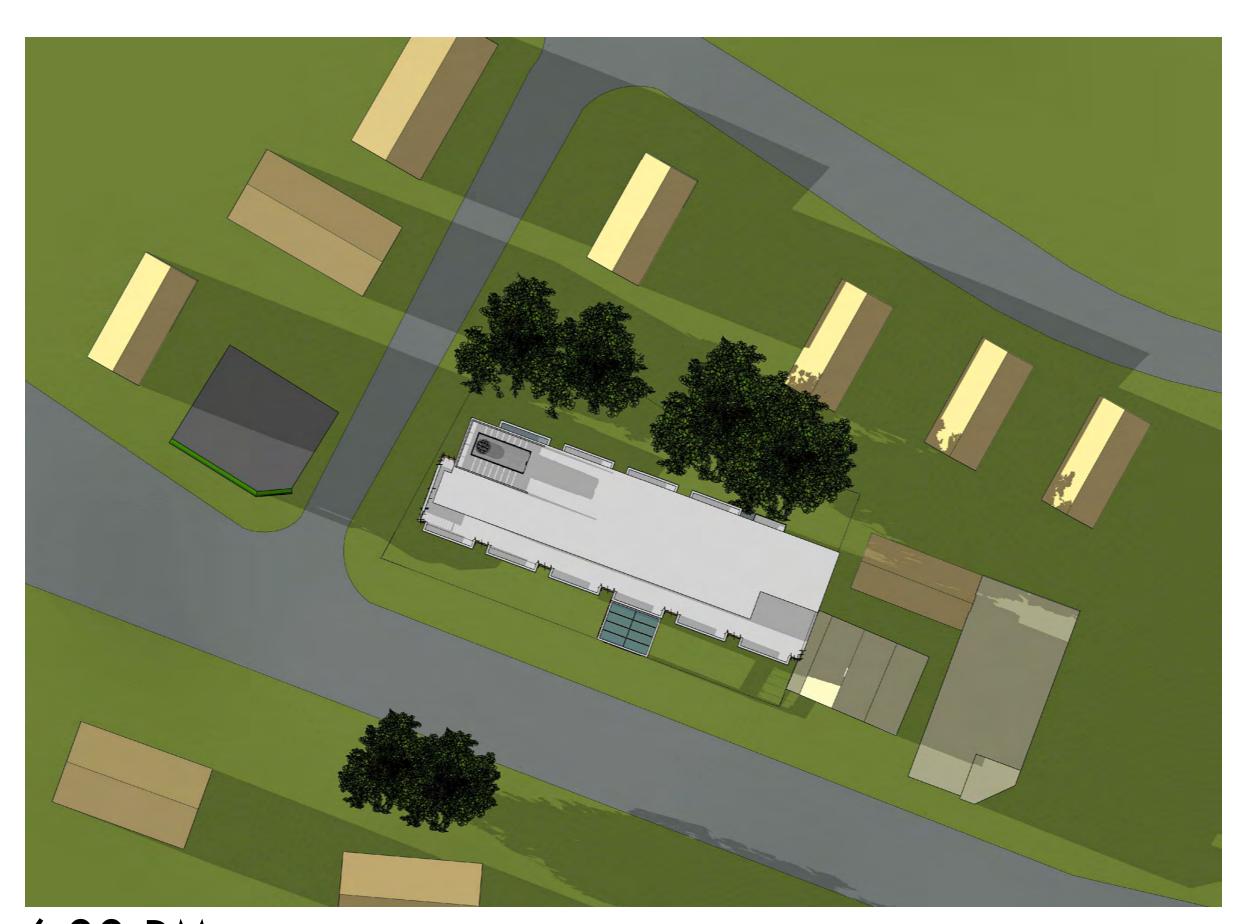




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PROPOSED HOTEL COMPLEX 1211 Massachusetts Avenue Arlington, MA

SHADOW STUDY PROPOSED BUILDING SUMMER SOLSTICE

| Project Num |
|-------------|
| 2017.032 |

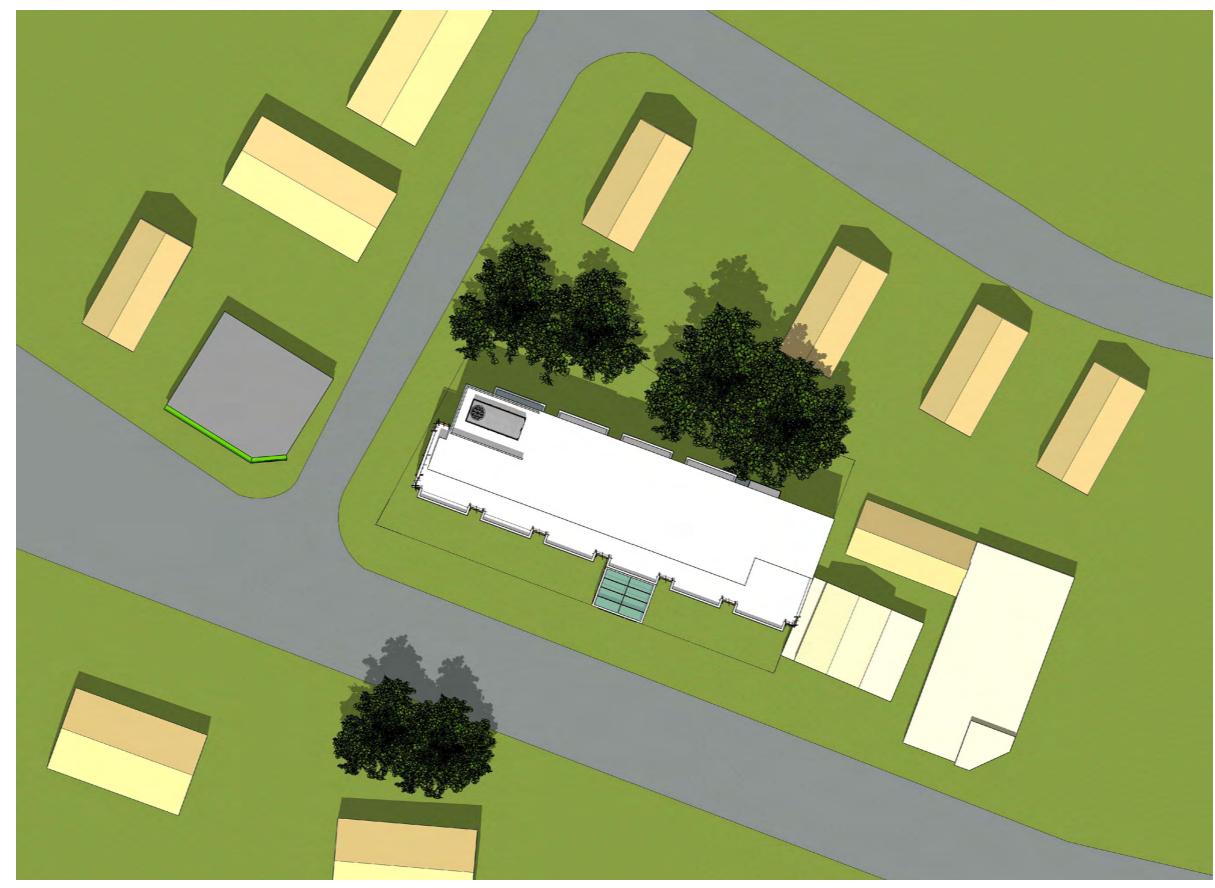Drawing Sc

Drawn By


GMc

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Date Issued 12/12/19 A6.1





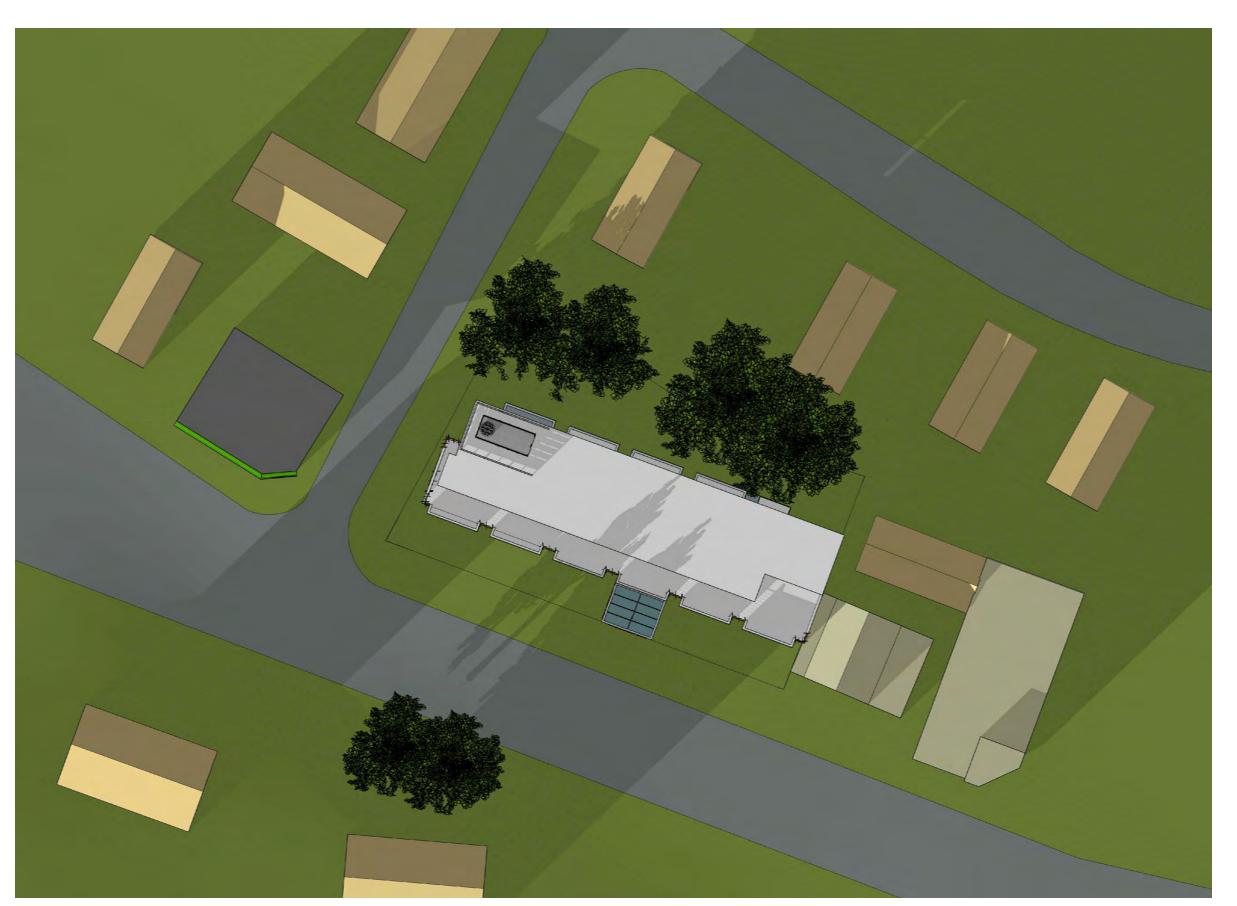

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PROPOSED HOTEL COMPLEX 1211 Massachusetts Avenue Arlington, MA

SHADOW STUDY PROPOSED BUILDING WINTER SOLSTICE

| Project Num |
|-------------|
| 2017.032 |

Date Issued 12/12/19

A6.2








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SHADOW STUDY PROPOSED BUILDING AUTUMN EQUINOX


| Project Num |
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| 2017.032 |

Drawing Sc

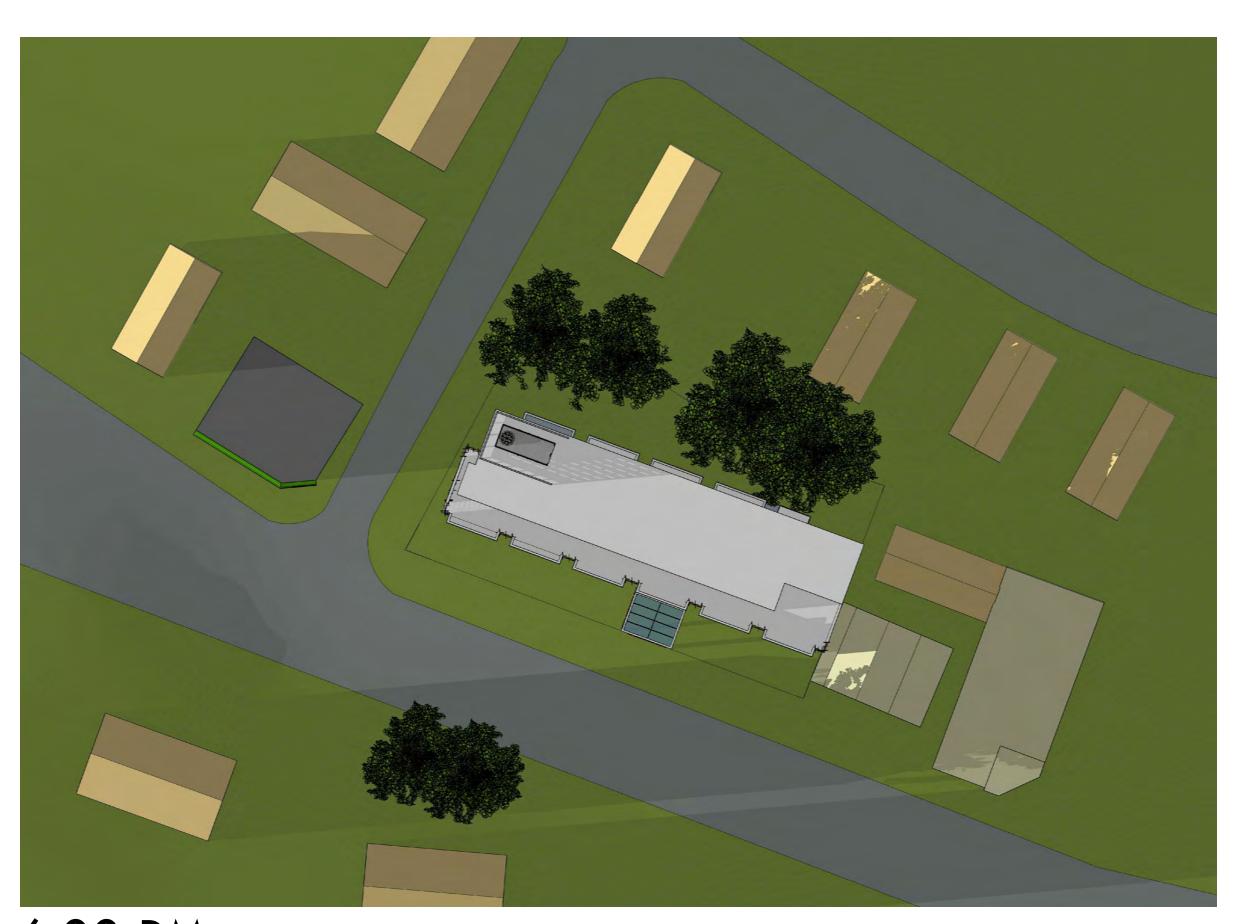Drawn By

GMc
Checked By

A6.3

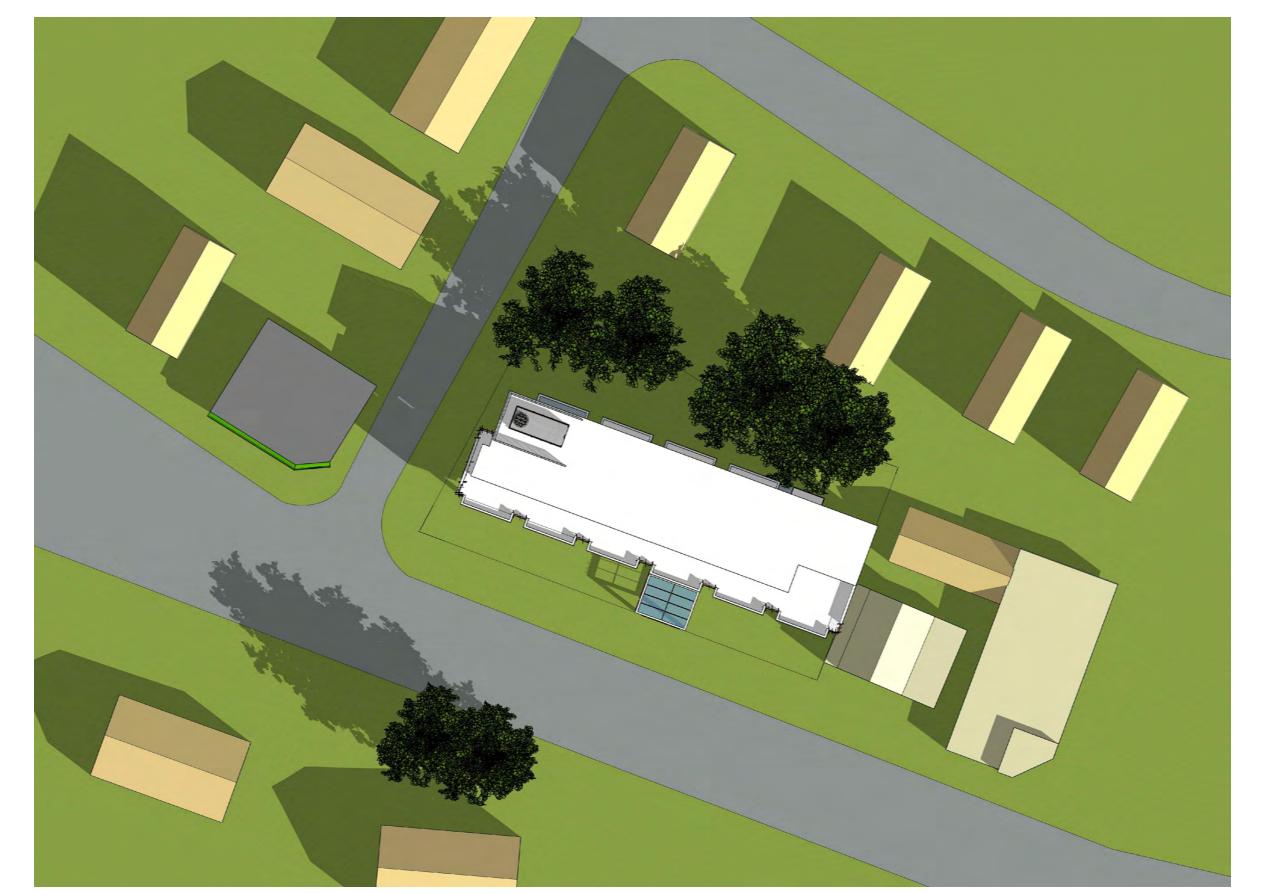










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PROPOSED HOTEL COMPLEX 1211 Massachusetts Avenue Arlington, MA

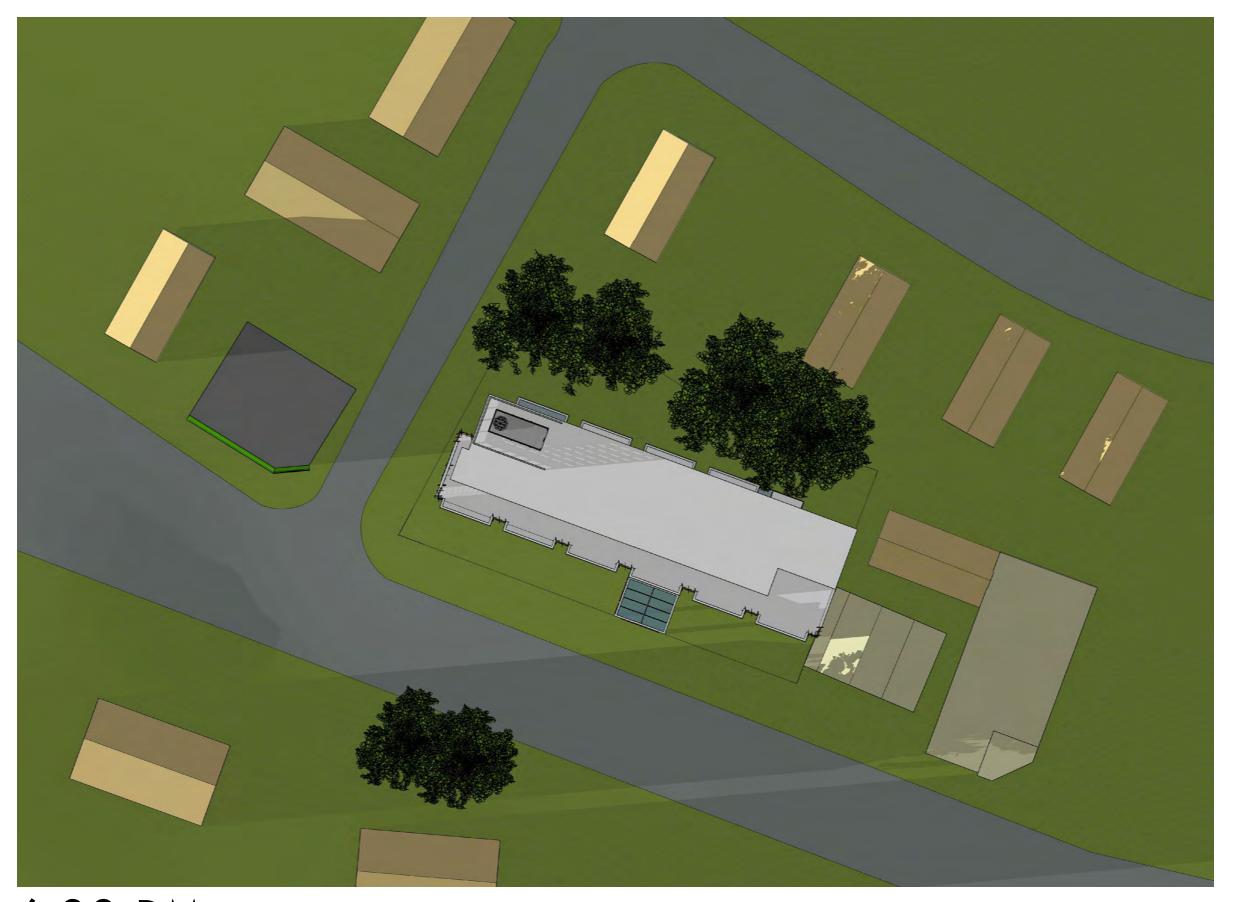SHADOW STUDY PROPOSED BUILDING SPRING EQUINOX

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