

TOWN OF ARLINGTON REDEVELOPMENT BOARD

Application for Special Permit In Accordance with Environmental Design Review Procedures (Section 3.4 of the Zoning Bylaw)

			Docket No
1.	Property Address <u>190 & 192-200 Mass</u>	sachusetts Ave	
	Name of Record Owner(s) 190-200 Mas	sachusetts Ave, LLC	Phone <u>781-654-6306</u>
	Address of Owner 455 Massachusetts	S Ave , Suite 1	, Arlington, MA 02474
	Street		City, State, Zip
2.	Name of Applicant(s) (if different than abo	ove) Same as above	
	Address		Phone
	Status Relative to Property (occupant, pure	chaser, etc.)	Phone
3.	Location of Property Map 6, Block 3,	Lots 1A and 1B	
	Asses	ssor's Block Plan, Block,	Lot No.
4.	Deed recorded in the Registry of deeds, Bo-or- registered in Land Registration Office	ook, Page, Cert. No. <u>3413N</u> , in	; Book <u>1362</u> , Page <u>16</u> 1376 27
5.	Present Use of Property (include # of dwe	lling units, if any) Retai	I, Service, Restaurant
	D	11:	lived Hee
6.	Proposed Use of Property (include # of dw	30	lixed-Use O Apartment Units & Retail or Restaurant
7.	Permit applied for in accordance with	_ 3.4 E	Environmental Design Review
	the following Zoning Bylaw section(s)		Dimensional and Density Regulations
			Mixed-Use >20,000SF)
		section(s) titl	le(s)
8.	·		any additional information that may aid the ARB in a feel you should be granted the requested permission.
	See Attached		, , ,
	000 / 111001100		
proper	pplicant states that <u>192-200 Massachusetts</u> ty in Arlington located at <u>190 & 192-200 M</u>	lassachusetts Ave	r -or- occupant -or- purchaser under agreement of the
of Ap	peals on a similar application regarding this	s property within the las	unfavorable action has been taken by the Zoning Boarst two years. The applicant expressly agrees to compan, either by the Zoning Bylaw or by the Redevelopment
 Signatu	re of Applicant(s)		<u> </u>
Address	3		Phone



Town of Arlington Redevelopment Board Application for Special Permit in accordance with Environmental Design Review (Section 3.4)

Required Submittals Checklist

Two full sets of materials and one electronic copy are required. A model may be requested. Review the ARB's Rules and Regulations, which can be found at arlingtonma.gov/arb, for the full list of required submittals.

X	Dimensional and Parking Information Form (see attached				
X	Site plan of proposal				
N/A	Model, if required				
X	Drawing of existing conditions				
X	Drawing of proposed structure				
X	Proposed landscaping. May be incorporated into site pla	n			
Χ	Photographs				
Χ	Impact statement				
N/A	Application and plans for sign permits				
X	Stormwater management plan (for stormwater management with new construction	ent during construction for projects			
FOR (OFFICE USE ONLY				
	_ Special Permit Granted	Date:			
	Received evidence of filing with Registry of Deeds	Date:			
	_ Notified Building Inspector of Special Permit filing	Date:			

TOWN OF ARLINGTON REDEVELOPMENT BOARD

Petition for Special Permit under Environmental Design Review (see Section 3.4 of the Arlington Zoning Bylaw for Applicability)

For projects subject to Environmental Design Review, (see Section 3.4), please submit a statement that completely describes your proposal, and addresses each of the following standards.

- Preservation of Landscape. The landscape shall be preserved in its natural state, insofar as practicable, by minimizing
 tree and soil removal, and any grade changes shall be in keeping with the general appearance of neighboring developed
 areas.
- 2. Relation of Buildings to Environment. Proposed development shall be related harmoniously to the terrain and to the use, scale, and architecture of existing buildings in the vicinity that have functional or visual relationship to the proposed buildings. The Arlington Redevelopment Board may require a modification in massing to reduce the effect of shadows on abutting property in an R0, R1 or R2 district or on public open space.
- 3. Open Space. All open space (landscaped and usable) shall be so designed as to add to the visual amenities of the vicinity by maximizing its visibility for persons passing the site or overlooking it from nearby properties. The location and configuration of usable open space shall be so designed as to encourage social interaction, maximize its utility, and facilitate maintenance.
- 4. Circulation. With respect to vehicular, pedestrian and bicycle circulation, including entrances, ramps, walkways, drives, and parking, special attention shall be given to location and number of access points to the public streets (especially in relation to existing traffic controls and mass transit facilities), width of interior drives and access points, general interior circulation, separation of pedestrian and vehicular traffic, access to community facilities, and arrangement of vehicle parking and bicycle parking areas, including bicycle parking spaces required by Section 8.13 that are safe and convenient and, insofar as practicable, do not detract from the use and enjoyment of proposed buildings and structures and the neighboring properties.
- 5. Surface Water Drainage. Special attention shall be given to proper site surface drainage so that removal of surface waters will not adversely affect neighboring properties or the public storm drainage system. Available Best Management Practices for the site should be employed, and include site planning to minimize impervious surface and reduce clearing and re-grading. Best Management Practices may include erosion control and storm water treatment by means of swales, filters, plantings, roof gardens, native vegetation, and leaching catch basins. Storm water should be treated at least minimally on the development site; that which cannot be handled on site shall be removed from all roofs, canopies, paved and pooling areas and carried away in an underground drainage system. Surface water in all paved areas shall be collected at intervals so that it will not obstruct the flow of vehicular or pedestrian traffic, and will not create puddles in the paved areas.

In accordance with Section 3.3.4, the Board may require from any applicant, after consultation with the Director of Public Works, security satisfactory to the Board to insure the maintenance of all storm water facilities such as catch basins, leaching catch basins, detention basins, swales, etc. within the site. The Board may use funds provided by such security to conduct maintenance that the applicant fails to do. The Board may adjust in its sole discretion the amount and type of financial security such that it is satisfied that the amount is sufficient to provide for the future maintenance needs.

- 6. Utility Service. Electric, telephone, cable TV and other such lines and equipment shall be underground. The proposed method of sanitary sewage disposal and solid waste disposal from all buildings shall be indicated.
- 7. Advertising Features. The size, location, design, color, texture, lighting and materials of all permanent signs and outdoor advertising structures or features shall not detract from the use and enjoyment of proposed buildings and structures and the surrounding properties. Advertising features are subject to the provisions of Section 6.2 of the Zoning Bylaw.

- 8. Special Features. Exposed storage areas, exposed machinery installations, service areas, truck loading areas, utility buildings and structures, and similar accessory areas and structures shall be subject to such setbacks, screen plantings or other screening methods as shall reasonably be required to prevent their being incongruous with the existing or contemplated environment and the surrounding properties.
- 9. Safety. With respect to personal safety, all open and enclosed spaces shall be designed to facilitate building evacuation and maximize accessibility by fire, police, and other emergency personnel and equipment. Insofar as practicable, all exterior spaces and interior public and semi-public spaces shall be so designed as to minimize the fear and probability of personal harm or injury by increasing the potential surveillance by neighboring residents and passersby of any accident or attempted criminal act.
- 10. Heritage. With respect to Arlington's heritage, removal or disruption of historic, traditional or significant uses, structures, or architectural elements shall be minimized insofar as practicable, whether these exist on the site or on adjacent properties.
- 11. Microclimate. With respect to the localized climatic characteristics of a given area, any development which proposes new structures, new hard-surface ground coverage, or the installation of machinery which emits heat, vapor, or fumes, shall endeavor to minimize, insofar as practicable, any adverse impact on light, air, and water resources, or on noise and temperature levels of the immediate environment.
- 12. Sustainable Building and Site Design. Projects are encouraged to incorporate best practices related to sustainable sites, water efficiency, energy and atmosphere, materials and resources, and indoor environmental quality. Applicants must submit a current Green Building Council Leadership in Energy and Environmental Design (LEED) checklist, appropriate to the type of development, annotated with narrative description that indicates how the LEED performance objectives will be incorporated into the project. [LEED checklists can be found at http://www.usgbc.org/DisplayPage.aspx?CMSPageID=220b]

In addition, projects subject to Environmental Design Review must address and meet the following Special Permit Criteria (see Section 3.3.3 of the Zoning Bylaw):

- 1. The use requested is listed as a special permit in the use regulations for the applicable district or is so designated elsewhere in this Bylaw.
- 2. The requested use is essential or desirable to the public convenience or welfare.
- 3. The requested use will not create undue traffic congestion or unduly impair pedestrian safety.
- 4. The requested use will not overload any public water, drainage or sewer system or any other municipal system to such an extent that the requested use or any developed use in the immediate area or in any other area of the Town will be unduly subjected to hazards affecting health, safety or the general welfare.
- 5. Any special regulations for the use as may be provided in this Bylaw are fulfilled.
- 6. The requested use will not impair the integrity or character of the district or adjoining districts, nor be detrimental to the health, morals, or welfare.
- 7. The requested use will not, by its addition to a neighborhood, cause an excess of the particular use that could be detrimental to the character of said neighborhood.

TOWN OF ARLINGTON

Dimensional and Parking Information for Application to The Arlington Redevelopment Board

Property Location 190 & 192-200 Massachusetts Ave

Zoning District B3

Owner: 192-200 Massachusetts Ave, LLC

Address: 455 Massachusetts Ave, Arlington, MA

Present Use/Occupancy: No. of Dwelling Units:

Uses and their gross square feet:

Retail, Service, Restaurant

1-Story 9,916 GSF

Proposed Use/Occupancy: No. of Dwelling Units:

Uses and their gross square feet:

Mixed-Use, 30 Apartment Units & Retail/Restaurant

4-Story Mixed-Use, 30,104+/- GSF

	Present Conditions	Proposed Conditions	Min. or Max. Required by Zoning for Proposed Use	
Lot Size	11,134 SF	11,134 SF	min. 20,000 SF	
Frontage	102.1 FT	102.1 FT	min. 50 FT	
Floor Area Ratio	0.9	2.7	max. 3.0	
Lot Coverage (%), where applicable	N/A	N/A	max	
Lot Area per Dwelling Unit (square feet)	N/A	348 SF	_{min.} 600	
Front Yard Depth (feet)	0 FT	0.6 FT	min. 0 FT	
Side Yard Width (feet) right side	0.6 FT	7.5 FT	min. 0 FT	
left side			min	
Rear Yard Depth (feet)	No rear yard	No rear yard	min. (H+L)/6	
Height			min	
Stories	1-STORY	4-STORY	stories 4-STORY	
Feet	20 FT +/-	45+/- FT	feet 50 FT	
Open Space (% of G.F.A.)			min	800 SF/19,065 SF (Res. Floor Area)
Landscaped (square feet) 97 SF/11,134 SF (lot area)	→ 0.9%	4.2 %	(s.f.) 10% 1,906 SF	19,065 SF (Res. Floor Area) X 0.10 =1,906 SF
Usable (square feet)	0 %	7.4 %	(s.f.)20% 3,813 SF	19,065 SF (Res. Floor
Parking Spaces (No.)	None	26	min. 44.7	Area) X 0.20 = 3,813 SF 1,409 / 19,065 SF
Parking Area Setbacks (feet), where applicable	0 FT	N/A	min. N/A	(Res. Floor Area)
Loading Spaces (No.)	N/A	N/A	min. N/A	
Type of Construction	NEW CONS	TRUCTION		
Distance to Nearest Building	12.0 FT	17.6 FT	min.	

Provide a lighting study / lighting details

- Include rear of building and ramp to parking garage
 - See updated plans
- Include info on lighting in tandem parking area
 - No lighting on the back of the building. Please reference plans for the light fixtures on other parts of the building.

Facade / exterior

- Provide more detail on elevations
 - o Include context -- abutting properties on Mass Ave, Lake, Chandler
 - We have included both existing conditions as well as the new proposed building in context with the surrounding area
 - Note louvers for air intake and exhaust on elevations
 - See updated plans
- Eliminate the arch / clock tower
 - o Yes, updated
- Look at pilaster height given that there is no longer a balcony at that location
 - Updated on plans
- Reduce brick parapets on 4th floor
 - o Updated on plans
- Consider granite base
 - Updated on the plans to now reflect the use of granite base
- Storefront opening up to courtyard from the restaurant
 - Updated on plans
- Adjust the building coloration with regard to the heaviness of gray facade and cornice detailing
 - Updated on plans
- Provide material samples
 - Providing
- Find a way to use more modern design/lines on the canopy over the residential entrance
 - Updated on plans
- Provide an additional rendering showing the view for someone traveling north on Chandler St.
 - o Yes, provided

Necessary roof details

- Center the mechanical on the roof, or at least move it away from the edge of the roof (maybe between the stairwell and elevator?)
 - o Yes, corrected.
- Show mechanical details on renderings and elevations
 - The mechanicals do now show up on the renderings from the street because they are not visible in the current location
- Need solar dimensions and roof dimensions
 - Updated on plans
- Add restaurant venting details on roof
 - Updated on plans

Clean up GFA and FAR calculations

- Include the math to show how you get to the numbers
 - Shown on the cover sheet
 - Clarify if the basement meets the definition of the basement based on the Zoning Bylaw for the purposes of calculating FAR / GFA
 - Per the Definition for a basement in the by-law:
 - A portion of a building partly below grade which has more than one half of its height measured from the finished floor to the finished ceiling above the finished grade of the ground adjoining the building.
 - A basement is not a story unless it's ceiling is four feet six inches above the average finished grade.
 - We then get to calculating FAR which is defined as follows:
 - The sum of the gross horizontal areas of all floors including basements as measured from the exterior faces of the exterior walls including basements except as excluded in 2 below.
 - That section excludes, from the calculation, accessory parking and our parking is an accessory to the residential units in the building and is not a separate garage which would be rented to individuals not related to the residential units.

Parking and garage details

- Provide dimensions of parking spaces
 - Updated on plans
- Provide details on driveway slope
 - Updated on plans
- Add screening to the parking area
 - Updated on plans
- Provide more bike parking -- 45 long-term spaces are required for residential; if provided in the garage by moving the utility closet, please try to do so without reducing the commercial area
 - Correct on the plans. We have moved most bike parking upstairs, for ease and convenience, and have more than the required amount.
- Need ceiling heights for the basement and a section of the building at the parking ramp
 - Yes, provided on the plans.
- Use inverted U bike racks or pole and hoop racks for exterior
 - Yes, provided (A&M: this is shown on Sheet C-502, detail #6 on civil plans)
- Details on garage door -- will there be audible warning signals?
 - Quiet rolling door, no audible signals, lights or sirens. Visible in the renderings and also set back off the street.
- Consider removing one row of the tandem parking and giving it back to the retail space (and potentially adding another retail space)
 - Evaluate the tradeoff between utility, bike parking, and retail
 - We removed all tandem spaces and gave some back to retail, some for bike parking, and some for trash removal.
 - Tenant space "B" now has a total space size of 1,819 SF, which is an increase of 277 SF as a result of getting rid of the tandem parking spaces and re-working the overall layout.
 - Tenant space "A" is now 3,032 SF, which is an increase of 302 SF

- Total commercial space increase is 579 SF
- Flip van access clearance area with the parking space access to the stair
 - Yes, corrected and shown on plans

Site


- Provide a calculation for the required rear yard setback so the board can determine if a waiver should be provided
 - Because there is a front yard on both Chandler and Lake Street, that would imply that the rear of the property would be a side yard.
- Provide a narrative related to the trash removal process
 - We have moved the trash upstairs as part of getting rid of the tandem parking. The trash removal service would wheel out the bins from the room.
- Detail the process for loading and unloading commercial tenants / moving trucks for residents
 - On the property there is room for trucks or residents to temporarily block the 4 surface parking spots. Realistically, I think people would load from Chandler, since it is one-way and 24' wide. We propose to work with the planning department as well as the select board to try and make one side of the street a loading zone, even if for limited hours. There is plenty of room for it and would solve loading issues both for the commercial and residential tenants. If this was a two way street it may be more difficult, but since it is a one way street it is a very logical and feasible solution. Currently from our property all the way up to Mass Ave there are signs prohibiting parking.
- Can the transformer be moved somewhere other than the rear yard setback?
 - We have re-studied this and truly this is the only practical place for it. We have provided extra screening and landscaping.
- Trees being planted by the proponent -- will irrigation system be provided?
 - No irrigation, by hand as necessary
- Alleyway -- is buffer a fence or stockade fence or all plantings
 - Yes, please see updated rendering in context looking at the rear of the property (A&M: the rendering shows a brick base to the fence. Is this what is proposed or just PVC screen fence).

Submit a TDM plan along with the request for a reduction in parking

- Unbundle parking from rent
- Add additional hanging bike racks above cars on the wall
- We would like to propose for the last portion of the TDM plan that we work administratively with the planning department. Our 3rd option we would like to gear towards our commercial tenants such as subsidized public transportation for employees or something along those lines, however, it is more helpful for us as well as the tenant to work through that once we have someone moving in to make sure whatever we do propose is helpful and desirable for their business.

Consider providing a green roof at the step back

Provided

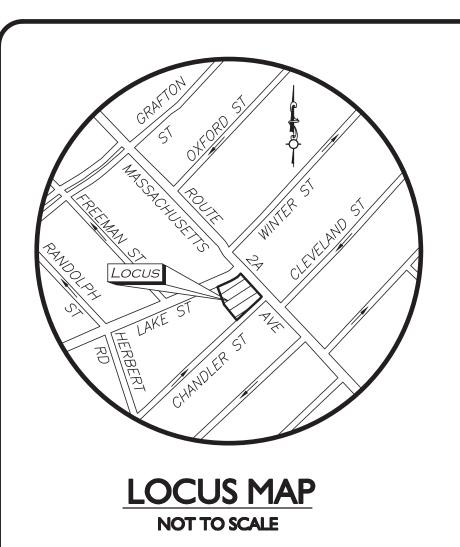


I 90 & I 92-200 MASSACHUSETTS AVE

ARLINGTON, MA 02476 MAP 6, BLOCK 3, LOTS 1A & 1B

APPLICANT: 192-200 MASSACHUSETTS AVE, LLC 452 MASSACHUSETTS AVE, STE 1 ARLINGTON, MA 02474 781.654.6306

ARCHITECT:
DAVID BARSKY-ARCHITECT AIA
320 NEVADA STREET, SUITE 301
NEWTON, MA 02460
617.448.5872


CIVIL ENGINEER, LANDSCAPE ARCHITECT & LAND SURVEYOR:
ALLEN & MAJOR ASSOCIATES, INC.
100 COMMERCE WAY, SUITE 5
WOBURN, MA 01801
781.985.6889

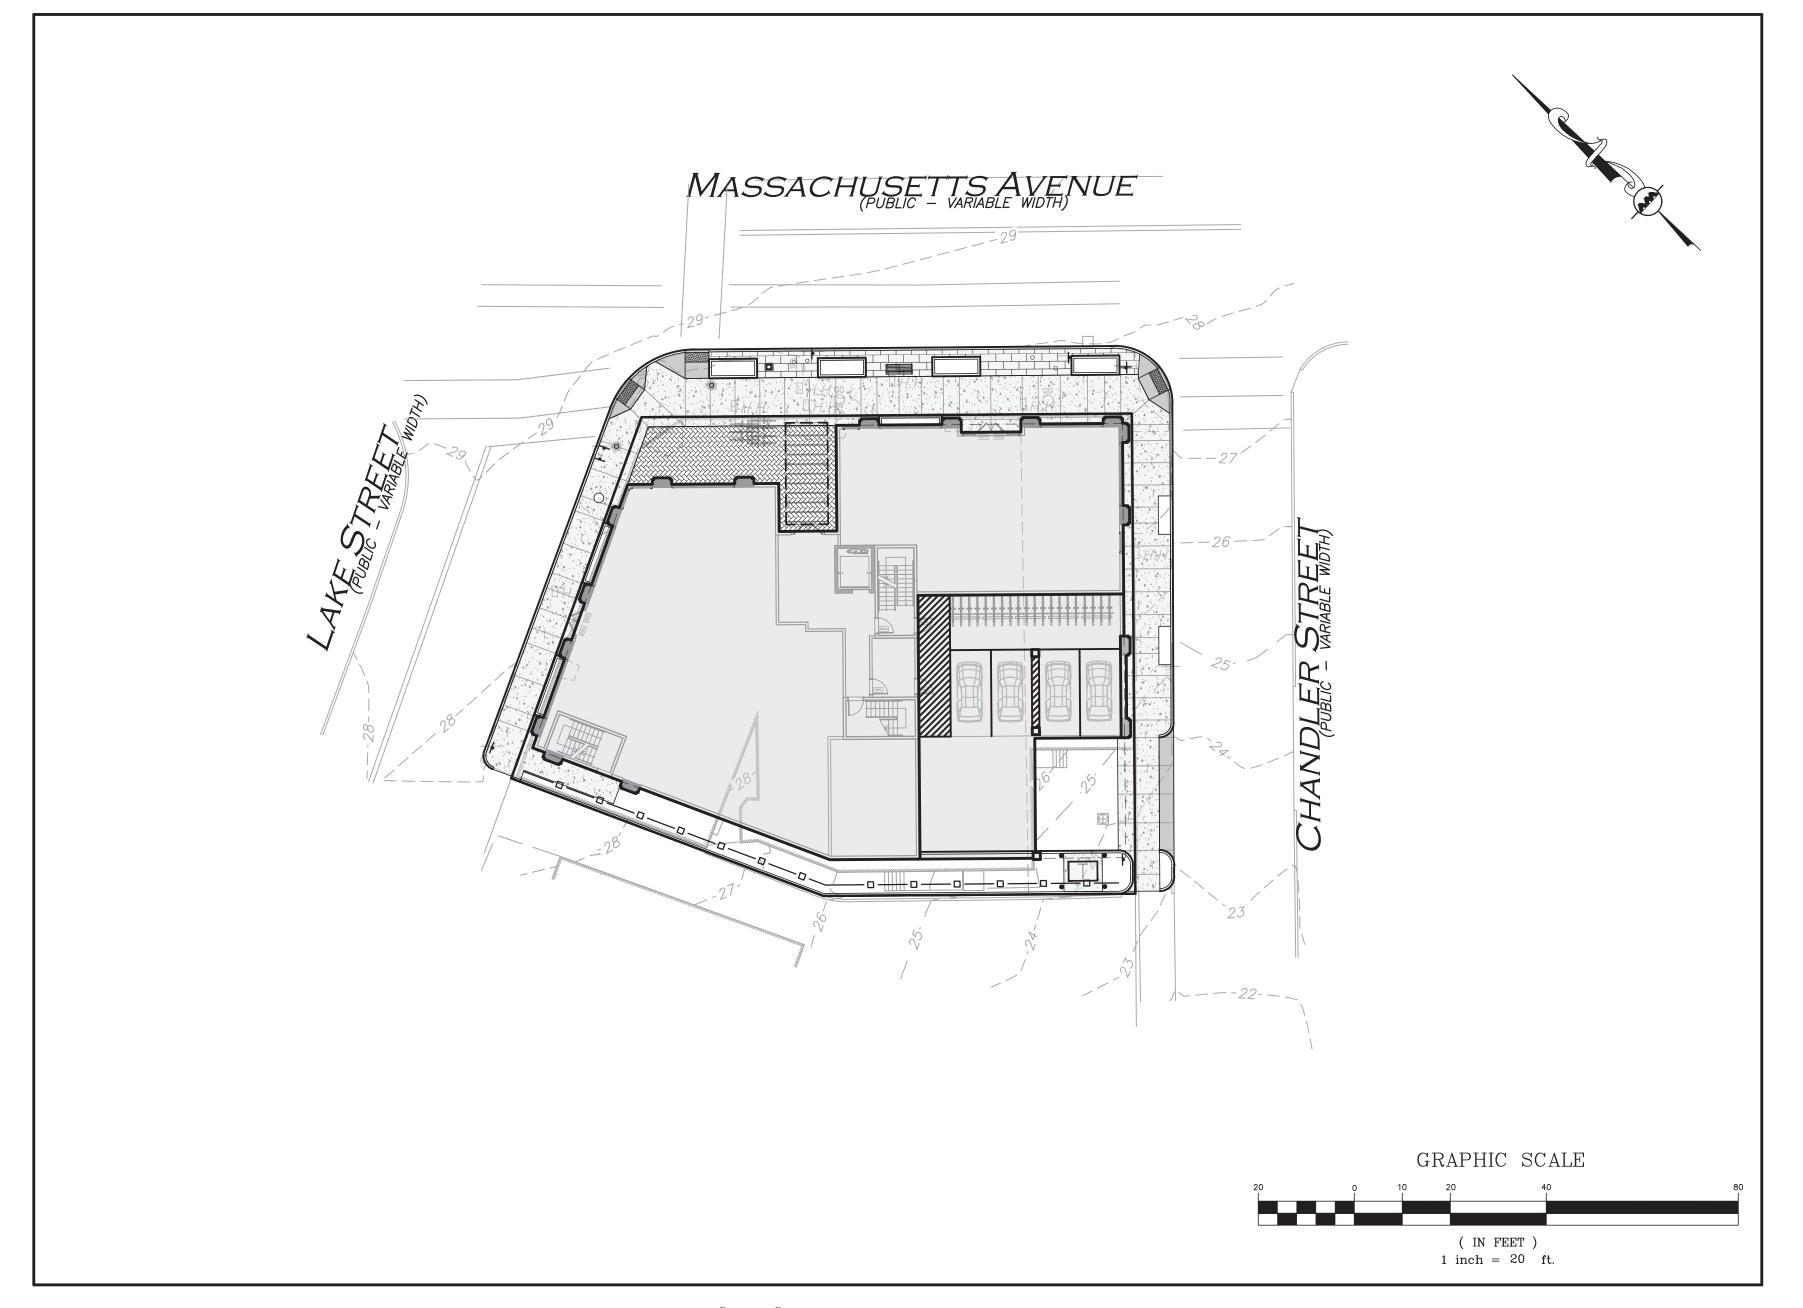

LIST OF DRAWINGS				
DRAWING TITLE	SHEET	ISSUED	REV I	
EXISTING CONDITIONS	V-101	10-23-20	-	
SITE PREPARATION PLAN	C-101	12-19-22	02-17-23	
LAYOUT & MATERIALS PLAN	C-102	12-19-22	02-17-23	
GRADING & DRAINAGE PLAN	C-103	12-19-22	02-17-23	
UTILITIES PLAN	C-104	12-19-22	02-17-23	
DETAILS	C-501	12-19-22	02-17-23	
DETAILS	C-502	12-19-22	02-17-23	
DETAILS	C-503	12-19-22	02-17-23	
LANDSCAPE PLAN	L-101	12-19-22	02-17-23	
LANDSCAPE DETAILS	L-501	12-19-22	02-17-23	





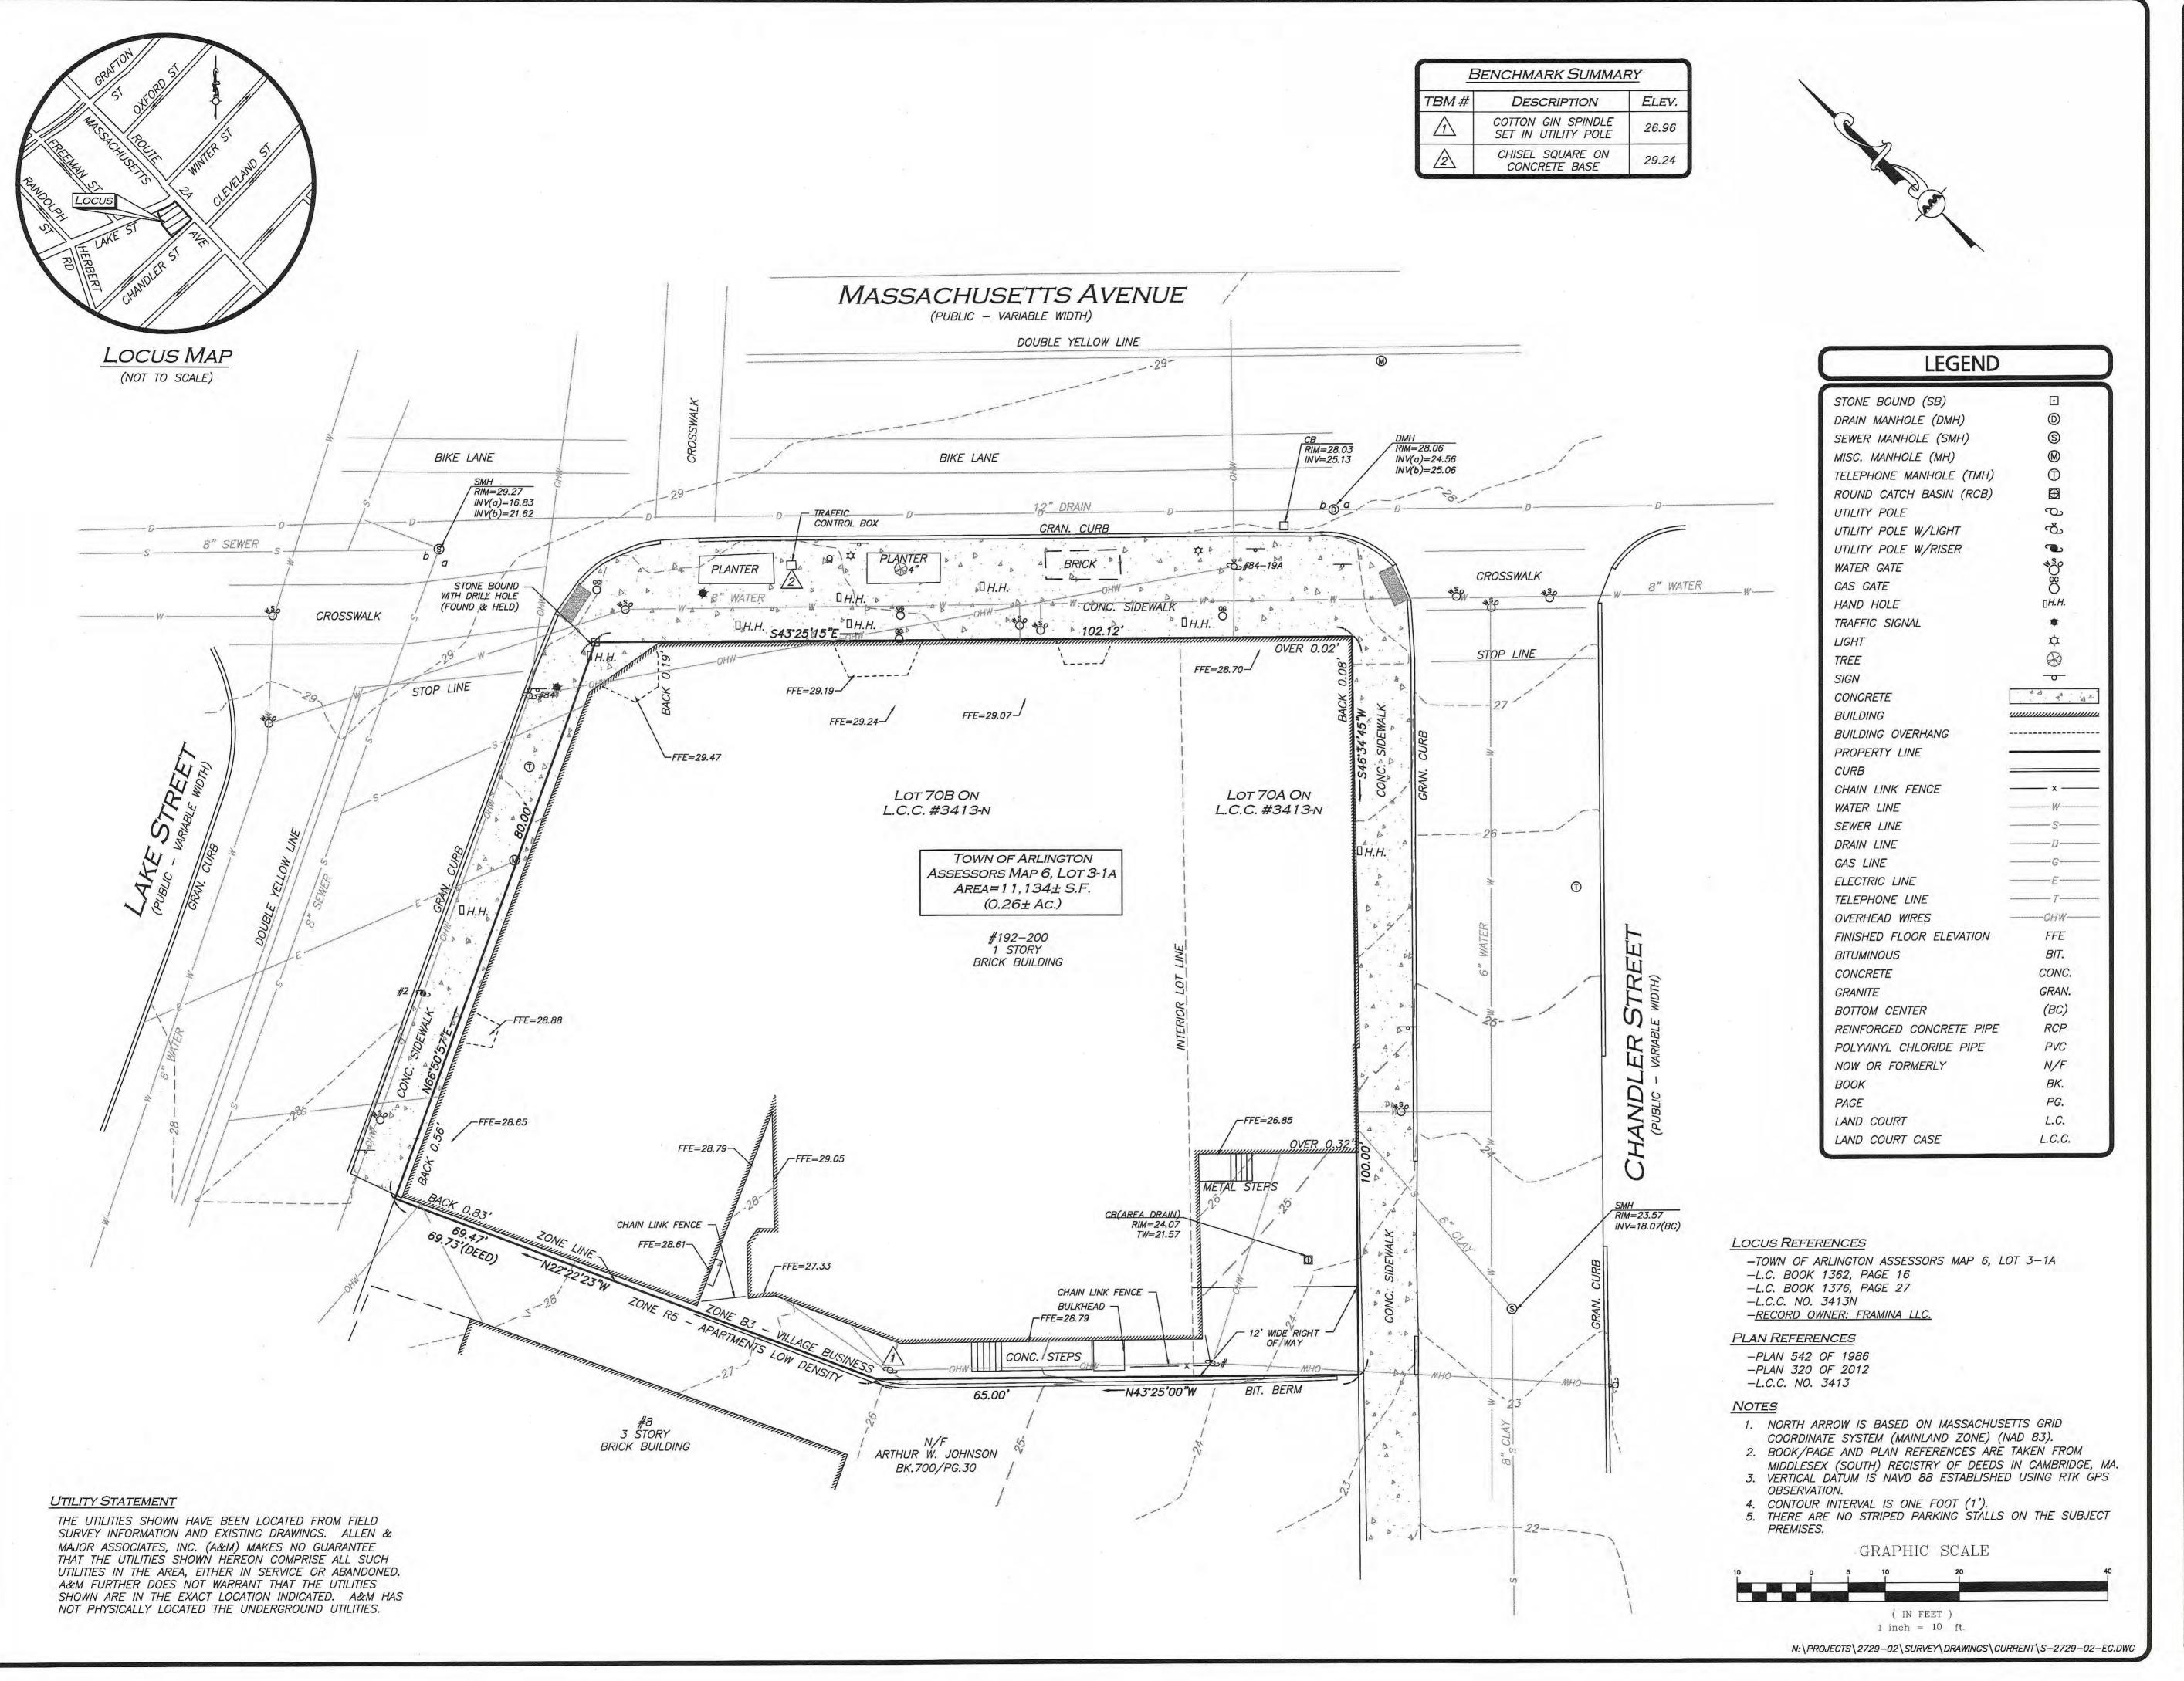

WE HEREBY CERTIFY THAT THIS PLAN IS THE RESULT OF AN ACTUAL ON THE GROUND SURVEY PERFORMED ON AUGUST 4, 2020.

PROFESSIONAL LAND SURVEYOR FOR ALLEN & MAJOR ASSOCIATES, INC.



REV DATE DESCRIPTION

APPLICANT\OWNER:

192-200 MASSACHUSETTS AVE LLC 455 MASSACHUSETTS AVENUE SUITE 1 ARLINGTON, MA 02474

PROJECT:

190 & 192-200
MASSACHUSETTS AVENUE
ARLINGTON, MA

 PROJECT NO.
 2729-02
 DATE:
 10/22/20

 SCALE:
 1" = 10'
 DWG. NAME:
 S-2729-02-EC

 DRAFTED BY:
 AJR
 CHECKED BY:
 NIL



ASSOCIATES, INC.

environmental consulting of landscape architecture
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100 COMMERCE WAY
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WOBURN, MA • LAKEVILLE, MA • MANCHESTER, NE

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ALLEN & MAJOR ASSOCIATES, INC.

02-17-23 | REVISION 1 PER ARB COMMENTS

REV DATE DESCRIPTION APPLICANT\OWNER:

> 192-200 MASSACHUSETTS AVE, LLC 455 MASSACHUSETTS AVE, STE 1 ARLINGTON, MA 02474

PROJECT:

190 & 192-200 MASSACHUSETTS AVE ARLINGTON, MA 02476

PROJECT NO. 2729-02 DATE: 12-19-22 SCALE: 1" = 10' DWG. NAME: C2729-02 BDJ CHECKED BY: **DESIGNED BY:**



civil engineering • land surveying nvironmental consulting • landscape architecture www.allenmajor.com

100 COMMERCE WAY, SUITE 5 WOBURN MA 01801 TEL: (781) 935-6889 FAX: (781) 935-2896

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DRAWING TITLE:

SHEET No. C-101 SITE PREPARATION PLAN

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1-888-344-7233

PARKING SUMMARY TABLE

USE	CALCULATION	MIN. REQUIRED	TOTAL PROPOSED	
	1.0 SPACES PER EFFICIENCY UNIT	2.0	0	
	2 X 1.0 = 2.0	2.0	U	
APARTMENT	1.15 SPACES PER 1 BED UNIT	26.5	21	
BUILDING	23 X 1.15 =32.2	20.3	21	
	1.5 SPACES PER 2 BED UNIT	10.0	5	
	5 X 2 = 10.0	- 26.5 - 10.0		
GENERAL	1 PER 300 SF			
RETAIL/RESTAURANT	1,851 SF (1ST 3,000 SF IS EXEMPT)	6.2	0	
		44.7	26*	

ADA SPACES REQUIRED:

(26-50) TOTAL PARKING SPACES PROVIDED, 2 SHALL BE THE MINIMUM ADA PARKING PROVIDED, 1 SPACES BEING VAN ACCESSIBLE.

PROVIDED 2 SPACES, 1 BEING VAN ACCESSIBLE.

REMOVE AND RESET-VERTICAL GRANITE

> SCORE LINE -(TYPICAL)

"NO STANDING ANYTIME"

DIG SAFE

BEFORE YOU DIG CALL 811 OR

1-888-DIG-SAFE

1-888-344-7233

SIGN TO REMAIN

CURB

1. SECTION 6.1.10, C. FOR A MIXED-USE DEVELOPMENT THE FIRST 3,000 SF OF NON-RESIDENTIAL SPACE IS EXEMPT FROM THE PARKING

-LANDSCAPED

-LANDSCAPED

START VGC

OPEN SPACE 26 S.F.

-START SCREEN FENCE

OPEN SPACE 26 S.F.

BICYCLE PARKING SUMMARY TABLE

LONG TERM BICYCLE PARKING (INTERIOR)

USE

APARTMENT

BUILDING

SERVICE

BUILDING LINE

BUILDING ABOVE

PROPOSED -

END SCREEN FENCE-

TRANSFORMER

CBITUMINOUS) PAVEMENT -_ CALCULATION

 $30 \times 1.5 = 45.0$

0.1 PER 1,000 SF

TOTAL

 $|4.7 \times 0.1| = 0.5$

1.5 PER UNIT

REQUIRED

REQUIRED

MIN. REQUIRED

45.0

0.5

45.5

SCORE LINE

(TYPICAL)

-RECONSTRUCT

CONCRETE SIDEWALK (WIDTH VARIES)

COMMERCIAL DRIVEWAY

ENTRANCE, SEE

-"LEFT TURN ONLY"

TOTAL PROPOSED

48

48

SHORT TERM BICYCLE PARKING (EXTERIOR)					
USE	CALCULATION	MIN. REQUIRED	TOTAL PROPOSED		
APARTMENT	0.1 PER UNIT				
BUILDING	30 X 0.1 = 3.0 REQUIRED	3.0	J		
RETAIL	0.6 PER 1,000 SF	0	_		
SERVICE	4.7 X 0.6 = 3.0 REQUIRED	2.8	3		
	TOTAL	5.8	6		

BICYCLE PARKING TABLE NOTES: 1. REQUIRED NUMBER OF SPACES ARE FROM BICYCLE PARKING GUIDELINES, APPENDIX A BIKE PARKING BY-LAW.

LEGEND

PROPERTY LINE	
SIGN	
BOLLARD	•
BUILDING	
BUILDING INTERIOR WALLS	
CURB	
PARKING STRIPING	< %
ROADWAY STRIPING	
SIDEWALK	
ADA ACCESSIBLE RAMP	
ADA DET. WARNING SURFACE	<u> </u>
CONCRETE PAVERS	
SNOW STORAGE	XXXXX

SNOW STORAGE

SAW-CUT LINE PARKING COUNT VINYL FENCE


MASSACHUSETTS AVENUE (PUBLIC - VARIABLE WIDTH)

DOUBLE YELLOW LINE

6.6'

-END VGC

R5 ZONE

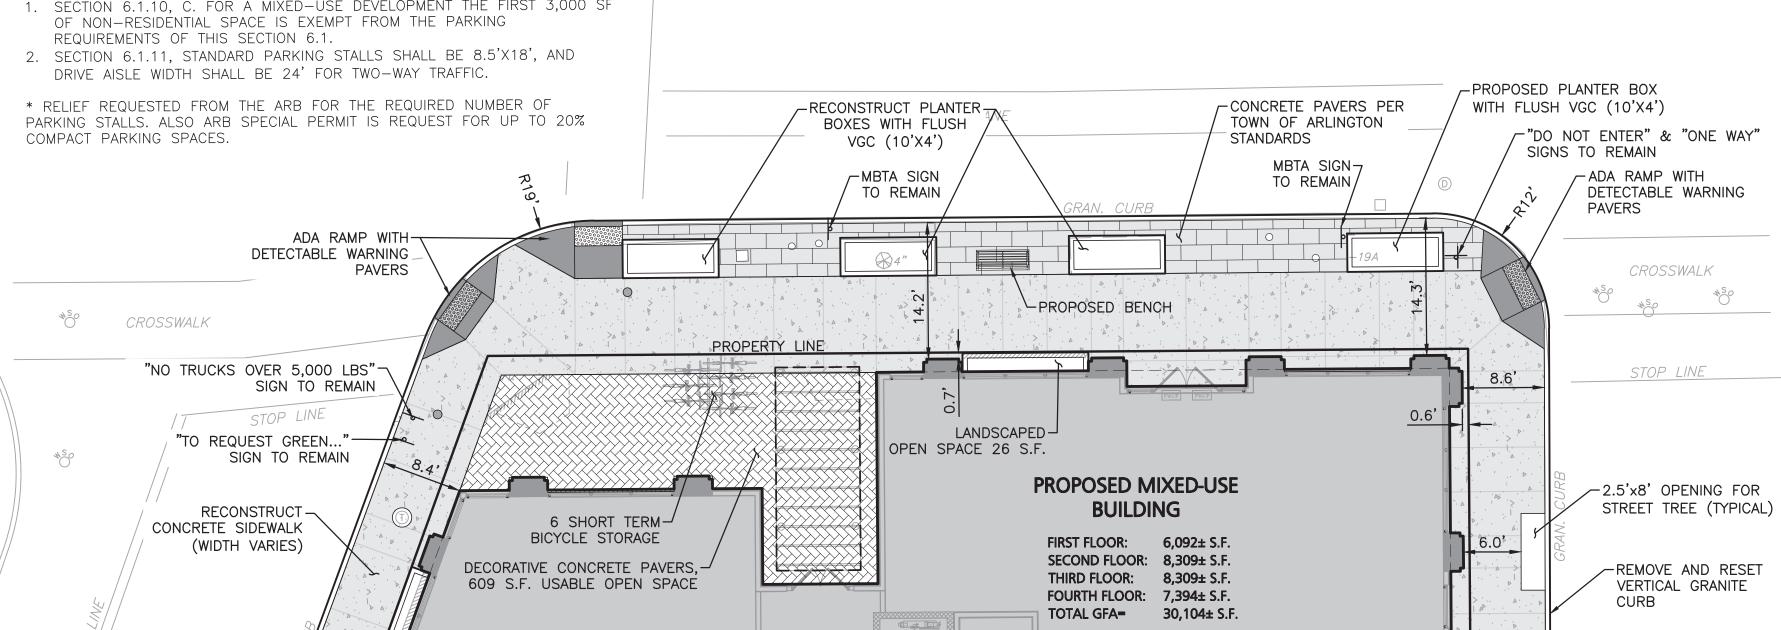

OPEN SPACE 722 S.F.

-BUFFER SCREEN. SEE

LANDSCAPE SHEET L-101.

N/F

ARTHUR W. JOHNSON

BK.700/PG.30

ZONING SUMMARY TABLE B3-VILLAGE BUSINESS (MIXED-USE >20,000 SF)

ITEM	REQUIRED/ ALLOWED	EXISTING	PROPOSED
MINIMUM LOT AREA	>20,000 SF	11,134± SF	11,134±* SF
MINIMUM LOT AREA PER UNIT	600 SF	N/A	348±* SF
MINIMUM FRONTAGE	50 FT	102.1± FT MASS AVE	102.1± FT MASS AVE
MINIMUM FRONT YARD SETBACK	O FT	O FT	0.6 FT
MINIMUM SIDE YARD SETBACK	O FT	0.6 FT	7.5 FT
MINIMUM REAR YARD SETBACK	(H+L)/6	NO REAR	NO REAR
SCREENING BUFFER	7.5 FT ⁽³⁾	0.6 FT	7.5 ⁽³⁾
LANDSCAPED OPEN SPACE	10% ⁽²⁾	0.9%	4.2%*
USABLE OPEN SPACE	20% ⁽²⁾	0%	7.4%*
MAXIMUM HEIGHT	50 FT	20± FT	45± FT
MAXIMUM HEIGHT STORIES	5	1	4(1)
FLOOR AREA RATIO	2.8	0.9	2.7

SECTION 5.3.17, FOR BUILDING MORE THAN 3 STORIES IN HEIGHT, AN ADDITIONAL 7.5 FT STEP-BACK SHALL BE PROVIDED BEGINNING AT THE THIRD STORY LEVEL OR 30 FT ABOVE GRADE, WHICHEVER IS LESS. THE UPPER STORY STEP-BACK SHALL BE

PROVIDED ALONG ALL BUILDING ELEVATIONS WITH STREET FRONTAGE. 2. SECTION 5.3.21. SUPPLEMENTAL REQUIREMENTS IN THE BUSINESS AND INDUSTRIAL DISTRICTS, D. FOR MIXED USES AND ANY PERMITTED RESIDENTIAL USE NOT SPECIFICALLY IDENTIFIED IN THE TABLES IN SECTION 5.5.2, THE MINIMUM OPEN SPACE REQUIREMENTS (COMPUTED FROM THE RESIDENTIAL FLOOR AREA ONLY) SHALL BE 10% LANDSCAPED AND 20% USABLE IN THE B1, B2, B2A, B3, AND B4 DISTRICTS, AND 15 PERCENT USABLE IN THE B5 DISTRICT.

3. SECTION 5.3.21. SUPPLEMENTAL REQUIREMENTS IN THE BUSINESS AND INDUSTRIAL DISTRICTS, B3 ABUTTING R5 15 FT MINIMUM BUFFER. A SOLID WALL OR WOODEN FENCE MAY BE SUBSTITUTED FOR ONE-HALF THE WIDTH OF THE LANDSCAPED BUFFER.

4. TOTAL RESIDENTIAL FLOOR AREA (PROVIDED BY ARCHITECT): 19,065 S.F.

5. TOTAL RETAIL FLOOR AREA (PROVIDED BY ARCHITECT): 4,851 S.F. 6. GROSS FLOOR AREA (PROVIDED BY ARCHITECT): 30,104 S.F.

* RELIEF REQUESTED FROM ARB.


NOTES


STREIL LE WIDTH)

ER

YANDLI (PUBLIC - V

- WRITTEN DIMENSIONS ON THIS PLAN TAKE PRECEDENCE OVER SCALED DIMENSIONS. THE CONTRACTOR SHALL USE CAUTION WHEN SCALING REPRODUCED PLANS. IN THE EVENT OF A CONFLICT BETWEEN THIS PLAN SET AND ANY OTHER DRAWINGS AND/OR SPECIFICATIONS OR CONDITIONS, THE ENGINEER SHALL BE NOTIFIED BY THE CONTRACTOR. ALL SITE ITEMS SHALL BE LAID OUT AND AS BUILT BY A LICENSED LAND SURVEYOR.
- 2. ALL CURB RADII ARE 3' UNLESS OTHERWISE NOTED.
- 3. THE INFORMATION SHOWN ON THIS PLAN IS THE SOLE PROPERTY OF ALLEN & MAJOR ASSOCIATES, INC. ITS INTENDED USE IS TO PROVIDE INFORMATION. ANY ALTERATION, MISUSE, OR RECALCULATION OF INFORMATION OR DATA WITHOUT THE EXPRESSED, WRITTEN CONSENT OF ALLEN & MAJOR ASSOCIATES, INC. IS STRICTLY PROHIBITED.

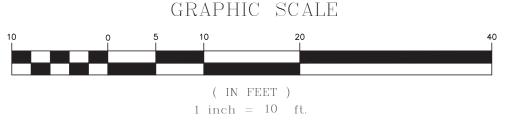

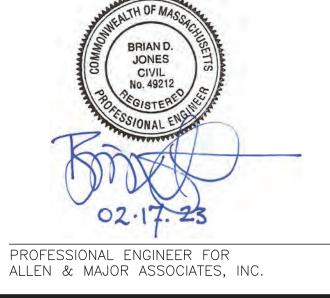

02-17-23 REVISION 1 PER ARB COMMENTS DATE DESCRIPTION

APPLICANT\OWNER:

192-200 MASSACHUSETTS AVE, LLC 455 MASSACHUSETTS AVE, STE 1 ARLINGTON, MA 02474

PROJECT:

REV

190 & 192-200 MASSACHUSETTS AVE ARLINGTON, MA 02476

PROJECT NO. 2729-02 DATE: 12-19-22 SCALE: 1" = 10' DWG. NAME: C2729-0 BDJ CHECKED BY: **DESIGNED BY:**



civil engineering • land surveying nvironmental consulting • landscape architecture www.allenmajor.com 100 COMMERCE WAY, SUITE 5 WOBURN MA 01801

TEL: (781) 935-6889 FAX: (781) 935-2896


WOBURN, MA ♦ LAKEVILLE, MA ♦ MANCHESTER, N

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DRAWING TITLE:


SHEET No. LAYOUT & MATERIALS PLAN | C-102

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- 1. THE LOCATIONS OF EXISTING UNDERGROUND UTILITIES ARE SHOWN IN AN APPROXIMATE WAY ONLY AND HAVE NOT BEEN INDEPENDENTLY VERIFIED BY THE OWNER OR IT'S REPRESENTATIVE. THE CONTRACTOR SHALL DETERMINE THE EXACT LOCATION OF ALL EXISTING UTILITIES BEFORE COMMENCING WORK, AND AGREES TO BE FULLY RESPONSIBLE FOR ANY AND ALL DAMAGES WHICH MIGHT BE OCCASIONED BY THE CONTRACTOR'S FAILURE TO EXACTLY LOCATE
- 2. CONTRACTOR IS RESPONSIBLE FOR DEMOLITION OF EXISTING STRUCTURES INCLUDING REMOVAL OF ANY EXISTING UTILITIES SERVING THE STRUCTURE. UTILITY CONNECTIONS SHOULD BE COORDINATED WITH THE MEP PRIOR TO
- 3. EXISTING DRAINAGE STRUCTURES TO REMAIN ARE TO BE INSPECTED AND REPAIRED AS NEEDED, AND EXISTING PIPES TO BE CLEANED OUT TO REMOVE
- 4. IF ANY EXISTING STRUCTURES TO REMAIN ARE DAMAGED DURING CONSTRUCTION IT SHALL BE THE CONTRACTOR'S RESPONSIBILITY TO REPAIR AND/OR REPLACE THE EXISTING STRUCTURE AS NECESSARY TO RETURN IT
- 5. CONTRACTOR SHALL ADJUST AND/OR CUT EXISTING PAVEMENT AS NECESSARY TO ENSURE A SMOOTH FIT AND CONTINUOUS GRADE.
- 6. CONTRACTOR SHALL ENSURE POSITIVE DRAINAGE AWAY FROM BUILDINGS FOR
- 7. THE CONTRACTOR SHALL COORDINATE WITH THE ARCHITECT FOR THE FINAL LOCATIONS OF PROPOSED ROOF DRAINS. LOCATIONS ARE SHOWN HEREON
- 8. WRITTEN DIMENSIONS ON THIS PLAN TAKE PRECEDENCE OVER SCALED DIMENSIONS. THE CONTRACTOR SHALL USE CAUTION WHEN SCALING REPRODUCED PLANS. IN THE EVENT OF A CONFLICT BETWEEN THIS PLAN SET AND ANY OTHER DRAWINGS AND/OR SPECIFICATIONS OR CONDITIONS, THE
- 9. ANY DAMAGE TO PRIVATE OR PUBLIC PROPERTIES DUE TO THE CONTRACTOR'S ACTIVITIES SHALL BE REPAIRED AND RESTORED BY THE
- 10. ALL PROPERTY MARKERS AND STREET LINE MONUMENTS SHALL BE PROPERLY PROTECTED DURING CONSTRUCTION. ANY DAMAGE TO THESE ITEMS SHALL BE REPAIRED AND RESTORED BY A LAND SURVEYOR LICENSED IN THE
- 11. THE CONTRACTOR IS RESPONSIBLE FOR OBTAINING ADDITIONAL BENCHMARK INFORMATION IF REQUIRED. THE CONTRACTOR IS RESPONSIBLE FOR LOCATING AND PROTECTING ALL EXISTING BENCHMARKS. IF IT IS NECESSARY TO RELOCATE A BENCHMARK, IT SHALL BE RELOCATED BY A MASSACHUSETTS
- 12. ALL PERMITS AND APPROVALS NECESSARY FROM AGENCIES GOVERNING THE WORK SHALL BE OBTAINED BY THE CONTRACTOR PRIOR TO THE
- 13. CONSTRUCTION DURING WET WEATHER OR WINTER CONDITIONS IS TO BE ANTICIPATED AND PROVISIONS TO ADEQUATELY ADDRESS THESE CONDITIONS
- 14. ALL CONSTRUCTION SHALL CONFORM TO THE APPLICABLE REGULATIONS AND STANDARDS INCLUDING THE TOWN OF ARLINGTON, MADOT, MADEP, MWRA,
- 15. THE CONTRACTOR IS SOLELY RESPONSIBLE FOR THE MEANS AND METHODS OF CONSTRUCTION AND FOR CONDITIONS AT THE SITE. THESE PLANS, PREPARED BY ALLEN & MAJOR ASSOCIATES DO NOT EXTEND TO OR INCLUDE SYSTEMS PERTAINING TO THE SAFETY OF THE CONSTRUCTION CONTRACTOR OR THEIR EMPLOYEES, AGENTS OR REPRESENTATIVES IN THE PERFORMANCE OF THE WORK, OR THE OWNER'S EMPLOYEES, CUSTOMERS, OR THE GENERAL PUBLIC. THE SEAL OF THE ENGINEER AS INCLUDED IN THE PLAN SET DOES NOT EXTEND TO ANY SUCH SAFETY SYSTEMS THAT MAY NOW OR HEREAFTER BE INCORPORATED INTO THESE PLANS. THE CONSTRUCTION CONTRACTOR SHALL PROVIDE THE APPROPRIATE SAFETY SYSTEMS WHICH MAY BE REQUIRED BY THE U.S. OCCUPATIONAL SAFETY AND HEALTH ADMINISTRATION (OSHA),
- 16. THE INFORMATION SHOWN ON THIS PLAN IS THE SOLE PROPERTY OF ALLEN & MAJOR ASSOCIATES, INC. ITS INTENDED USE IS TO PROVIDE INFORMATION. ANY ALTERATION, MISUSE, OR RECALCULATION OF INFORMATION OR DATA WITHOUT THE EXPRESSED, WRITTEN CONSENT OF ALLEN & MAJOR

1 inch = 10 ft.

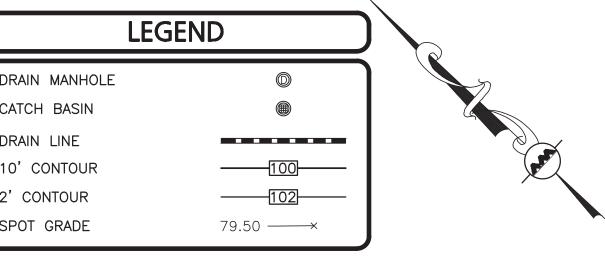

02-17-23 REVISION 1 PER ARB COMMENTS

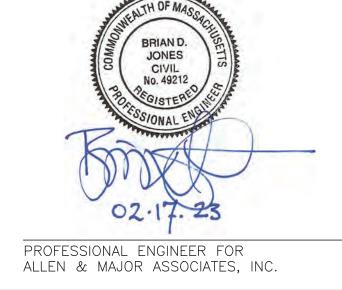REV DATE DESCRIPTION

APPLICANT\OWNER:

192-200 MASSACHUSETTS AVE, LLC 455 MASSACHUSETTS AVE, STE 1 ARLINGTON, MA 02474

PROJECT:

190 & 192-200 MASSACHUSETTS AVE ARLINGTON, MA 02476

2729-02 DATE: PROJECT NO. 12-19-22 SCALE: 1" = 10' DWG. NAME: **DESIGNED BY:** BDJ CHECKED BY:

ALLEN & MAJOR

ASSOCIATES, INC. civil engineering • land surveying

nvironmental consulting • landscape architecture www.allenmajor.com 100 COMMERCE WAY, SUITE 5 WOBURN MA 01801 TEL: (781) 935-6889

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DRAWING TITLE:

GRADING & DRAINAGE PLAN | C-103

SHEET No.

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1-888-344-7233

BIKE LANE

8" SEWER

SMH / RIM=29.27

' INV(a)=16.83 INV(b) = 21.62

MASSACHUSETTS AVENUE

(PUBLIC - VARIABLE WIDTH)

BIKE LANE

DOUBLE YELLOW LINE

RIM=28.03

| INV = 25.13

RIM=28.06

INV(a) = 24.56

INV(b) = 25.06

CROSSWALK

INSTALL 3"X6"

TAPPING SLEEVE

WITH GATE VALVE


RIM=23.57

INV=18.07(BC)

CUT AND CAP EXISTING WATER SERVICE

IN THIS LOCATION. INSTALL 6"X6"

TAPPING SLEEVE WITH GATE VALVE

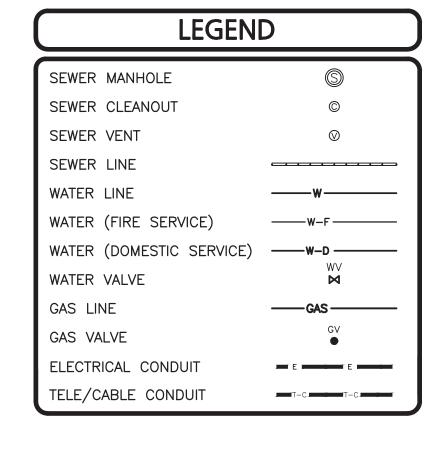

UTILITY NOTES:


8" WATER

- 1. THE CONTRACTOR IS SPECIFICALLY CAUTIONED THAT THE LOCATION AND/OR ELEVATION OF EXISTING UTILITIES AND STRUCTURES AS SHOWN ON THESE PLANS IS BASED ON RECORDS OF VARIOUS UTILITY COMPANIES AND WHERE POSSIBLE, MEASUREMENTS TAKEN IN THE FIELD. THIS INFORMATION IS NOT TO BE RELIED ON AS BEING EXACT OR COMPLETE. THE LOCATION OF ALL UNDERGROUND UTILITIES AND STRUCTURES SHALL BE VERIFIED IN THE FIELD BY THE CONTRACTOR PRIOR TO THE START OF CONSTRUCTION.
- 2. A MINIMUM OF 18" VERTICAL CLEARANCE SHALL BE MAINTAINED WHERE WATER SERVICES CROSS STORM DRAIN AND SEWER LINES. WATER SERVICES SHALL BE ENCASED IN CONCRETE REGARDLESS OF CLEARANCE WHEN PASSING BELOW STORM DRAIN AND SEWER LINES. ENCASEMENT SHALL EXTEND ALONG WATER SERVICE A MINIMUM DISTANCE OF EIGHT FEET CENTERED ON THE CROSSING POINT OF THE OTHER PIPE AS MEASURED NORMALLY FROM ALL POINTS ALONG THE PIPE.
- 3. THE ENGINEER SHALL BE NOTIFIED IN WRITING OF ANY UTILITIES INTERFERING WITH THE PROPOSED CONSTRUCTION AND APPROPRIATE REMEDIAL ACTION TAKEN BEFORE PROCEEDING WITH THE WORK. IT SHALL BE THE RESPONSIBILITY OF THE CONTRACTOR TO RELOCATE ALL EXISTING UTILITIES WHICH CONFLICT WITH THE PROPOSED IMPROVEMENTS SHOWN ON THE PLANS.
- 4. THE CONTRACTOR MUST CONTACT THE APPROPRIATE UTILITY COMPANY, ANY GOVERNING PERMITTING AUTHORITY, AND "DIGSAFE" AT LEAST 72 HOURS PRIOR TO ANY EXCAVATION WORK TO REQUEST EXACT FIELD LOCATION OF UTILITIES AND THE ENGINEER SHALL BE NOTIFIED IN WRITING OF ANY UTILITIES INTERFERING WITH THE PROPOSED CONSTRUCTION AND APPROPRIATE REMEDIAL ACTION TAKEN BEFORE PROCEEDING WITH THE WORK. IT SHALL BE THE RESPONSIBILITY OF THE CONTRACTOR TO RELOCATE ALL EXISTING UTILITIES WHICH CONFLICT WITH THE PROPOSED IMPROVEMENTS SHOWN ON THE PLANS.
- 5. THE INFORMATION SHOWN ON THIS PLAN IS THE SOLE PROPERTY OF ALLEN & MAJOR ASSOCIATES, INC. ITS INTENDED USE IS TO PROVIDE INFORMATION. ANY ALTERATION, MISUSE, OR RECALCULATION OF INFORMATION OR DATA WITHOUT THE EXPRESSED, WRITTEN CONSENT OF ALLEN & MAJOR ASSOCIATES, INC. IS STRICTLY PROHIBITED.

GRAPHIC SCALE

(IN FEET)

1 inch = 10 ft.

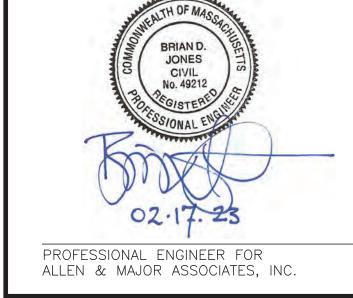

02-17-23 | REVISION 1 PER ARB COMMENTS

REV DATE DESCRIPTION APPLICANT\OWNER:

192-200 MASSACHUSETTS AVE, LLC 455 MASSACHUSETTS AVE, STE 1 ARLINGTON, MA 02474

PROJECT:

190 & 192-200 MASSACHUSETTS AVE ARLINGTON, MA 02476

PROJECT NO.	2729-02	DATE:	12-19-22
SCALE:	1" = 10'	DWG. NAME:	C2729-0
DESIGNED BY:	BDJ	CHECKED BY:	RPC



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100 COMMERCE WAY, SUITE 5 WOBURN MA 01801 TEL: (781) 935-6889 FAX: (781) 935-2896

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SHEET No.

C-104

UTILITIES PLAN

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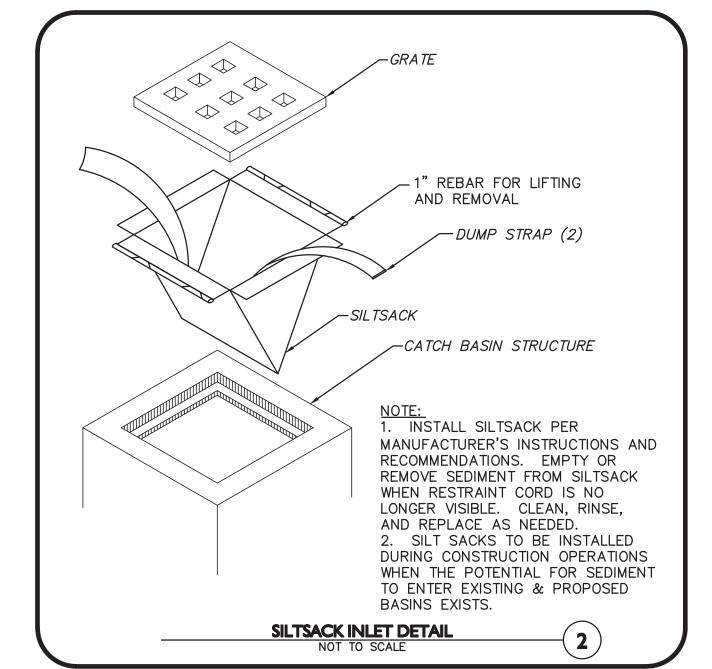
2. OVERLAP TUBULAR BARRIER SEGMENTS A MINIMUM OF 12".


3. THE CONTRACTOR SHALL MAINTAIN THE TUBULAR BARRIERS IN A FUNCTIONAL CONDITION AT ALL TIMES. THE CONTROLS SHALL BE ROUTINELY INSPECTED BY THE CONTRACTOR.

4. WHERE THE TUBULAR BARRIERS REQUIRE REPAIR OR SEDIMENT REMOVAL, IT WILL BE COMPLETED BY THE CONTRACTOR AT NO ADDITIONAL COST.

5. AT A MINIMUM, THE CONTRACTOR SHALL REMOVE SEDIMENTS COLLECTED AT THE BASE WHEN THEY REACH 1/3 THE EXPOSED HEIGHT OF THE BARRIER.






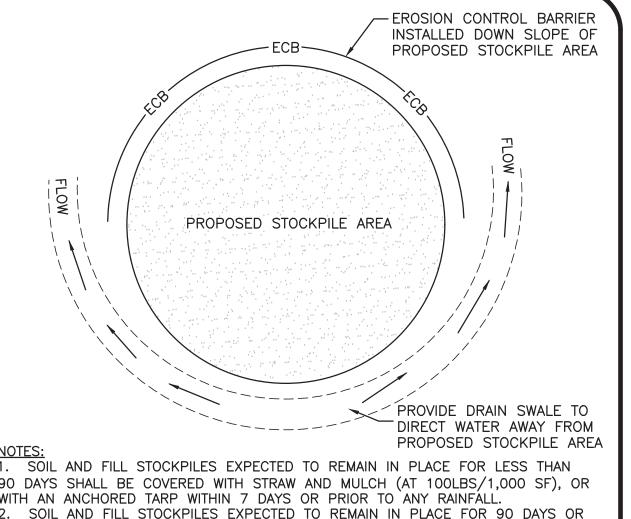

90 DAYS SHALL BE COVERED WITH STRAW AND MULCH (AT 100LBS/1,000 SF), OR WITH AN ANCHORED TARP WITHIN 7 DAYS OR PRIOR TO ANY RAINFALL. 2. SOIL AND FILL STOCKPILES EXPECTED TO REMAIN IN PLACE FOR 90 DAYS OR MORE SHALL BE SEEDED WITH WINTER RYE (FOR FALL SEEDING AT 1LB/1,000 SF) OR OATS (FOR SUMMER SEEDING AT 2LB/1,000 SF) AND THEN COVERED WITH STRAW MULCH (AT 100LB/1,000 SF) OR AN ANCHORED TARP WITHIN 7 DAYS OR PRIOR TO ANY RAINFALL.

> STOCKPILE PROTECTION DETAIL NOT TO SCALE

DIVERSION RIDGE REQUIRED WHERE GRADE EXCEEDS 2% ROADWAY **SECTION A** FILTER FABRIC SAND BAGS, TUBULAR SEDIMENT CONTROLS, OR CONTINUOUS BERM I. THE ENTRANCE SHALL BE MAINTAINED IN A CONDITION SPILLWAY OF EQUIVALENT HEIGHT-THAT WILL PREVENT TRACKING OR FLOWING OF SEDIMENT ONTO PUBLIC RIGHT-OF-WAYS. THIS MAY REQUIRE TOP WATER SUPPLY TO WASH DRESSING, REPAIR AND/OR CLEANOUT OF ANY MEASURES USED TO TRAP SEDIMENT. WHEELS (IF NECESSARY)-2. WHEN NECESSARY, WHEELS SHALL BE CLEANED PRIOR TO ENTERING THE PUBLIC RIGHT-OF-WAY. 20'R 3. WHEN WASHING IS REQUIRED, IT SHALL BE DONE ON AN AREA STABILIZED WITH CRUSHED STONE THAT DRAINS INTO AN APPROVED SEDIMENT TRAP OR SEDIMENT BASIN. 4. USE SANDBAGS, TUBULAR SEDIMENT CONTROLS, OR 2"-3"COARSE AGGREGATE 12' (MIN.) OTHER APPROVED METHODS TO CHANNELIZE RUNOFF TO MIN OF 6" THICK BASIN AS REQUIRED. L-DIVERSION RIDGE <u>PLAN</u> 50' MINIMUM

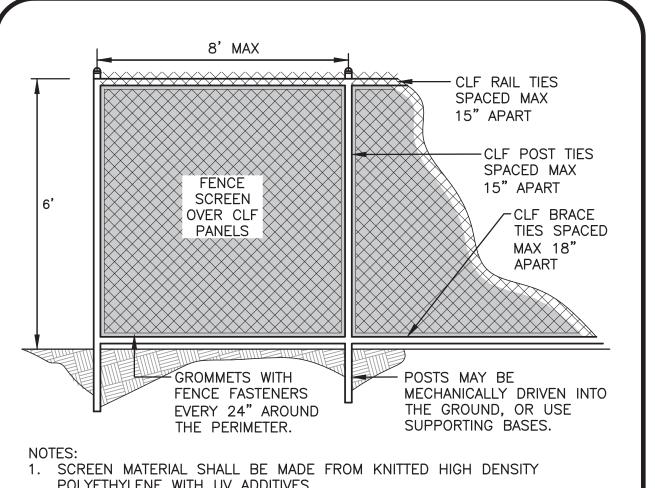


POLYETHYLENE WITH UV ADDITIVES.


5. SCREEN COLOR SHALL BE GREEN OR BLACK.


2. SCREEN FILAMENT STRENGTH SHALL BE A MINIMUM OF 50LBS/FT. 3. SCREEN MATERIAL BREAK STRENGTH SHALL BE A MINIMUM OF 500 LBS/FT. 4. SCREEN SHADE / WIND BLOCKAGE SHALL BE A MINIMUM OF 85%.

TEMPORARY CONSTRUCTION FENCE w/ SCREEN

NOT TO SCALE

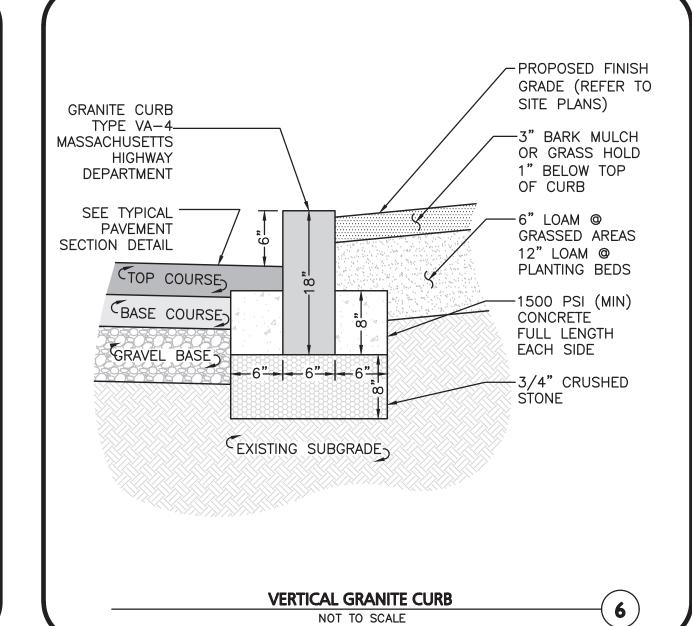

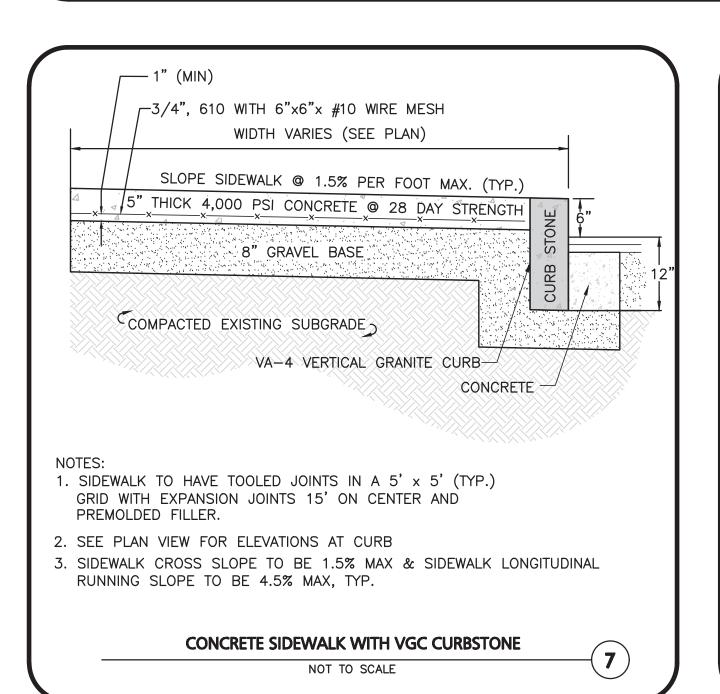

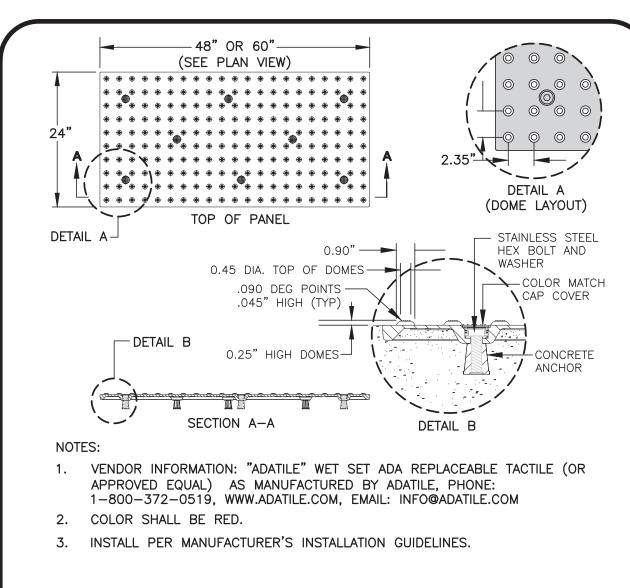



WET SET ADA REPLACEABLE TACTILE PANEL


NOT TO SCALE

TEMPORARY CONSTRUCTION ENTRANCE/EXIT

NOT TO SCALE

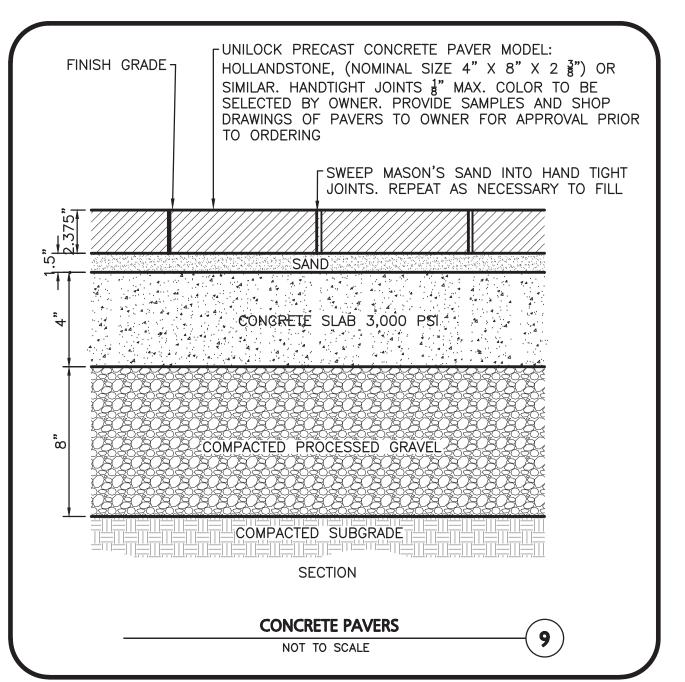

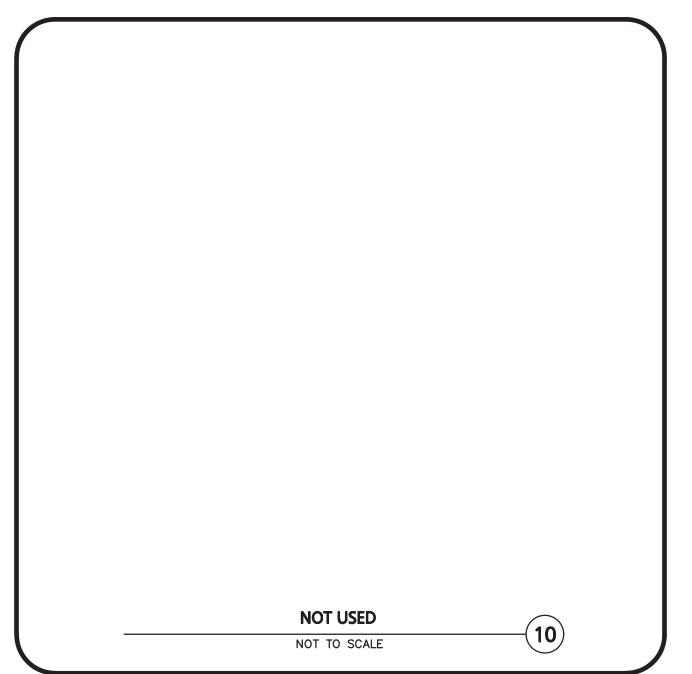

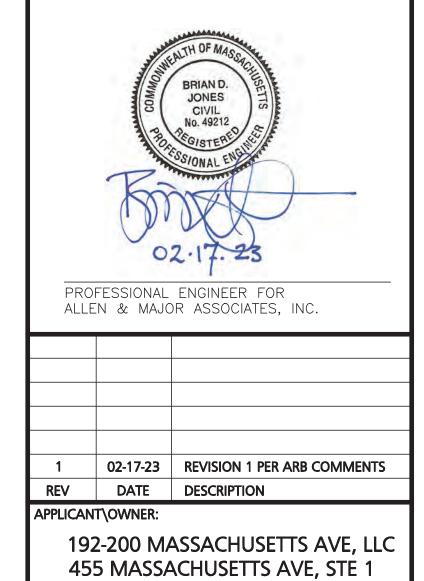

PROJECT:

PROJECT NO.

190 & 192-200 MASSACHUSETTS AVE ARLINGTON, MA 02476

2729-02 DATE:

AS SHOWN DWG. NAME:

12-19-22

C2729-02

SHEET No.

C-501

ARLINGTON, MA 02474

DESIGNED BY:	BDJ	CHECKED BY:	I
PREPARED BY:			
	X		
ALLE	N &	MAJ	OR
ASSOC	CIA	TES, I	NC.

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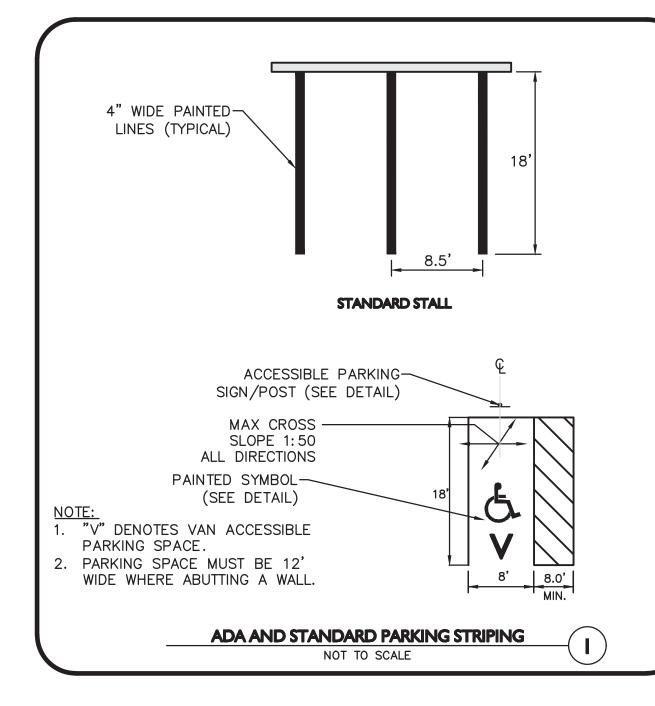
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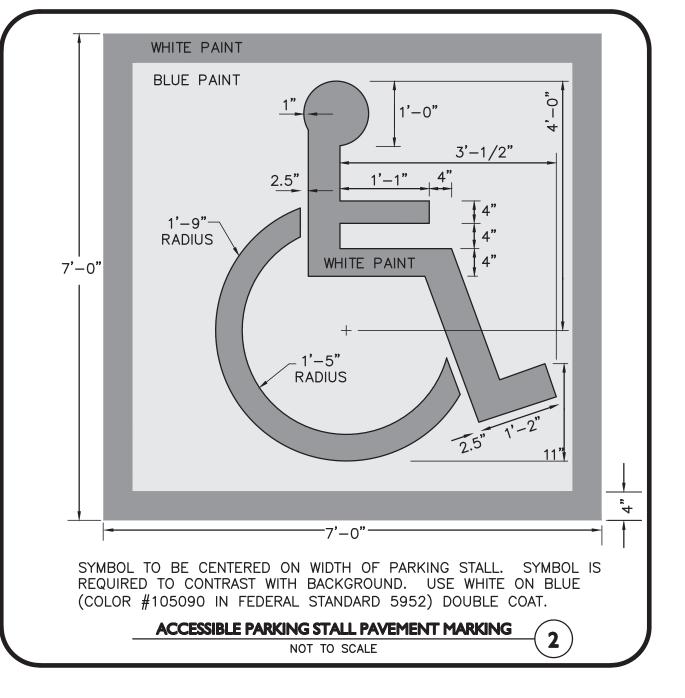
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DETAILS

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1. BENCH SHALL BE 6' WIDE VICTOR STANLEY MODEL NUMBER FMS-324 OR APPROVED EQUAL.

2. COLOR SHALL BE BLACK.

3. BENCH SHALL BE FIXED TO CONCRETE BASE, PER MANUFACTURER'S RECOMMENDATIONS.

4. SUBMIT SHOP DRAWING FOR APPROVAL.


BENCH DETAIL NOT TO SCALE


DESC.	SIGN	SIZE	MOUNTING HEIGHT	DESCRIPTION	REFLEC- TORIZED
R7-8M (MODIFIED)	HANDICAPPED PARKING SPECIAL PLATE REQUIRED UNAUTHORIZED VEHICLES MAY BE REMOVED AT THE OWNERS EXPENSE VAN ACCESSIBLE	12" × 26"	7' - 0"	WHITE TEXT ON BLUE FIELD WITH WHITE BORDER	YES


TRAFFIC AND SAFETY SIGNAGE SHALL COMPLY WITH THE "MANUAL ON UNIFORM TRAFFIC CONTROL DEVICES" (MUTCD) STANDARDS.


2. MOUNTING HEIGHT IS DEFINED AS THE DISTANCE FROM THE BOTTOM OF THE SIGN TO THE NEAR EDGE OF THE PAVEMENT.


> **SIGN TABLE (4**) NOT TO SCALE

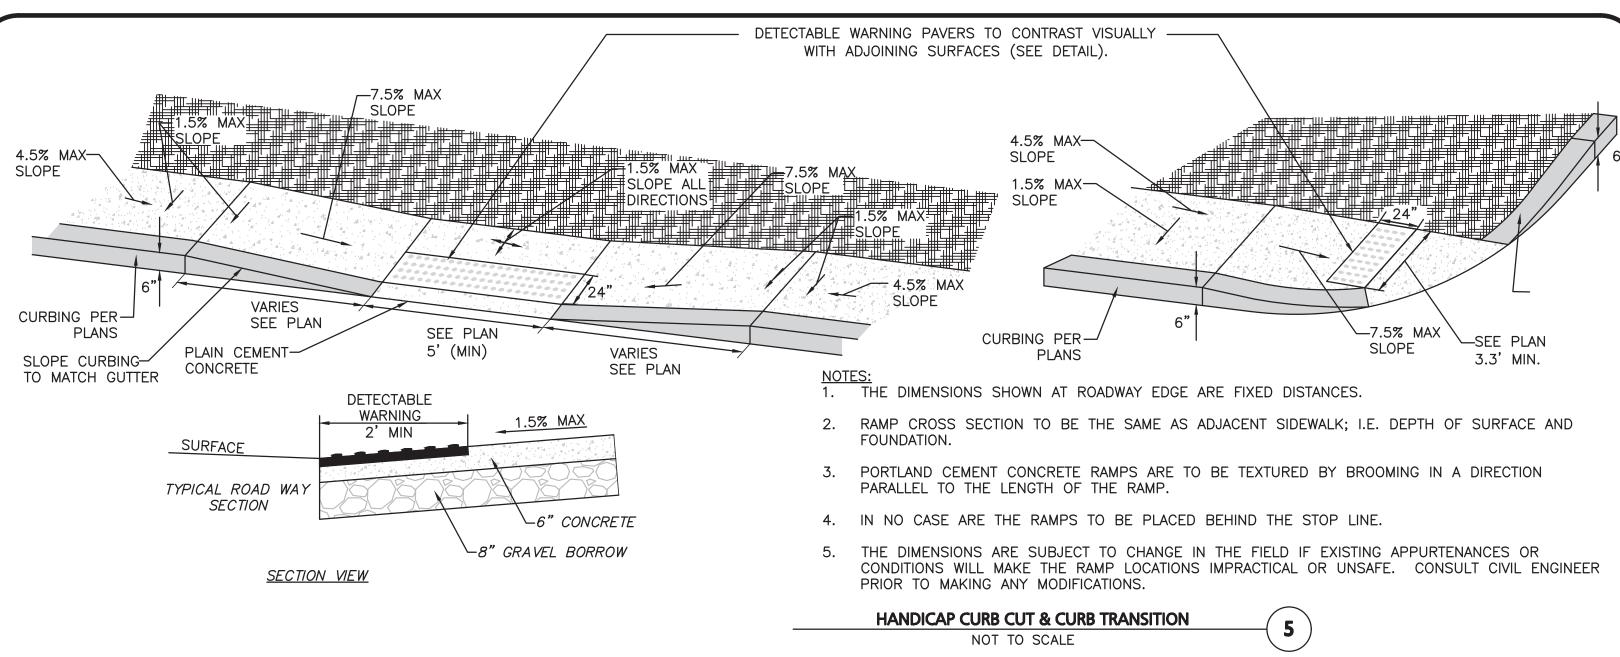


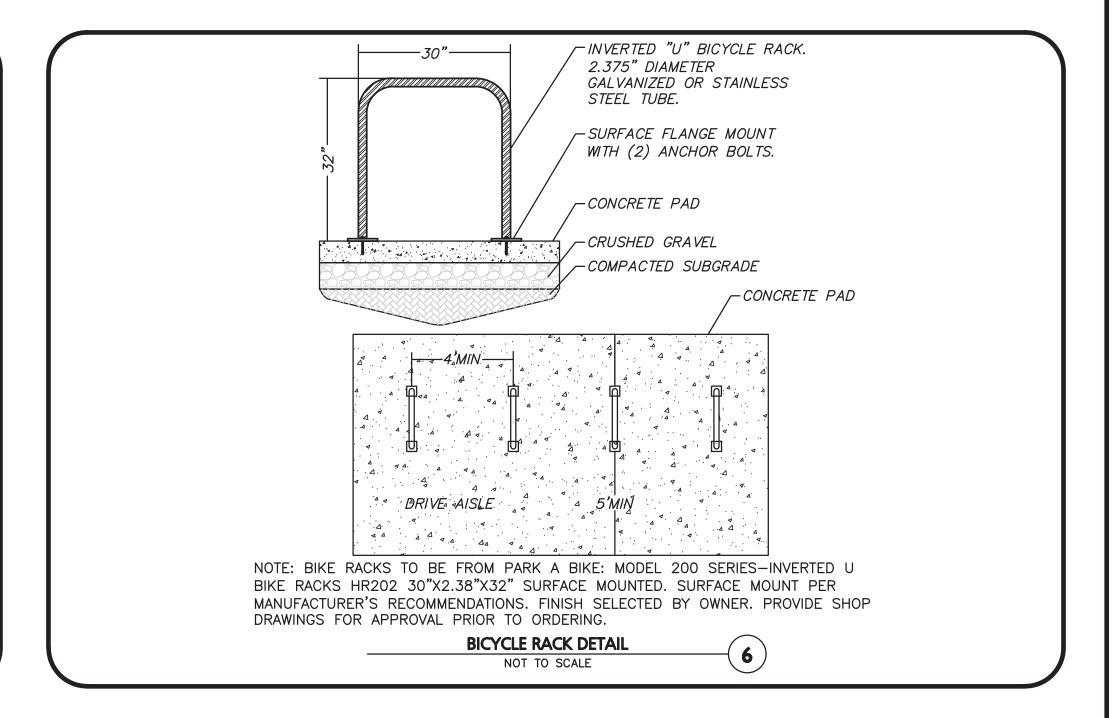


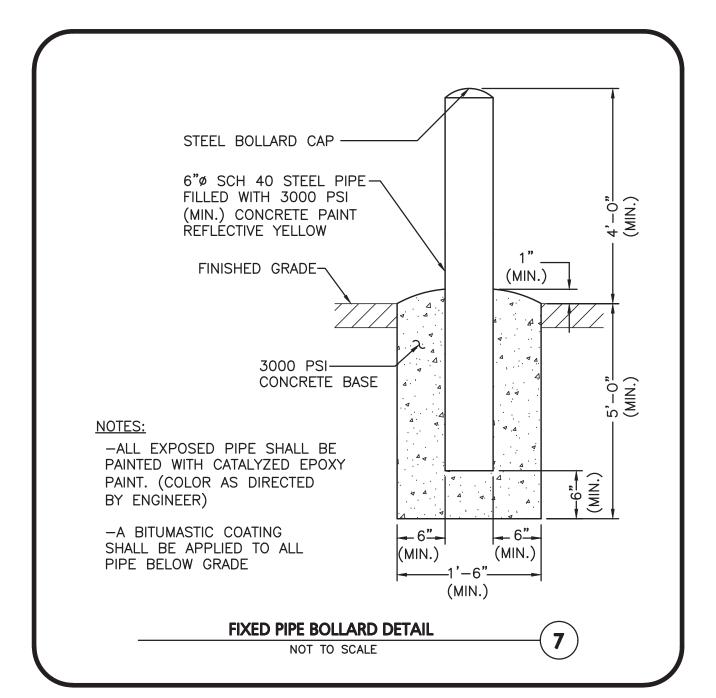

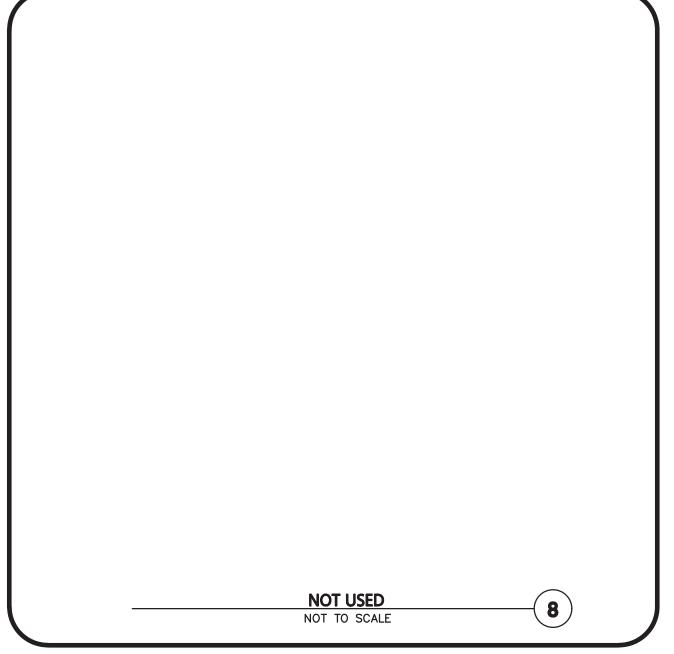

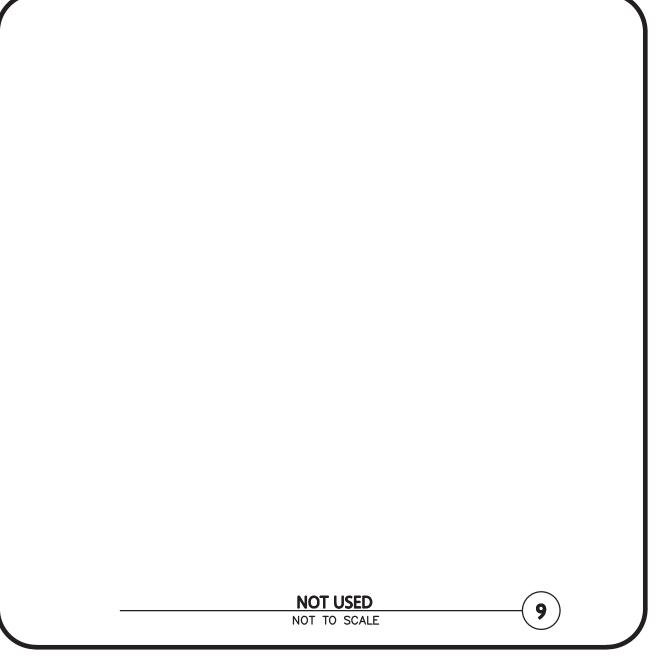

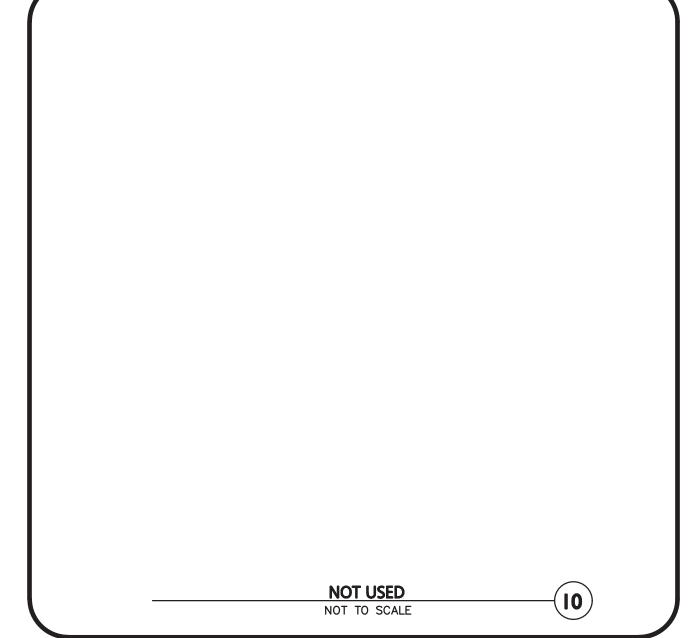

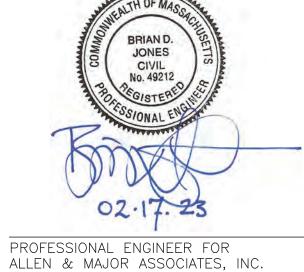

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PROJECT NO. 2729-02 DATE: 12-19-22 AS SHOWN DWG. NAME: C2729-02 BDJ CHECKED BY: **DESIGNED BY:**



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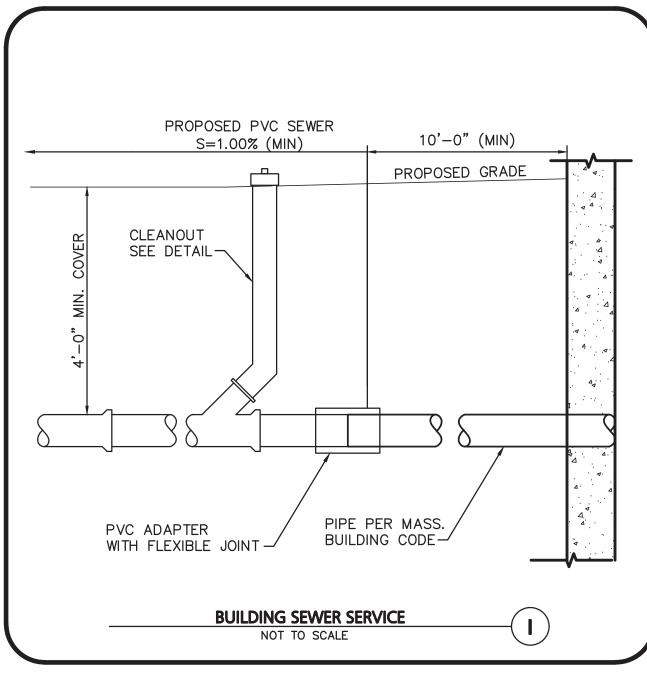
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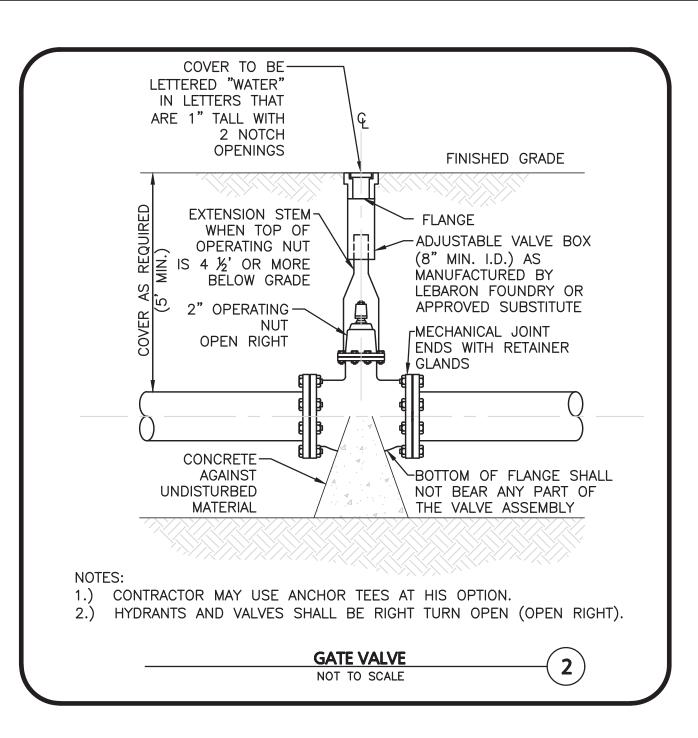
DETAILS


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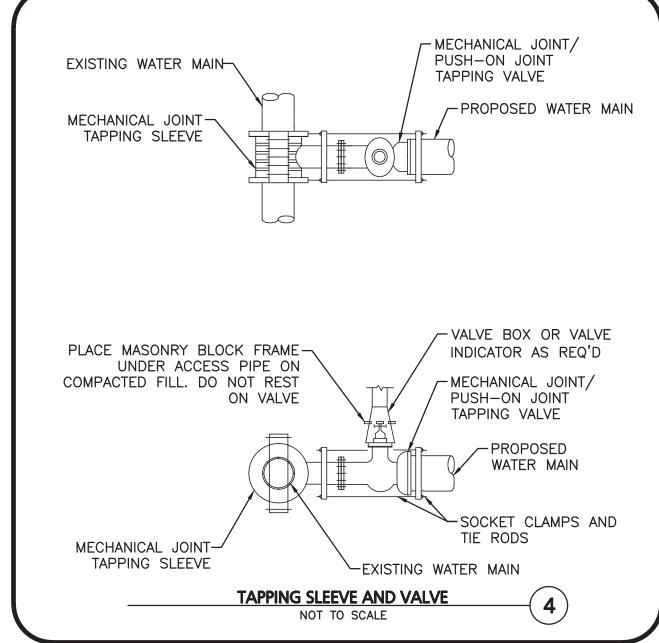
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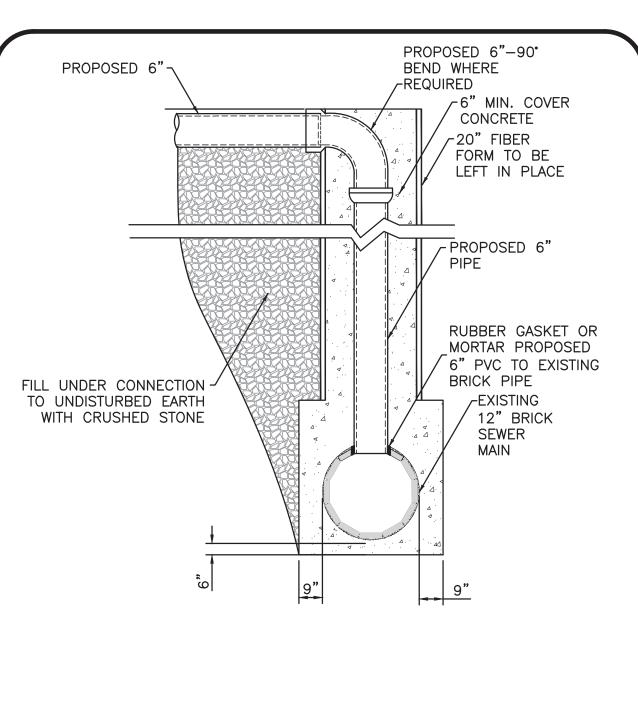
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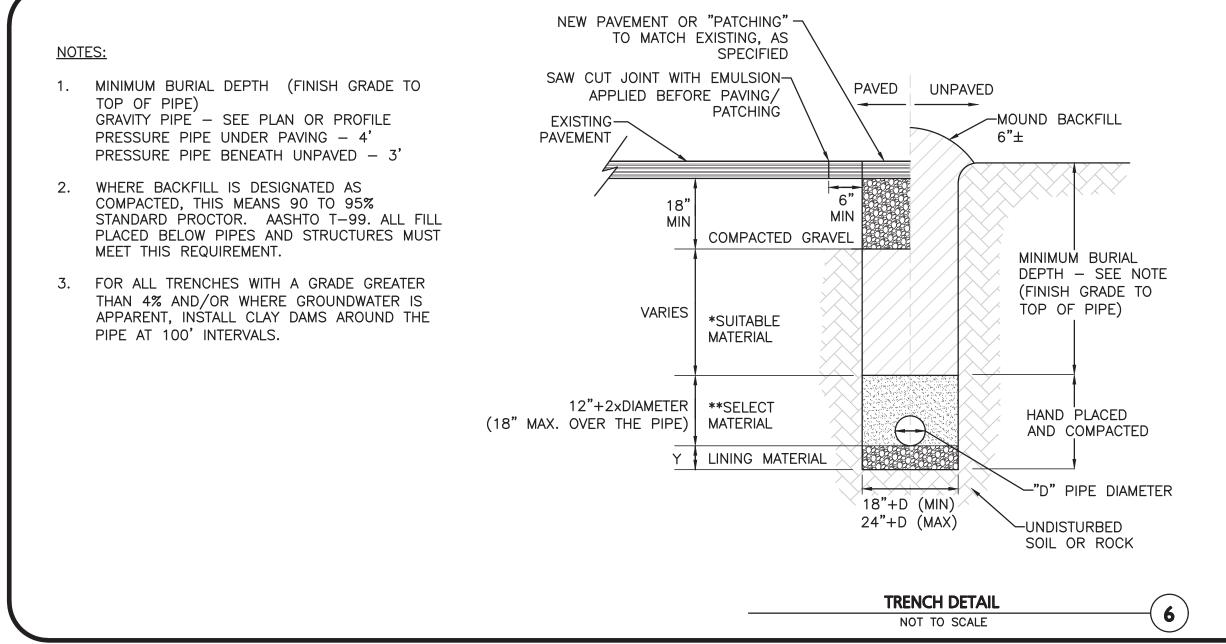










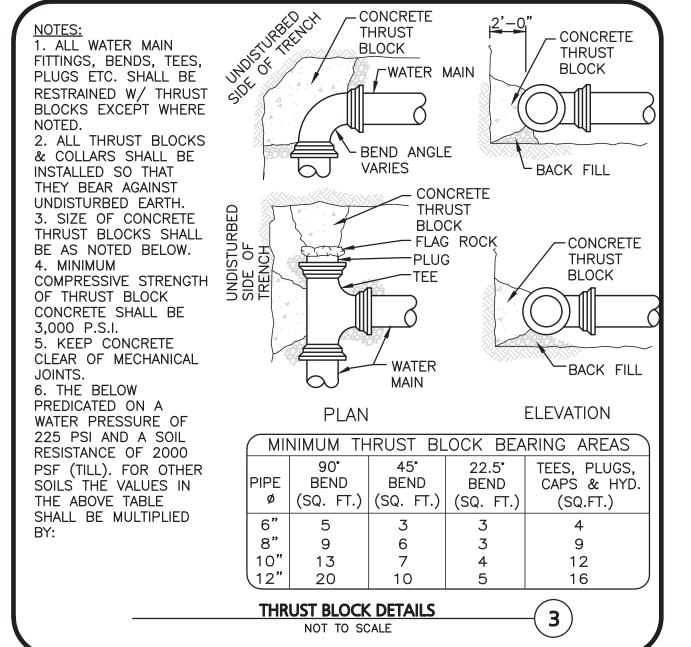


CONDITION & PIPE	**SELECT MATERIAL	LINING MATERIAL	Y-DIMENSION
DUCTILE IRON "ORDINARY SOIL"	TYPE I, II, OR III	SAND OR TYPE III	3"
RCP "ORDINARY SOIL"	TYPE II OR III	SAND OR TYPE III	3"
ALL PIPE OVER BEDROCK OR LEDGE	TYPE II OR III	SAND OR TYPE III	8"
DUCTILE IRON IN CLAY OR MUCK	TYPE II OR III	SAND	4"
RCP IN CLAY	TYPE II OR III	SAND	8"
ALL PLASTICS	TYPE III	SAND OR TYPE III	6"

* SUITABLE MATERIAL SHALL CONTAIN NO STONE GREATER THAN 4" IN DIAMETER, NO FROZEN LUMPS, AND ONLY MINOR AMOUNTS OF CLAY OR ORGANIC MATERIAL. ALL MATERIAL TO BE PLACED IN MAX 12" LIFTS AND COMPACTED BEFORE PLACING NEXT LIFT.

**TYPE I MATERIAL SHALL BE EITHER GRAVEL OR EXCAVATED MATERIAL CONTAINING NO STONES GREATER THAN 1.5" DIAMETER, NO FROZEN LUMPS, CLAY OR ORGANIC MATERIAL.

**TYPE II MATERIAL SHALL BE CLEAN, HARD, CRUSHED OR NATURAL STONE WITH A GRADATION BY WEIGHT OF 100% PASSING A 1.5" SQUARE OPENING, NOT MORE THAN 25% PASSING A ₹" OPENING, AND NOT MORE THAN 5% PASSING A 2" SQUARE OPENING.

**TYPE III MATERIAL SHALL BE CLEAN, HARD, CRUSHED STONE FREE FROM COATINGS AND THOROUGHLY WASHED WITH A GRADATION BY WEIGHT OF 100% PASSING A 1" SQUARE OPENING, AND 0 TO 5% PASSING A 4" SQUARE OPENING.

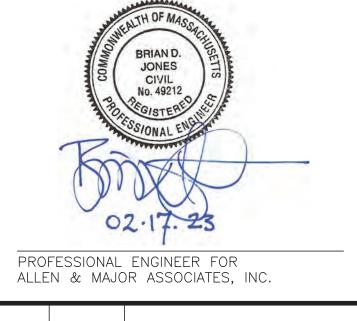

02-17-23 REVISION 1 PER ARB COMMENTS

REV DATE DESCRIPTION

APPLICANT\OWNER:

192-200 MASSACHUSETTS AVE, LLC 455 MASSACHUSETTS AVE, STE 1 ARLINGTON, MA 02474

PROJECT:

190 & 192-200 MASSACHUSETTS AVE ARLINGTON, MA 02476

PROJECT NO. 2729-02 DATE: 12-19-22 SCALE: AS SHOWN DWG. NAME: C2729-02 **DESIGNED BY:** BDJ | CHECKED BY:




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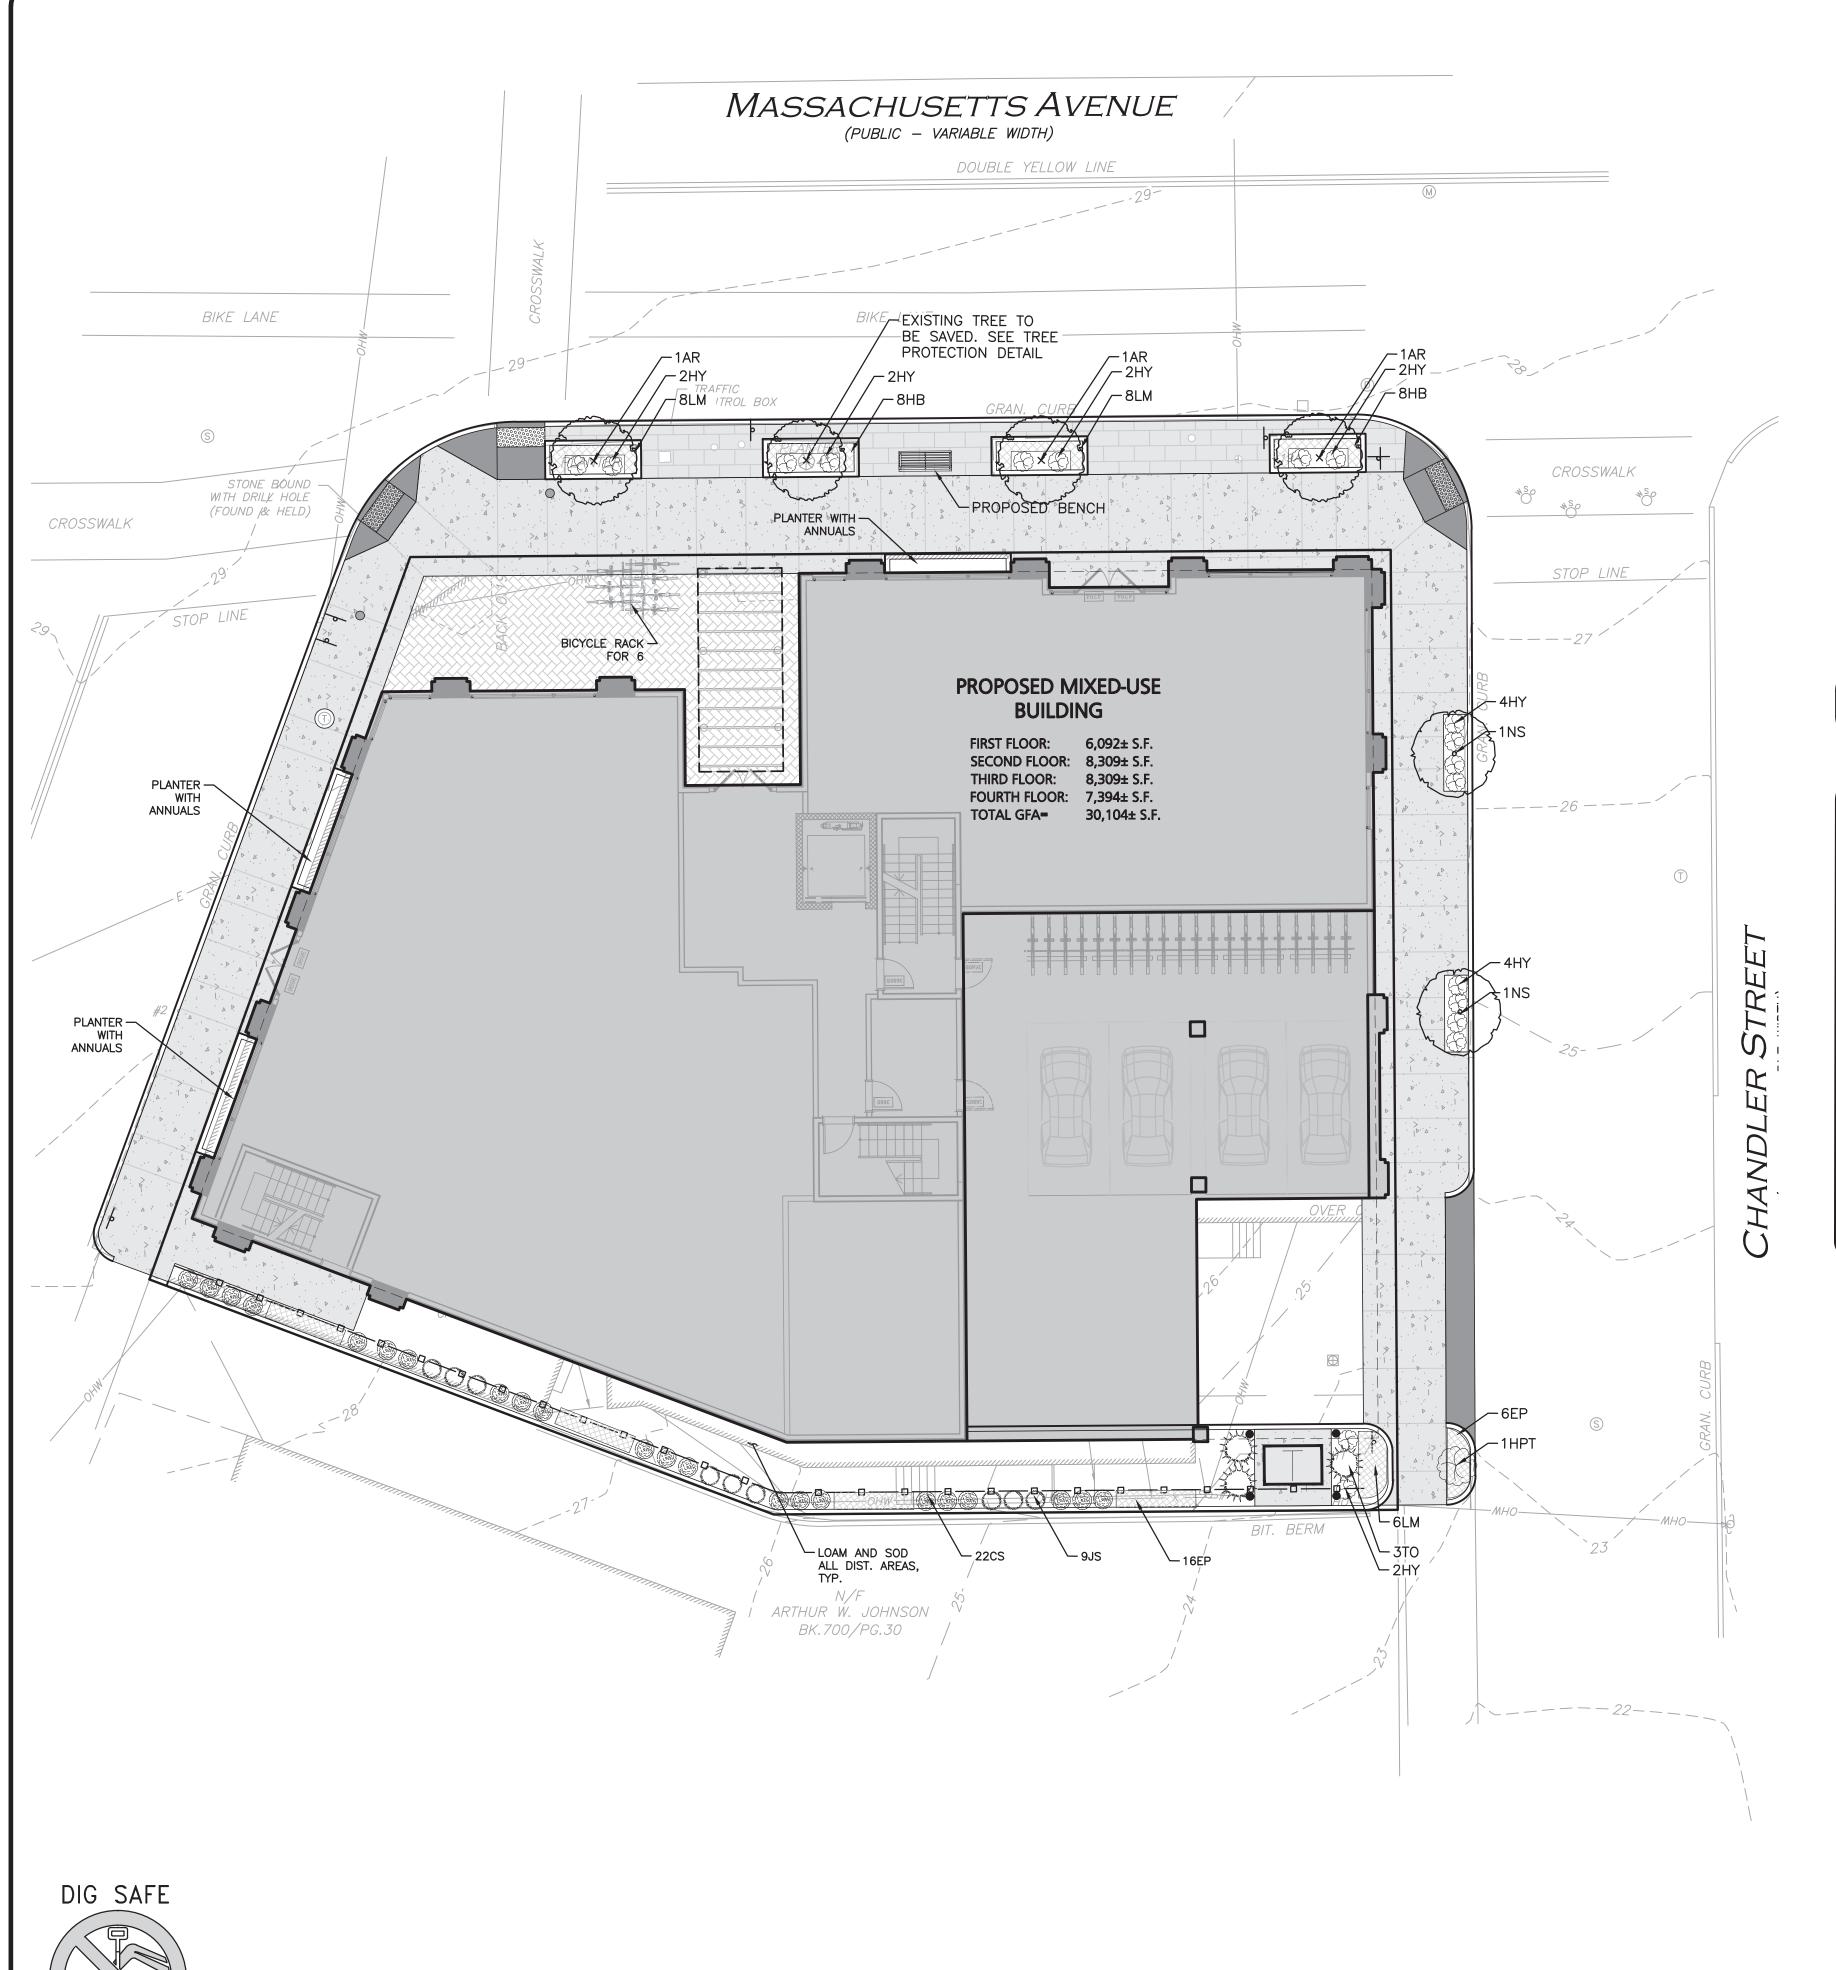
DETAILS


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BEFORE YOU DIG CALL 811 OR

1-888-DIG-SAFE

1-888-344-7233



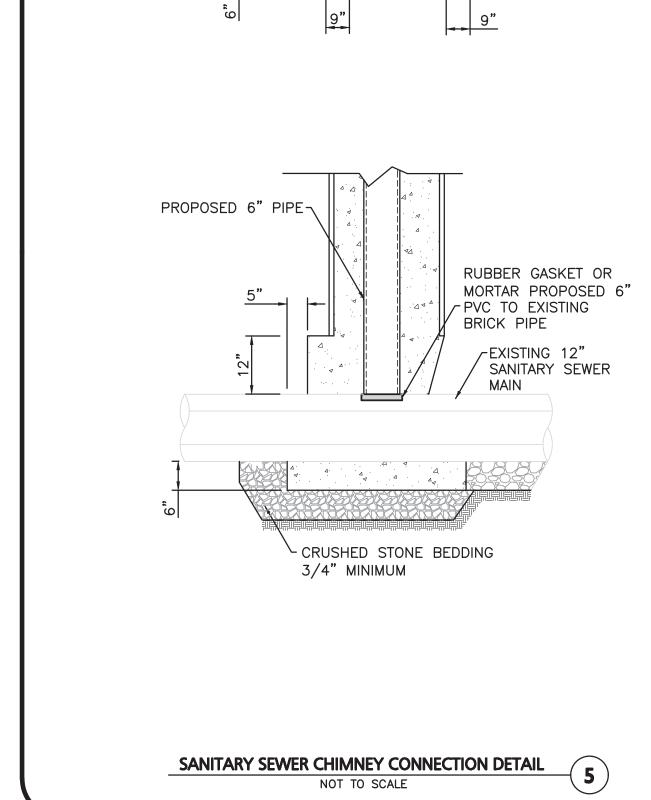

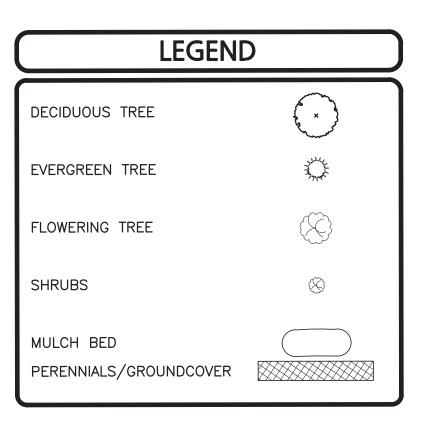
PLANTING SCHEDULE-TREES, SHRUBS, GROUNDCOVERS & PERENNIALS

KEY	QUANTITY	BOTANICAL NAME	COMMON NAME	MIN. SIZE	SPACING	COMMENTS
EVERG	REEN TREES				I	
JS	9	JUNIPER S. 'WOODWARD'	WOODWARD COLUMNAR JUNIPER	6-7' HT	AS SHOWN	B&B
TO	3	THUJA O. 'WINTERGREEN'	WINTERGREEN ARBORVITAE	6-7' HT	AS SHOWN	B&B
TREES	S/SHRUBS					
AR	3	ACER RUBRUM 'RED SUNSET'	RED SUNSET RED MAPLE	2.5-3" CAL.	AS SHOWN	B&B
NS	2	NYSSA SYLVATICA 'GREEN GABLE'	GREEN GABLE TUPELO	2.5-3" CAL.	AS SHOWN	B&B
CS	22	CORNUS STOLONIFERA 'KELSEYI'	KELSYI DWARF RED TWIG DOGWOOD	#5	AS SHOWN	POT
HPT	1	HYDRANGEA PANICULATA 'LIMELIGHT' TREE FORM	TREE FORM LIMELIGHT HYDRANGEA	5-6' HT. TREEFORM	AS SHOWN	B&B
HY	18	HYDRANGEA ARBORESCENS "INVINCEBELLE WEE WHITE"	INVINCIBELLE WEE WHITE HYDRANGEA	#3	AS SHOWN	POT
PEREN	NNIALS					
EP	22	ECHINACEA PURPUREA 'POW WOW WILDBERRY'	POW WOW WILDBERRY ECHINACEA	#1	24" O.C	STAGGERED
LM	22	LAMIUM MACULATUM 'ORCHID FROST'	ORCHID FROST LAMIUM	#1	24" O.C	STAGGERED
НВ	16	HOSTA 'HADSPEN BLUE'	HADSPEN BLUE HOSTA	#1	24" O.C	STAGGERED

STREET TREES SELECTED FROM THE ARLINGTON TREE COMMITTEE RECOMMENDED TREE LIST: HTTPS://WWW.ARLINGTONTREES.ORG/RECOMMENDED-URBAN-TREES
*SEASONAL ANNUALS TO BE INSTALLED FOR BUILDING PLANTER BOXES. PROVEN WINNERS TROPICAL SMOOTHIE MIX FOR SPRING/SUMMER; MUMS FOR FALL OR EQUAL. SEE DETAIL.

NOTES:

- 1. THE INFORMATION SHOWN ON THIS PLAN IS THE SOLE PROPERTY
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 PROVIDE INFORMATION. ANY ALTERATION, MISUSE, OR RECALCULATION
 OF INFORMATION OR DATA WITHOUT THE EXPRESSED, WRITTEN
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 PROHIBITED.
- ALL LANDSCAPED AREAS WITH SHRUBS, TREES, AND PERENNIALS TO HAVE 18" MINIMUM DEPTH OF TOPSOIL. EIGHTEEN INCHES OF TOPSOIL AROUND TREES AND SHRUBS DOES NOT INCLUDE AMENDED PLANTING SOIL WITHIN TREE / SHRUB PIT FOR FULL DEPTH OF ROOTBALLS. SEE PLANTING DETAILS FOR PLANTING DEPTH AT SHRUBS AND TREES. ALL AREAS OF LOAM AND SEED OR LOAM & SOD TO HAVE 6" MINIMUM DEPTH OF TOPSOIL. TOPSOIL TO BE TESTED BY CONTRACTOR, AND APPROVED BY A&M PRIOR TO PURCHASE AND OR PLACEMENT. GENERAL CONTRACTOR, DEMOLITION CONTRACTOR, AND LANDSCAPE CONTRACTOR TO COORDINATE PROPER DEPTH OF EXISTING MATERIAL REMOVAL ACROSS SITE SO THAT 18" MINIMUM AND 6" MINIMUM DEPTHS OF PROPOSED TOPSOIL NOTED ABOVE ARE MET AT NO ADDITIONAL COST TO OWNER. SEE TOPSOIL DETAIL.

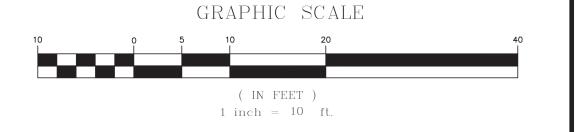



REGISTERED LANDSCAPE ARCHITECT FOR ALLEN & MAJOR ASSOCIATES, INC.

1 02-17-23 REVISION 1 PER ARB COMMENTS
REV DATE DESCRIPTION

APPLICANT\OWNER:

192-200 MASSACHUSETTS AVE, LLC 455 MASSACHUSETTS AVE, STE 1 ARLINGTON, MA 02474

PROJECT:

190 & 192-200 MASSACHUSETTS AVE ARLINGTON, MA 02476

 PROJECT NO.
 2729-02
 DATE:
 12-19-22

 SCALE:
 1" = 10'
 DWG. NAME:
 C2729-02

 DESIGNED BY:
 BCD
 CHECKED BY:
 RPC



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DRAWING TITLE:

IDSCAPE PLAN I -101

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LANDSCAPE PLAN

LANDSCAPE NOTES

- 1. ALL WORK SHALL BE IN ACCORDANCE WITH THE REQUIREMENTS OF THE TOWN OF ARLINGTON, MA.
- PLANTING PLAN IS DIAGRAMMATIC IN NATURE. FINAL PLACEMENT OF PLANTS TO BE APPROVED BY THE LANDSCAPE ARCHITECT IN THE FIELD.
- THE CONTRACTOR SHALL BE RESPONSIBLE FOR CONTACTING ALL UTILITY COMPANIES, ANY BLUEGRASS, CHALLENGER KENTUCKY BLUEGRASS, BLACKBURG II KENTUCKY BLUEGRASS OR PERMITTING AGENCIES, AND "DIG-SAFE" (1-888-344-7233) AT LEAST 72 HOURS IN ADVANCE OF ANY WORK THAT WILL REQUIRE EXCAVATION. CONTRACTOR SHALL NOTIFY THE OWNERS REPRESENTATIVE OF NAY CONFLICTS IN WRITING.
- NO PLANT MATERIAL SHALL BE INSTALLED UNTIL ALL GRADING AND CONSTRUCTION HAS BEEN COMPLETED IN THE IMMEDIATE AREA, ANY TREES NOTED AS "SEAL OR SELECTED SPECIMEN" SHALL BE TAGGED AND SEALED BY THE LANDSCAPE ARCHITECT.
- ALL TREES SHALL BE BALLED AND BURLAPPED (B&B) UNLESS OTHERWISE NOTED OR APPROVED BY THE OWNER'S REPRESENTATIVE AND LANDSCAPE ARCHITECT.
- CONTRACTOR SHALL VERIFY QUANTITIES SHOWN ON PLANT LIST. QUANTITIES SHOWN ON PLANS SHALL GOVERN OVER PLANT LIST.
- ANY PROPOSED PLANT SUBSTITUTIONS MUST BE APPROVED IN WRITING BY OWNER'S REPRESENTATIVE AND LANDSCAPE ARCHITECT.
- ALL PLANT MATERIALS INSTALLED SHALL MEET THE GUIDELINES ESTABLISHED BY THE STANDARDS FOR NURSERY STOCK PUBLISHED BY THE AMERICAN ASSOCIATION OF NURSERYMEN.
- ALL PLANT MATERIALS SHALL BE GUARANTEED FOR ONE YEAR FOLLOWING DATE OF ACCEPTANCE.
- 10. ALL DISTURBED AREAS NOT OTHERWISE NOTED SHALL RECEIVE 6" OF SUITABLE LOAM & SEED LAWNS WITH 3:1 OR GREATER SLOPES SHALL BE PROTECTED WITH AN EROSION CONTROL BLANKET.
- 11. ANY FALL TRANSPLANTING HAZARD PLANTS SHALL BE DUG IN THE SPRING AND STORED FOR FALL PLANTING.
- 12. TREES SHALL HAVE A MINIMUM CALIPER AS INDICATED ON THE PLANTING SCHEDULE TAKEN ONE FOOT ABOVE THE ROOT CROWN.
- 13. ALL PLANT BEDS AND TREE SAUCERS TO RECEIVE 3" OF PINE BARK MULCH. GROUND COVER AREAS SHALL RECEIVE 1" OF PINE BARK MULCH
- 14. ALL DECIDUOUS TREES ADJACENT TO WALKWAYS AND ROADWAYS SHALL HAVE A BRANCHING PATTERN TO ALLOW FOR A MINIMUM OF 7' OF CLEARANCE BETWEEN THE GROUND AND THE LOWEST BRANCH.
- 15. ALL TREE STAKES SHALL BE STAINED DARK BROWN.
- 16. CONTRACTOR RESPONSIBLE FOR WATERING, AND RESEEDING OF BARE SPOTS UNTIL A UNIFORM STAND OF VEGETATION IS ESTABLISHED AND ACCEPTED.
- 17. ALL PARKING ISLANDS PLANTED WITH SHRUBS SHALL HAVE 24" OF TOP SOIL. FINISH GRADE SHALL BE EQUAL TO THE TOP OF CURB.
- 18. SOIL SAMPLES, TESTS, AND SHOP DRAWINGS SHALL BE PROVIDED TO THE LANDSCAPE ARCHITECT OR THE OWNER FOR APPROVAL PRIOR TO CONSTRUCTION.
- 19. AN MINIMUM 18" WIDE BARRIER OF 1" GRAY OR TAN PEASTONE SHALL BE INSTALLED IN ALL PLANT BEDS WHICH ABUT THE BUILDINGS. NO MULCH IS ALLOWED WITHIN 18" OF ALL BUILDINGS PER THE LATEST EXECUTIVE OFFICE OF PUBLIC SAFETY AND SECURITY DEPARTMENT OF FIRE SERVICES REGULATION (527 CMR 17.00). INSTALL 6" DEEP OF PEASTONE WITH MIRAFI WEED FABRIC BENEATH AND STEEL EDGING BETWEEN THE PEASTONE AND ADJACENT MULCH BED.
- 20. ALL PROPOSED LANDSCAPE AREAS INCLUDING MOWED LAWNS, TREES, SHRUB BEDS, AND PERENNIALS SHALL BE PROVIDED WITH WATER EFFICIENT UNDERGROUND IRRIGATION. DESIGN AND INSTALLATION OF IRRIGATION SYSTEM TO BE PERFORMED BY AN APPROVED IRRIGATION DESIGN BUILD CONTRACTOR OR BY AN APPROVED EQUAL, TO BE DETERMINED BY THE OWNERS REPRESENTATIVE AND LANDSCAPE ARCHITECT. IRRIGATION SYSTEM IS TO BE DESIGNED FOR EFFICIENT WATER USAGE INCLUDING: USE OF DRIP IRRIGATION FOR SHRUBS AND PERENNIALS, IRRIGATION SYSTEM WITH HEAD-TO-HEAD COVERAGE, A CENTRAL SHUT-OFF VALVE, AND A RAIN SENSOR TO SHUT OFF IRRIGATION DURING RAIN



PROVEN WINNERS ANNUALS FOR POTS OR EQUAL

NOT TO SCALE

LOAM AND SODDING NOTES

CONTRACTOR SHALL SOD AREAS NOTED ON THE PLANS.

SOD IS TO BE A BLEND OF FOUR TO FIVE CURRENT AND IMPROVED HYBRID BLUEGRASS AND FESCUE MIXES APPROPRIATE FOR BOTH SEMI-SHADED AND AREAS OF SUN.


HYBRIDS MAY INCLUDE: BLACKSTONE KENTUCKY BLUEGRASS, AWARD KENTUCKY COMPARABLE AND EQUAL BLUEGRASS HYBRIDS.

. SOD SHALL BE HIGH QUALITY, NURSERY GROWN ON CULTIVATED MINERAL AGRICULTURAL SOILS. SOD SHALL BE MOIST, AND MACHINE CUT AT A UNIFORM SOIL THICKNESS OF AT LEAST %" AT TIME OF CUTTING. MEASUREMENT FOR THICKNESS SHALL INCLUDE TOP GROWTH AND THATCH. SOD SHALL BE FREE OF DISEASES, WEEDS, BARE SPOTS, OR INSECTS.

2. SODDING TO BE COMPLETED "IN SEASON" BETWEEN APRIL 1 TO JUNE 15 OR AUGUST 15 TO OCTOBER 1, EXCEPT FOR RE-SODDING OF BARE SPOTS. IF UNABLE TO SOD WITHIN THESE TIMEFRAMES, CONTRACTOR TO INSTALL EROSION CONTROL MATS ON ALL SLOPES 3:1 AND OVER, HYDROSEED ALL EXPOSED AREAS, ADD SOIL STABILIZER "FLUX TERRA HP-FGM SOIL STABILIZER" AS MANUFACTURED BY "PROFILE" TO HYDROSEED (AT RATE OF 3,000 LBS PER ACRE), AT NO ADDITIONAL COST TO THE OWNER. CONTRACTOR TO COMPLETE ALL ABOVE "OUT OF SEASON" REQUIREMENTS AND THEN ALSO BE RESPONSIBLE FOR RE—GRADING AND RE—SODDING ALL DISTURBED, ERODED, OR BARE SPOTS WITHIN NEXT CLOSEST PLANTING SEASON IN FALL OR SPRING AT NO ADDITIONAL COST TO OWNER. CONTRACTOR RESPONSIBLE FOR ALL MAINTENANCE UNTIL FINAL ACCEPTANCE OF LAWN AREAS INCLUDING: WATERING, ADDING FERTILIZERS AND LIME AND MOWING AT NO ADDITIONAL COST TO OWNER.

3. COMMERCIAL FERTILIZER SHALL BE APPLIED AT THE RATE OF 25 POUNDS PER 1000 SQ. FT. OR AS RECOMMENDED BY THE TESTING AGENCY. LIME TO BE SPREAD AT THE RATE OF 100 POUNDS PER 1000 SQ. FT OR AS RECOMMENDED BY THE TESTING AGENCY COMMERCIAL FERTILIZER SHALL BE A COMPLETE FERTILIZER CONTAINING AT LEAST 50% OF THE NITROGEN OF WHICH IS DERIVED FROM NATURAL ORGANIZE SOURCES OF UREAFORM. IT SHALL CONTAIN THE FOLLOWING PERCENTAGES BY WEIGHT: NITROGEN (N) 10%, PHOSPHORUS (P) 6%, POTASH (K) 4%. LIME SHALL BE AN APPROVED AGRICULTURAL LIMESTONE CONTAINING NOT LESS THAN 85% OF TOTAL CARBONATES. LIMESTONE SHALL BE GROUND TO SUCH FINENESS THAT 50% WILL PASS A 100 MESH SIEVE AND 90% WILL PASS THROUGH A 20 MESH SIEVE.


4. CONTRACTOR RESPONSIBLE FOR WATERING, MOWING, AND RE-SODDING OF LAWN BARE SPOTS UNTIL A UNIFORM, HEALTHY STAND OF GRASS IS ESTABLISHED AND ACCEPTED.

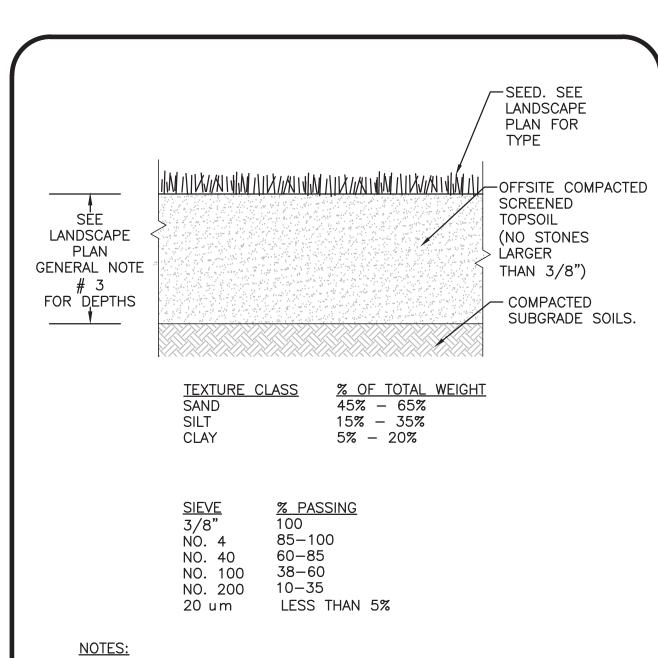

1. TOP OF LOAM (TOPSOIL) IS FINISH GRADE.

- 2. ALL TOPSOIL (BOTH ONSITE AND OFFSITE SOURCES) SHALL BE COMPOSED OF A NATURAL, FERTILE, FRIABLE SOIL TYPICAL OF CULTIVATED TOPSOILS OF THE LOCALITY. OFFSITE SOIL SHALL BE SUITABLE FOR THE GERMINATION OF SEEDS AND SUPPORT OF VEGETATIVE GROWTH, WITH ADDITIVES, IF REQUIRED, TO ACHIEVE PARTICLE DISTRIBUTION AND ORGANIC CONTENT BELOW. TOPSOIL SHALL BE TAKEN FROM A WELL-DRAINED, ARIABLE SITE, FREE OF SUBSOIL, LARGE STONES, EARTH CLODS, STICKS, STUMPS, CLAY LUMPS, ROOTS, OTHER OBJECTIONABLE, EXTRANEOUS MATTER OR DEBRIS NOR CONTAIN TOXIC SUBSTANCES.
- 3. THE CONTRACTOR SHALL PROVIDE THE OWNER / LANDSCAPE ARCHITECT WITH TOPSOIL TEST RESULTS (RECOMMEND UMASS AMHERST SOIL TESTING LAB) FOR APPROVAL PRIOR TO OBTAINING AND PLACING THE SOIL. IF ANY TOPSOIL IS PURCHASED OR PLACED PRIOR TO APPROVAL BY OWNER / LANDSCAPE ARCHITECT, IT IS AT CONTRACTORS RISK, AND IT CAN BE REMOVED AT NO ADDITIONAL COST TO THE OWNER. IF THE PLANTING SOIL (BOTH ONSITE AND OFFSITE SOURCES) DOES NOT FALL WITHIN THE REQUIRED SIEVE ANALYSIS, TEXTURAL CLASS, ORGANIC CONTENT, OR PH RANGE, IT SHALL BE ADJUSTED TO MEET THE SPECIFICATIONS THROUGH THE ADDITION OF SAND, COMPOST, LIMESTONE, OR ALUMINUM SULFATE TO BRING IT WITHIN THE SPECIFIED LIMITS AT NO ADDITIONAL COST TO
- 4. TOPSOIL SHALL HAVE A PH VALUE BETWEEN 5.5 AND 6.5. TOPSOIL SHALL CONTAIN BETWEEN 4% AND 8% ORGANIC MATTER OF TOTAL DRY WEIGHT AND SHALL CONFORM TO THE FOLLOWING GRADATION AND TEXTURE CLASS ABOVE.

TOPSOIL FOR LAWN, TREES, SHRUBS, & PERENNIALS

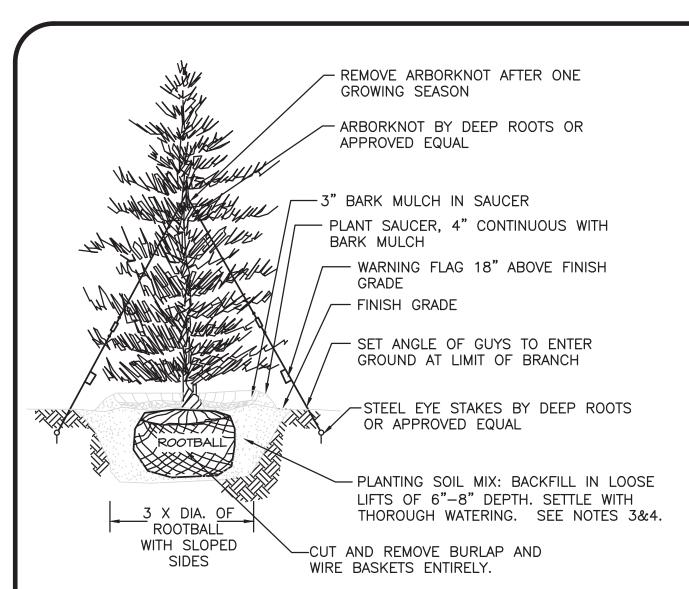

- 1. TREES SHALL BEAR SAME RELATIONSHIP TO FINISH GRADE AS IT BORE TO NURSERY OR FIELD GRADE. ROOT FLARE SHALL BE 2" ABOVE FINISH GRADE. REMOVE SOIL FROM TRUNK FLARE OF TREE TO DETERMINE ACTUAL TOP OF ROOTBALL AREA.
- 2. INSTALL THREE GUYS PER TREE; EQUALLY SPACED AROUND BALL.
- 3. ATTACH GUYS AT 2/3 HEIGHT OF TREE.
- 4. BACKFILL WITH PLANTING MIX. PLANT MIX TO BE: 50% NATIVE TOPSOIL, 20% COMPOST (LEAVES & ORGANIC MATERIAL, NO ASH) 20% PEAT MOSS, 10% SAND.
- ADD MYCORRHIZA SOIL ADDITIVES AND SLOW RELEASE FERTILIZER WHEN PLANT HOLES ARE 50% FILLED AND WATER THOROUGHLY AT

EVERGREEN TREE DETAIL NOT TO SCALE

(2) MIN. 2" X 2" X 8'— MINIMUL ARBOR TIES BY DEEP ROOTS W/////// OR APPROVED EQUAL WOOD POSTS FOR TREES UNDER 3" CALIPER WAREMOVE STAKES AFTER ONE /// GROWING SEASON 10'-0" FOR TREES > 3" CAL. 8'0" FOR TREES 3" CAL. AND ∕-3" BARK MULCH UNDER —4" EARTH SAUCER WITH BARK MULCH 6" MIN. TOPSOIL, NEW OR EXISTING CUT & REMOVE BURLAP PLANTING MIX 3'0" MIÑ AND WIRE BASKET ENTIRELY. BACK FILL SEE NOTE 2 &3. 3 X DIA. OF UNDISTURBED SOIL-ROOTBALL WITH SLOPED -ROOTBALL -REINFORCED RUBBER HOSE TREE PIT 3 POSTS FOR ALL TREES 3" CALIPER & OVER

- 1. ALL TREES SHALL HAVE THE SAME RELATIONSHIP TO FINISH GRADE AFTER PLANTING AS THEY HAD AT THE ORIGINAL NURSERY SETTING. ROOT FLARE SHALL BE 2" ABOVE FINISH GRADE. REMOVE SOIL FROM TRUNK FLARE OF TREE TO DETERMINE ACTUAL ROOTBALL AREA.
- 2. BACKFILL WITH PLANTING MIX. PLANT MIX TO BE: 50% NATIVE TOPSOIL, 20% COMPOST (LEAVES & ORGANIC MATERIAL, NO ASH) 20% PEAT MOSS, 10% SAND.
- 3. ADD MYCORRHIZA SOIL ADDITIVES AND SLOW RELEASE FERTILIZER WHEN PLANT HOLES ARE 50% FILLED AND WATER THOROUGHLY AT COMPLETION.

NOT TO SCALE

190 & 192-200 MASSACHUSETTS AVE ARLINGTON, MA 02476

MANDSCA

REGISTERED LANDSCAPE ARCHITECT FOR

02-17-23 REVISION 1 PER ARB COMMENTS

192-200 MASSACHUSETTS AVE, LLC

455 MASSACHUSETTS AVE, STE 1

ALLEN & MAJOR ASSOCIATES, INC.

DATE DESCRIPTION

ARLINGTON, MA 02474

REV

PROJECT:

APPLICANT\OWNER:

2729-02 DATE: PROJECT NO. 12-19-22 SCALE: NTS DWG. NAME: C2729-0 **DESIGNED BY:** BCD | CHECKED BY:



civil engineering ♦ land surveying nvironmental consulting • landscape architectur www.allenmajor.com 100 COMMERCE WAY, SUITE 5 WOBURN MA 01801 TEL: (781) 935-6889

WOBURN, MA ♦ LAKEVILLE, MA ♦ MANCHESTER, N

FAX: (781) 935-2896


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SHEET No. L-501 LANDSCAPE DETAILS

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PARKING SUMMARY TABLE

USE	CALCULATION	MIN. REQUIRED	TOTAL PROPOSED	
	1.0 SPACES PER EFFICIENCY UNIT	2.0	0	
	2 X 1.0 = 2.0			
	1.15 SPACES PER 1 BED UNIT	26.5	21	
APARTMENT BUILDING	23 X 1.15 =32.2	20.5	21	
	1.5 SPACES PER 2 BED UNIT	10.0	5	
	5 X 2 = 10.0	10.0	J	
GENERAL RETAIL/RESTAURANT	1 PER 300 SF			
	1,851 SF (1ST 3,000 SF IS EXEMPT)	6.2	0	
		44.7	26*	

ADA SPACES REQUIRED:

(26-50) TOTAL PARKING SPACES PROVIDED, 2 SHALL BE THE MINIMUM ADA PARKING PROVIDED, 1 SPACES BEING VAN ACCESSIBLE.

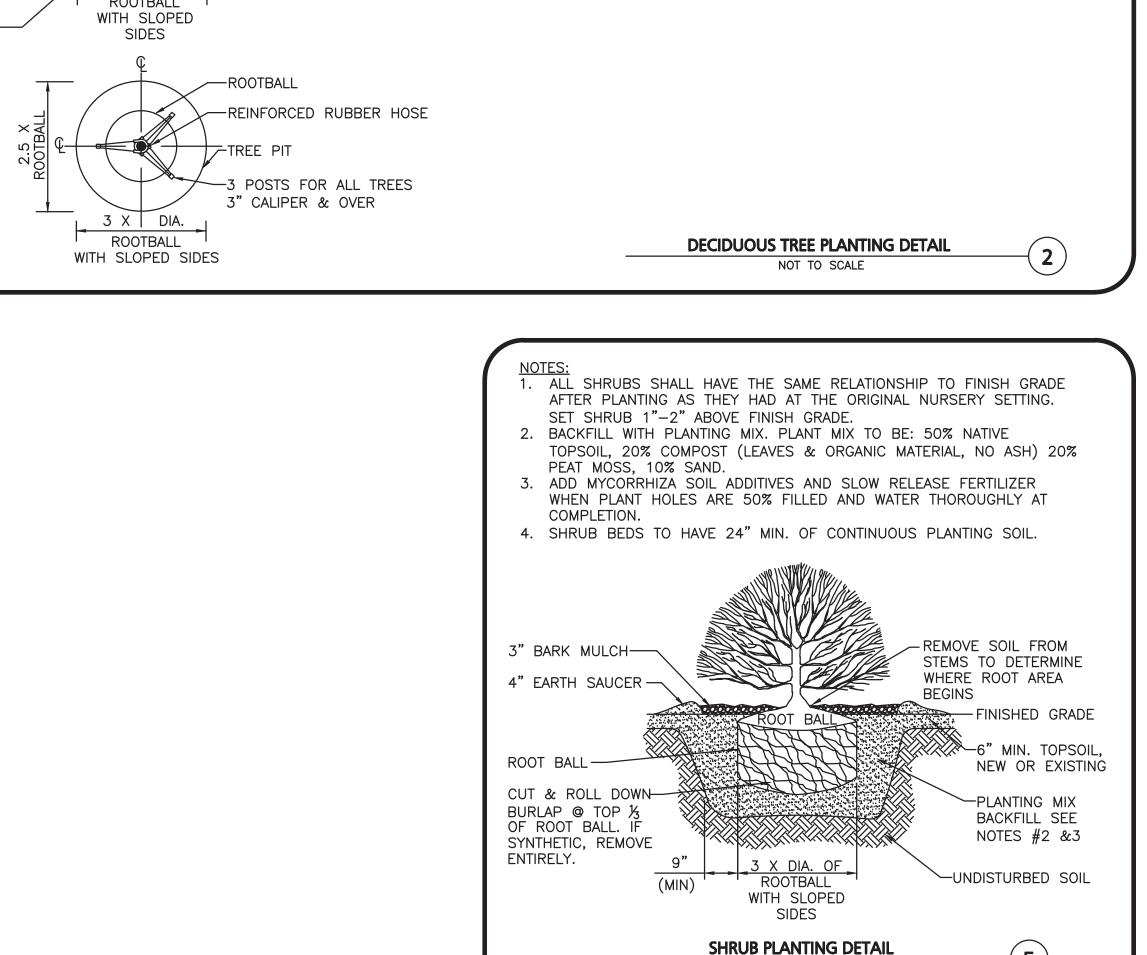PROVIDED 2 SPACES, 1 BEING VAN ACCESSIBLE.

1. SECTION 6.1.10, C. FOR A MIXED-USE DEVELOPMENT THE FIRST 3,000 SF OF NON-RESIDENTIAL SPACE IS EXEMPT FROM THE PARKING REQUIREMENTS OF THIS SECTION 6.1.

2. SECTION 6.1.11, STANDARD PARKING STALLS SHALL BE 8.5'X18', AND DRIVE AISLE WIDTH SHALL BE 24' FOR TWO-WAY TRAFFIC.

* RELIEF REQUESTED FROM THE ARB FOR THE REQUIRED NUMBER OF PARKING STALLS. ALSO ARB SPECIAL PERMIT IS REQUEST FOR UP TO 20% COMPACT PARKING SPACES.

BICYCLE PARKING SUMMARY TABLE

LONG TERM BICYCLE PARKING (INTERIOR)

CALCULATION

1.5 PER UNIT

REQUIRED

REQUIRED

 $30 \times 1.5 = 45.0$

0.1 PER 1,000 SF

TOTAL

-PROPOSED PLANTER BOX

WITH FLUSH VGC (10'X4')

 $|4.7 \times 0.1| = 0.5$

USE

APARTMENT

BUILDING

SERVICE

-CONCRETE PAVERS PER

MIN. REQUIRED

45.0

0.5

45.5

TOTAL PROPOSED

48

48

SHORT TERM BICYCLE PARKING (EXTERIOR)				
USE	CALCULATION	MIN. REQUIRED	TOTAL PROPOSED	
APARTMENT	0.1 PER UNIT	7.0	7	
BUILDING	30 X 0.1 = 3.0 REQUIRED	3.0	3	
RETAIL SERVICE	0.6 PER 1,000 SF		7	
	4.7 X 0.6 = 3.0 REQUIRED	2.8	3	
	TOTAL	5.8	6	

BICYCLE PARKING TABLE NOTES: 1. REQUIRED NUMBER OF SPACES ARE FROM BICYCLE PARKING GUIDELINES. APPENDIX A BIKE PARKING BY-LAW.

RECONSTRUCT PLANTER

LEGEND

PROPERTY LINE SIGN BOLLARD BUILDING BUILDING INTERIOR WALLS CURB PARKING STRIPING ROADWAY STRIPING SIDEWALK ADA ACCESSIBLE RAMP ADA DET. WARNING SURFACE 80808080

CONCRETE PAVERS SNOW STORAGE

SAW-CUT LINE PARKING COUNT VINYL FENCE

MASSACHUSETTS AVENUE (PUBLIC - VARIABLE WIDTH)

DOUBLE YELLOW LINE

ZONING SUMMARY TABLE B3-VILLAGE BUSINESS (MIXED-USE >20,000 SF)

ITEM	REQUIRED/ ALLOWED	EXISTING	PROPOSED
MINIMUM LOT AREA	>20,000 SF	11,134± SF	11,134±* SF
MINIMUM LOT AREA PER UNIT	600 SF	N/A	348±* SF
MINIMUM FRONTAGE	50 FT	102.1± FT MASS AVE	102.1± FT MASS AVE
MINIMUM FRONT YARD SETBACK	O FT	O FT	0.6 FT
MINIMUM SIDE YARD SETBACK	O FT	0.6 FT	7.5 FT
MINIMUM REAR YARD SETBACK	(H+L)/6	NO REAR	NO REAR
SCREENING BUFFER	7.5 FT ⁽³⁾	0.6 FT	7.5 ⁽³⁾
LANDSCAPED OPEN SPACE	10% ⁽²⁾	0.9%	4.2%*
USABLE OPEN SPACE	20% ⁽²⁾	0%	7.4%*
MAXIMUM HEIGHT	50 FT	20± FT	45± FT
MAXIMUM HEIGHT STORIES	5	1	4 ⁽¹⁾
FLOOR AREA RATIO	2.8	0.9	2.7

SECTION 5.3.17, FOR BUILDING MORE THAN 3 STORIES IN HEIGHT, AN ADDITIONAL 7.5 FT STEP-BACK SHALL BE PROVIDED BEGINNING AT THE THIRD STORY LEVEL OR 30 FT ABOVE GRADE, WHICHEVER IS LESS. THE UPPER STORY STEP-BACK SHALL BE

PROVIDED ALONG ALL BUILDING ELEVATIONS WITH STREET FRONTAGE. 2. SECTION 5.3.21. SUPPLEMENTAL REQUIREMENTS IN THE BUSINESS AND INDUSTRIAL DISTRICTS, D. FOR MIXED USES AND ANY PERMITTED RESIDENTIAL USE NOT SPECIFICALLY IDENTIFIED IN THE TABLES IN SECTION 5.5.2, THE MINIMUM OPEN SPACE REQUIREMENTS (COMPUTED FROM THE RESIDENTIAL FLOOR AREA ONLY) SHALL BE 10% LANDSCAPED AND 20% USABLE IN THE B1, B2, B2A, B3, AND B4 DISTRICTS, AND 15 PERCENT USABLE IN THE B5 DISTRICT.

3. SECTION 5.3.21. SUPPLEMENTAL REQUIREMENTS IN THE BUSINESS AND INDUSTRIAL DISTRICTS, B3 ABUTTING R5 15 FT MINIMUM BUFFER. A SOLID WALL OR WOODEN FENCE MAY BE SUBSTITUTED FOR ONE-HALF THE WIDTH OF THE LANDSCAPED BUFFER.

4. TOTAL RESIDENTIAL FLOOR AREA (PROVIDED BY ARCHITECT): 19,065 S.F. 5. TOTAL RETAIL FLOOR AREA (PROVIDED BY ARCHITECT): 4,851 S.F.

6. GROSS FLOOR AREA (PROVIDED BY ARCHITECT): 30,104 S.F.

* RELIEF REQUESTED FROM ARB.

NOTES

STREI

ER

YANDLI (PUBLIC - V

- WRITTEN DIMENSIONS ON THIS PLAN TAKE PRECEDENCE OVER SCALED DIMENSIONS. THE CONTRACTOR SHALL USE CAUTION WHEN SCALING REPRODUCED PLANS. IN THE EVENT OF A CONFLICT BETWEEN THIS PLAN SET AND ANY OTHER DRAWINGS AND/OR SPECIFICATIONS OR CONDITIONS, THE ENGINEER SHALL BE NOTIFIED BY THE CONTRACTOR. ALL SITE ITEMS SHALL BE LAID OUT AND AS BUILT BY A LICENSED LAND SURVEYOR.
- 2. ALL CURB RADII ARE 3' UNLESS OTHERWISE NOTED.
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(IN FEET) 1 inch = 10 ft.

PROFESSIONAL ENGINEER FOR

ALLEN & MAJOR ASSOCIATES, INC.

02-17-23 REVISION 1 PER ARB COMMENTS REV DATE DESCRIPTION

APPLICANT\OWNER:

192-200 MASSACHUSETTS AVE, LLC 455 MASSACHUSETTS AVE, STE 1 ARLINGTON, MA 02474

PROJECT:

190 & 192-200 MASSACHUSETTS AVE ARLINGTON, MA 02476

2729-02 DATE: PROJECT NO. 12-19-22 SCALE: 1" = 10' DWG. NAME: BDJ CHECKED BY: **DESIGNED BY:**



civil engineering • land surveying nvironmental consulting • landscape architecture www.allenmajor.com 100 COMMERCE WAY, SUITE 5 WOBURN MA 01801 TEL: (781) 935-6889

WOBURN, MA ♦ LAKEVILLE, MA ♦ MANCHESTER, N


FAX: (781) 935-2896

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ALLEN & MAJOR ASSOCIATES, INC.'S WORK PRODUCT. **DRAWING TITLE:**

SHEET No. LAYOUT & MATERIALS PLAN | C-102

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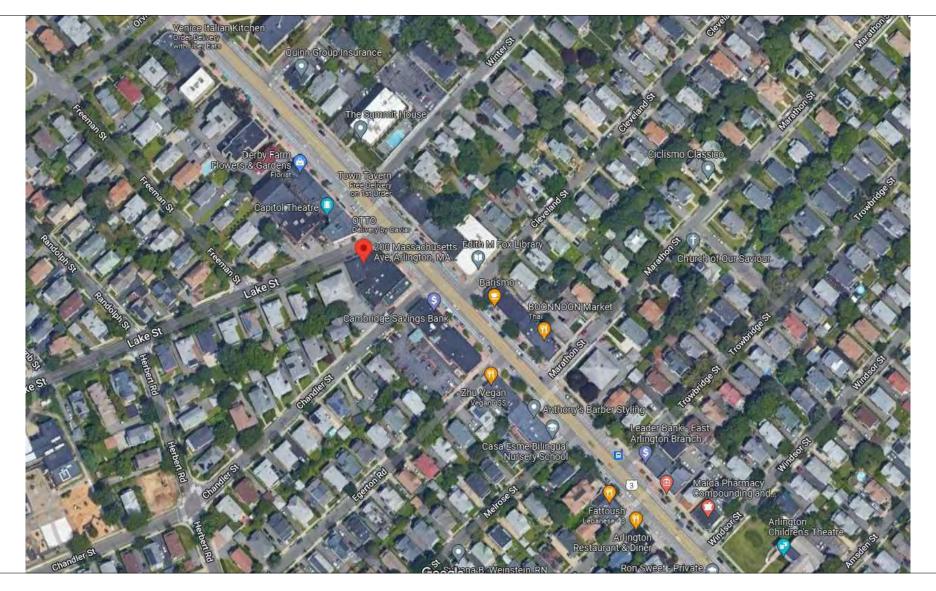


GRAPHIC SCALE

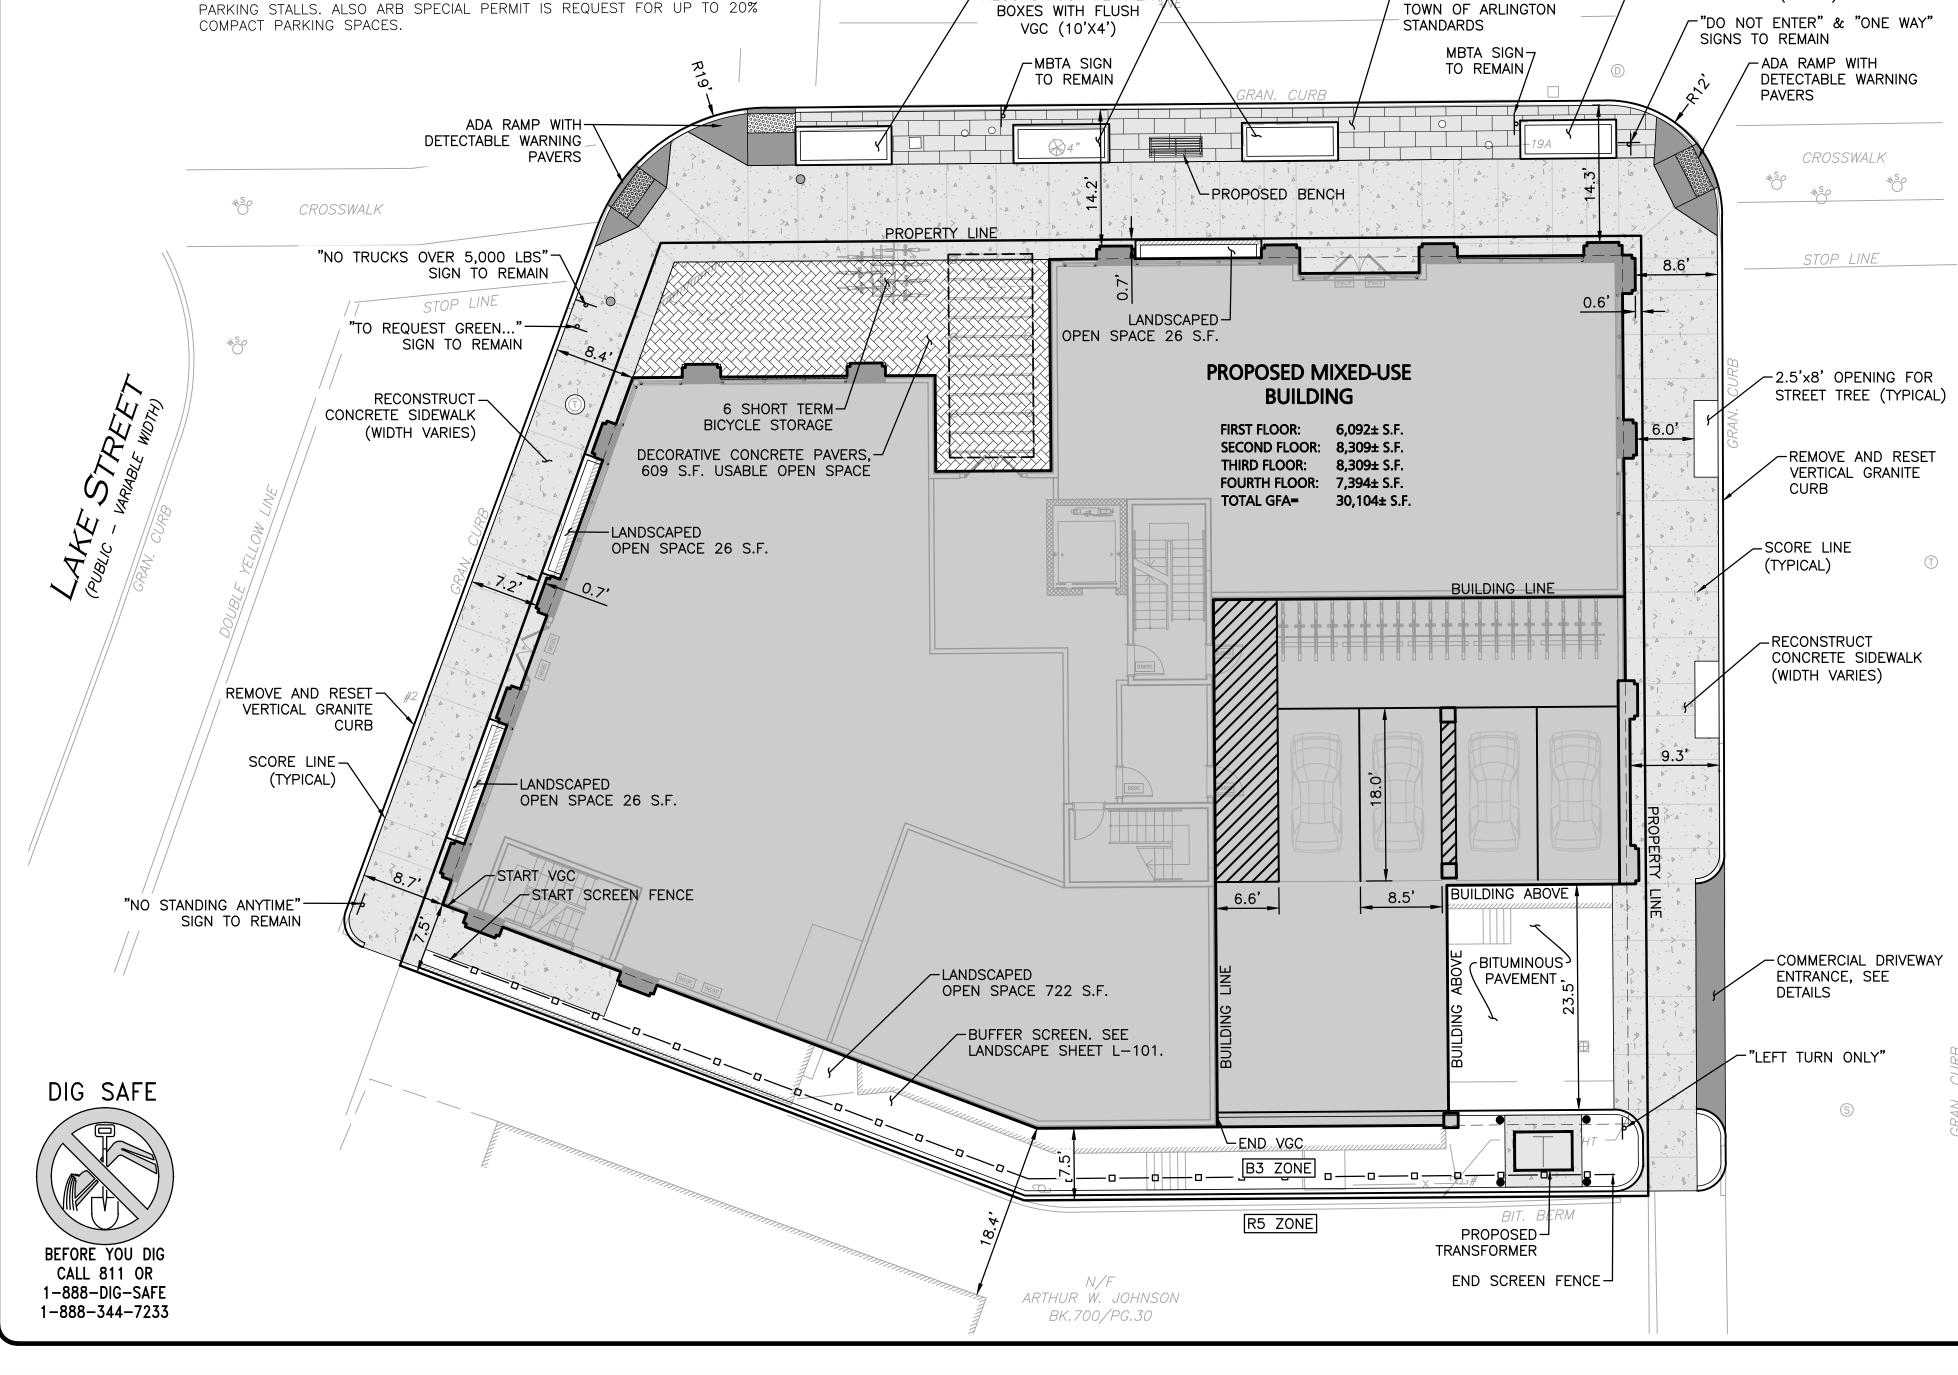
PROPOSED MIXED-USE BUILDING:

190-200 Massachusetts Ave, Arlington, MA





SHEET

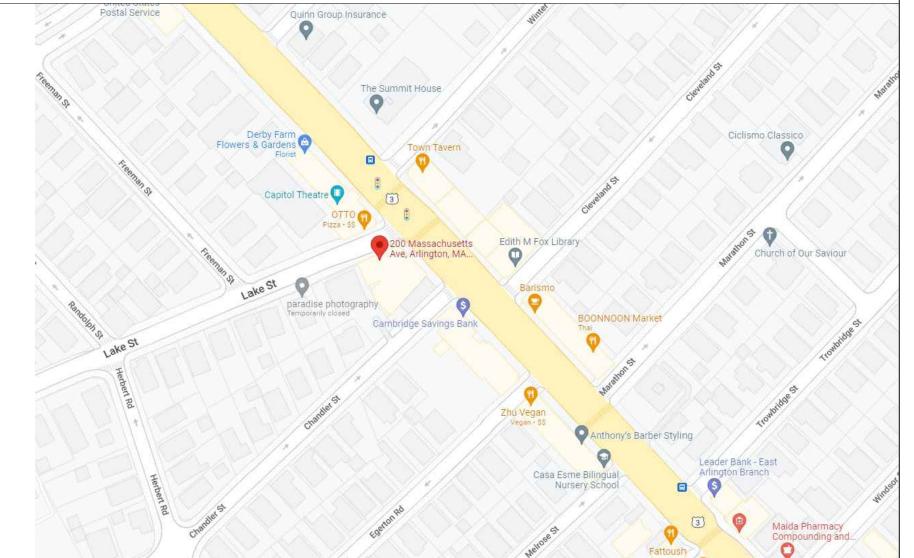

DATE

EXISTING SITUATION AERIAL VIEW

ZONING SUMMARY

ZONE:

MIN. LOT AREA:

MIN. FRONTAGE:

USABLE OPEN SPACE:

MAX. HEIGHT:

MAX. STORIES:

MAX. FAR:

B3 DISTRICT

>20,000 SF.

50'

50'

55 STORIES

EXISTING/ PROPOSED

LOT AREA: 11,134 SF.

FRONTAGE: 102'

PROPOSED OPEN SPACE: 7.8%

PROPOSED HEIGHT: 45'

PROPOSED STORIES: 4 STORIES

PROPOSED FAR: 2.7

PROPOSED GFA: 6092 +8309 +8309 +7394=
30,104 SF.

BUILDING SETBACKS (Section 5-28)

FRONT: MIN. = 0' PROPOSED = .6' SIDE: MIN = 0' PROPOSED = 7'-6" REAR: (H + L) / 6 PROPOSED = N / A

PARKING SPACE DIMENSIONS

OPEN 8'-6'"x18'

COMPACT 8'x16' (20% MAX.)

PARALLEL 8'x22"

AISLE 24'

GRADE LEVEL

RETAIL TENANT A 3,032 SF
RETAIL TENANT B 1,819 SF
TRASH ROOM 108 SF
UTILITIES 425 SF
ELEVATOR LOBBY 312 SF
TOTAL 5,696 SF (NET)

2nd. LEVEL

TOTAL

UTILITIES
RESIDENTIAL UNIT 201 623 SF
RESIDENTIAL UNIT 202 646 SF
AFFORDABLE UNIT 203 417 SF
RESIDENTIAL UNIT 204 692 SF
AFFORDABLE UNIT 205 814 SF
RESIDENTIAL UNIT 206 760 SF
RESIDENTIAL UNIT 207 777 SF
RESIDENTIAL UNIT 208 592 SF
RESIDENTIAL UNIT 209 558 SF
RESIDENTIAL UNIT 210 741 SF

3rd. LEVEL (NET)

UTILITIES
RESIDENTIAL UNIT 301 623 SF
RESIDENTIAL UNIT 302 646 SF
RESIDENTIAL UNIT 303 417 SF
AFFORDABLE UNIT 304 692 SF
RESIDENTIAL UNIT 305 814 SF
RESIDENTIAL UNIT 306 760 SF
AFFORDABLE UNIT 307 777 SF
RESIDENTIAL UNIT 308 592 SF
RESIDENTIAL UNIT 309 558 SF
RESIDENTIAL UNIT 309 558 SF
RESIDENTIAL UNIT 310 741 SF
TOTAL 6,749 SF (NET)

6,749 SF (NET)

4TH. LEVEL

UTILITIES

RESIDENTIAL UNIT 401

RESIDENTIAL UNIT 402

RESIDENTIAL UNIT 403

RESIDENTIAL UNIT 404

RESIDENTIAL UNIT 404

RESIDENTIAL UNIT 405

RESIDENTIAL UNIT 405

RESIDENTIAL UNIT 406

RESIDENTIAL UNIT 407

AFFORDABLE UNIT 408

RESIDENTIAL UNIT 409

466 SF

RESIDENTIAL UNIT 410 603 SF TOTAL 5,954 SF (NET)

TOTAL 32 UNITS:

2 RETAIL TENANT SPACES
30 RESIDENTIAL UNITS

ROOF AREA = 6290 SF. (NET)
AREA DEDICATED TO SOLAR ARRAY = 3168 SF. (NET)


ARCHITECT:

DAVID BARSKY - ARCHITECT 320 Nevada Street, Newton, MA 02460 MAX. 617.448.5872

CIVIL P.E.:

Allen & Major Associates 100 Commerce Way, Woburn, MA 01801

SHEET	SHEET IIILE	DATE
A-000	COVER SHEET	02.20.2023
	ARCHITECTURAL	<u>.</u>
A-001	GENERAL NOTES	
A-010	BUILDING AND ZONING STUDY	02.20.2023
A-011	BUILDING AND ZONING STUDY	02.20.2023
A-020	CODE SUMMARY ESCAPE LENGTH PLANS	
A-100	PARKING LEVEL/BASEMENT PLAN	02.20.2023
A-101	1-ST LEVEL FLOOR PLAN	02.20.2023
A-102	2-ND LEVEL FLOOR PLAN	02.20.2023
A-103	3-RD LEVEL FLOOR PLAN	02.20.2023
A-104	4TH LEVEL FLOOR PLAN	02.20.2023
A-105	ROOF PLAN	02.20.2023
A-110	ENLARGED UNIT PLANS	02.20.2023
A-111	ENLARGED UNIT PLANS	02.20.2023
A-112	ENLARGED UNIT PLANS	02.20.2023
A-300	ELEVATIONS	02.20.2023
A-300	ELEVATIONS	02.20.2023
A-400	PARTIAL SECTION	02.20.2023
A-600	MAILBOX TYPES	
A-610	KITCHEN PLANS - INTERIOR ELEVATIONS	
A-620	KITCHEN PLANS - INTERIOR ELEVATIONS	
A-630	BATHROOM PLANS - INTERIOR ELEVATIONS	
A-810	PARTITION TYPES	
A-811	PARTITION TYPES	
A-812	PARTITION TYPES	
A-900	WINDOW AND DOOR SCHEDULE	
A-901	WINDOW AND DOOR SCHEDULE	
AV	ARCHITECTURAL VISUALIZATION	02.20.2023
AV 2	ARCHITECTURAL VISUALIZATION	02.20.2023

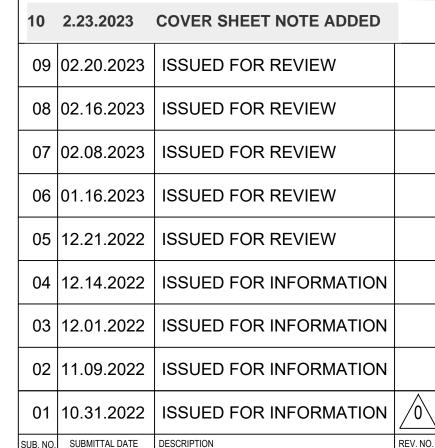

ARCHITECT'S SEAL:





CLIENT INFORMATION

SUMMIT REAL ESTATE STRATEGIES LLC.

PROJECT LOCATION


190-200 Massachusetts Ave Arlington, MA 02474


DRAWING TITLE

COVER SHEET

JUCALL	DAIL
1/8"=1'-0"	October 2022
PROJECT NO.	REVISION NO.
DRAWN BY	DRAWING NO.
VERIFIED BY	A-000

BUILDING PROGRAM

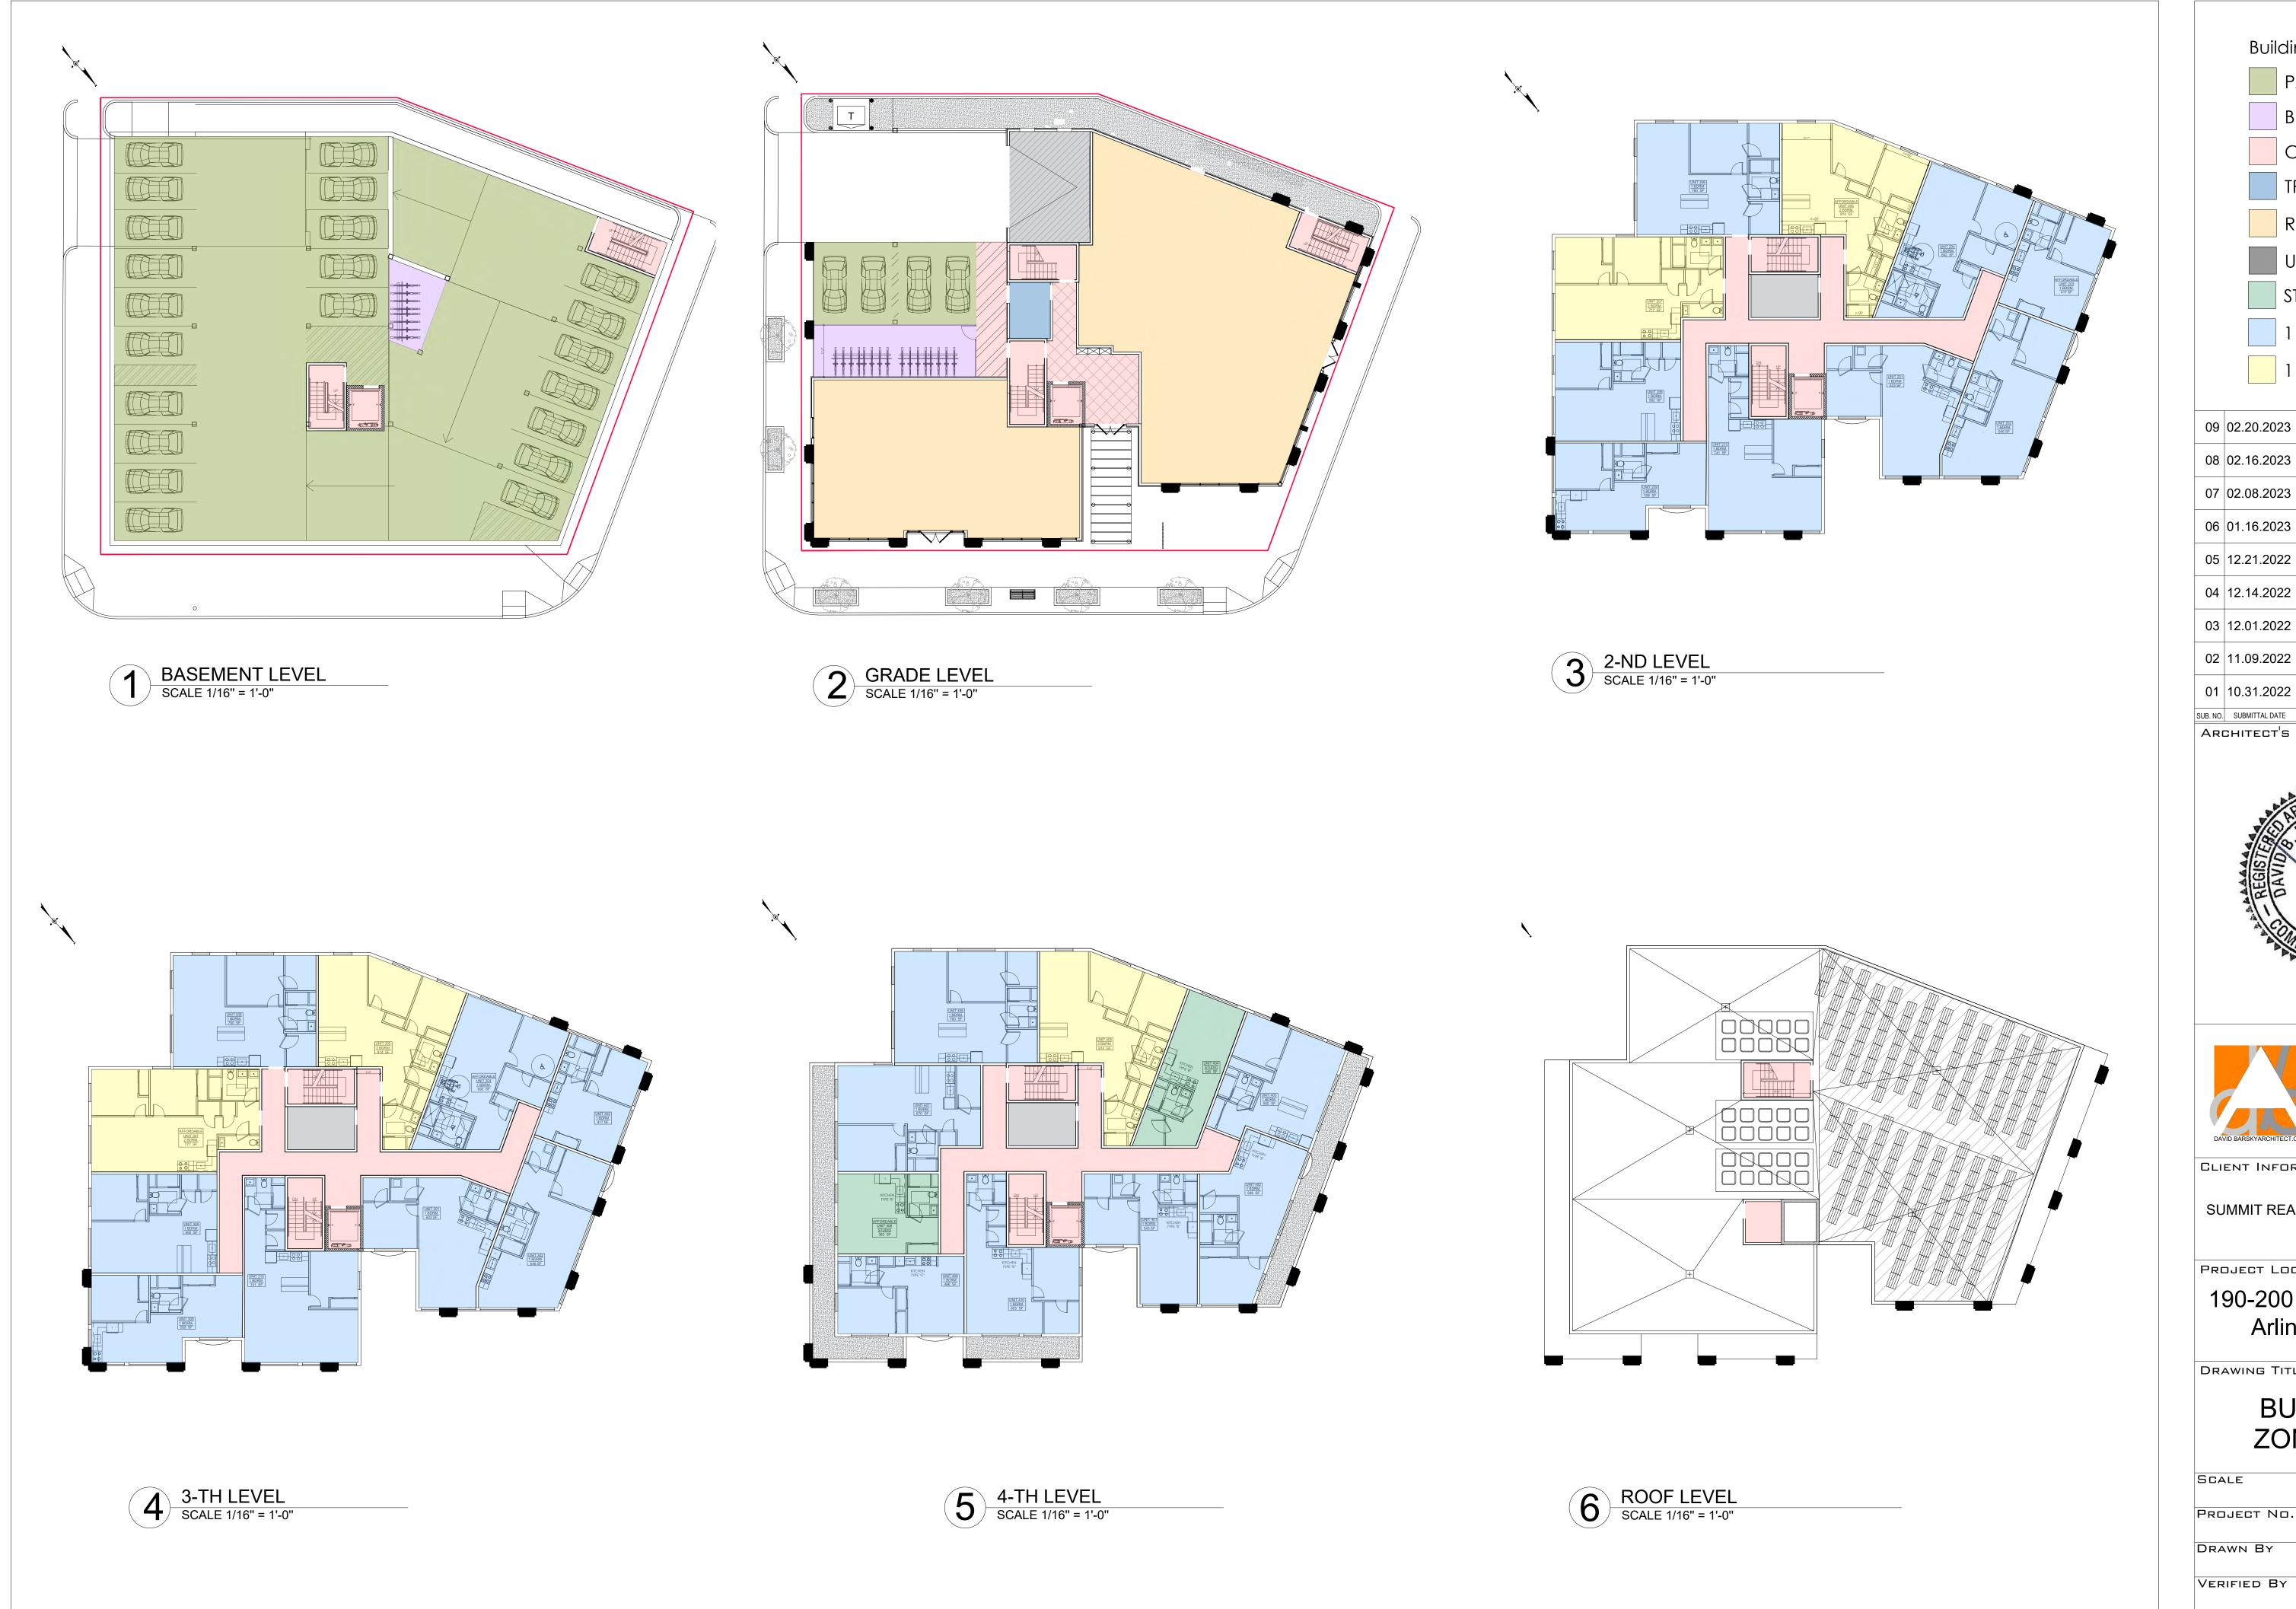

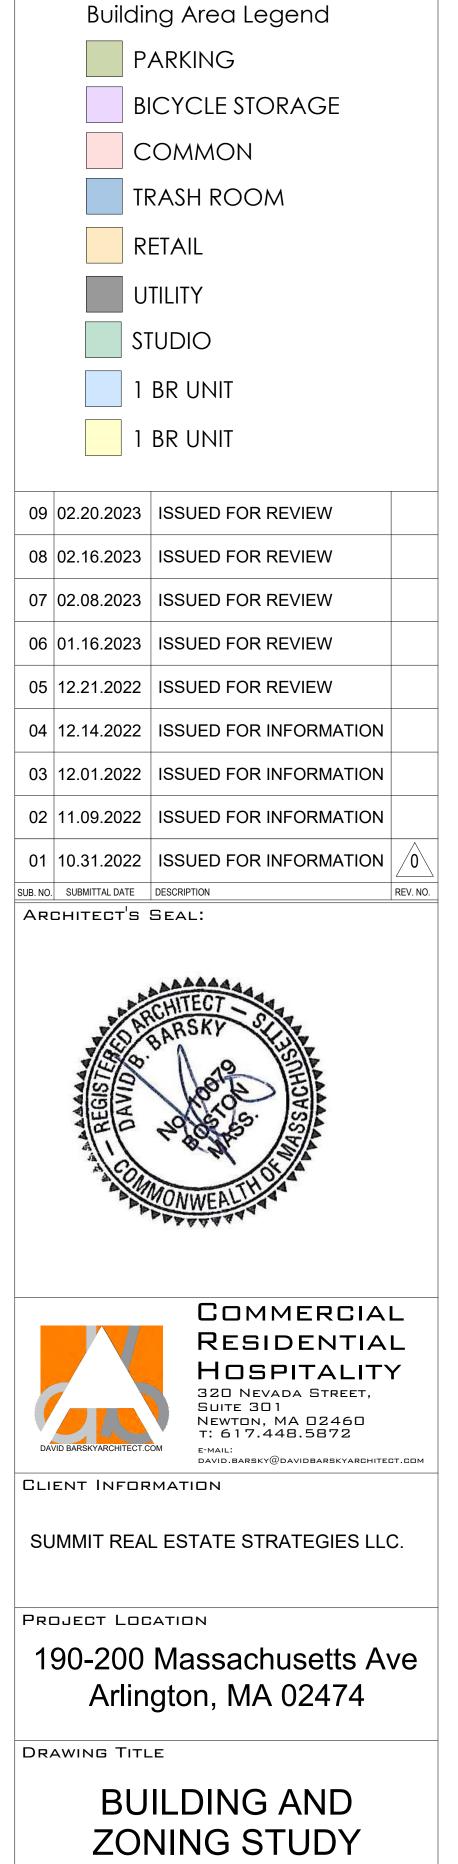


October 2022

A-010


REVISION No.

DRAWING No.

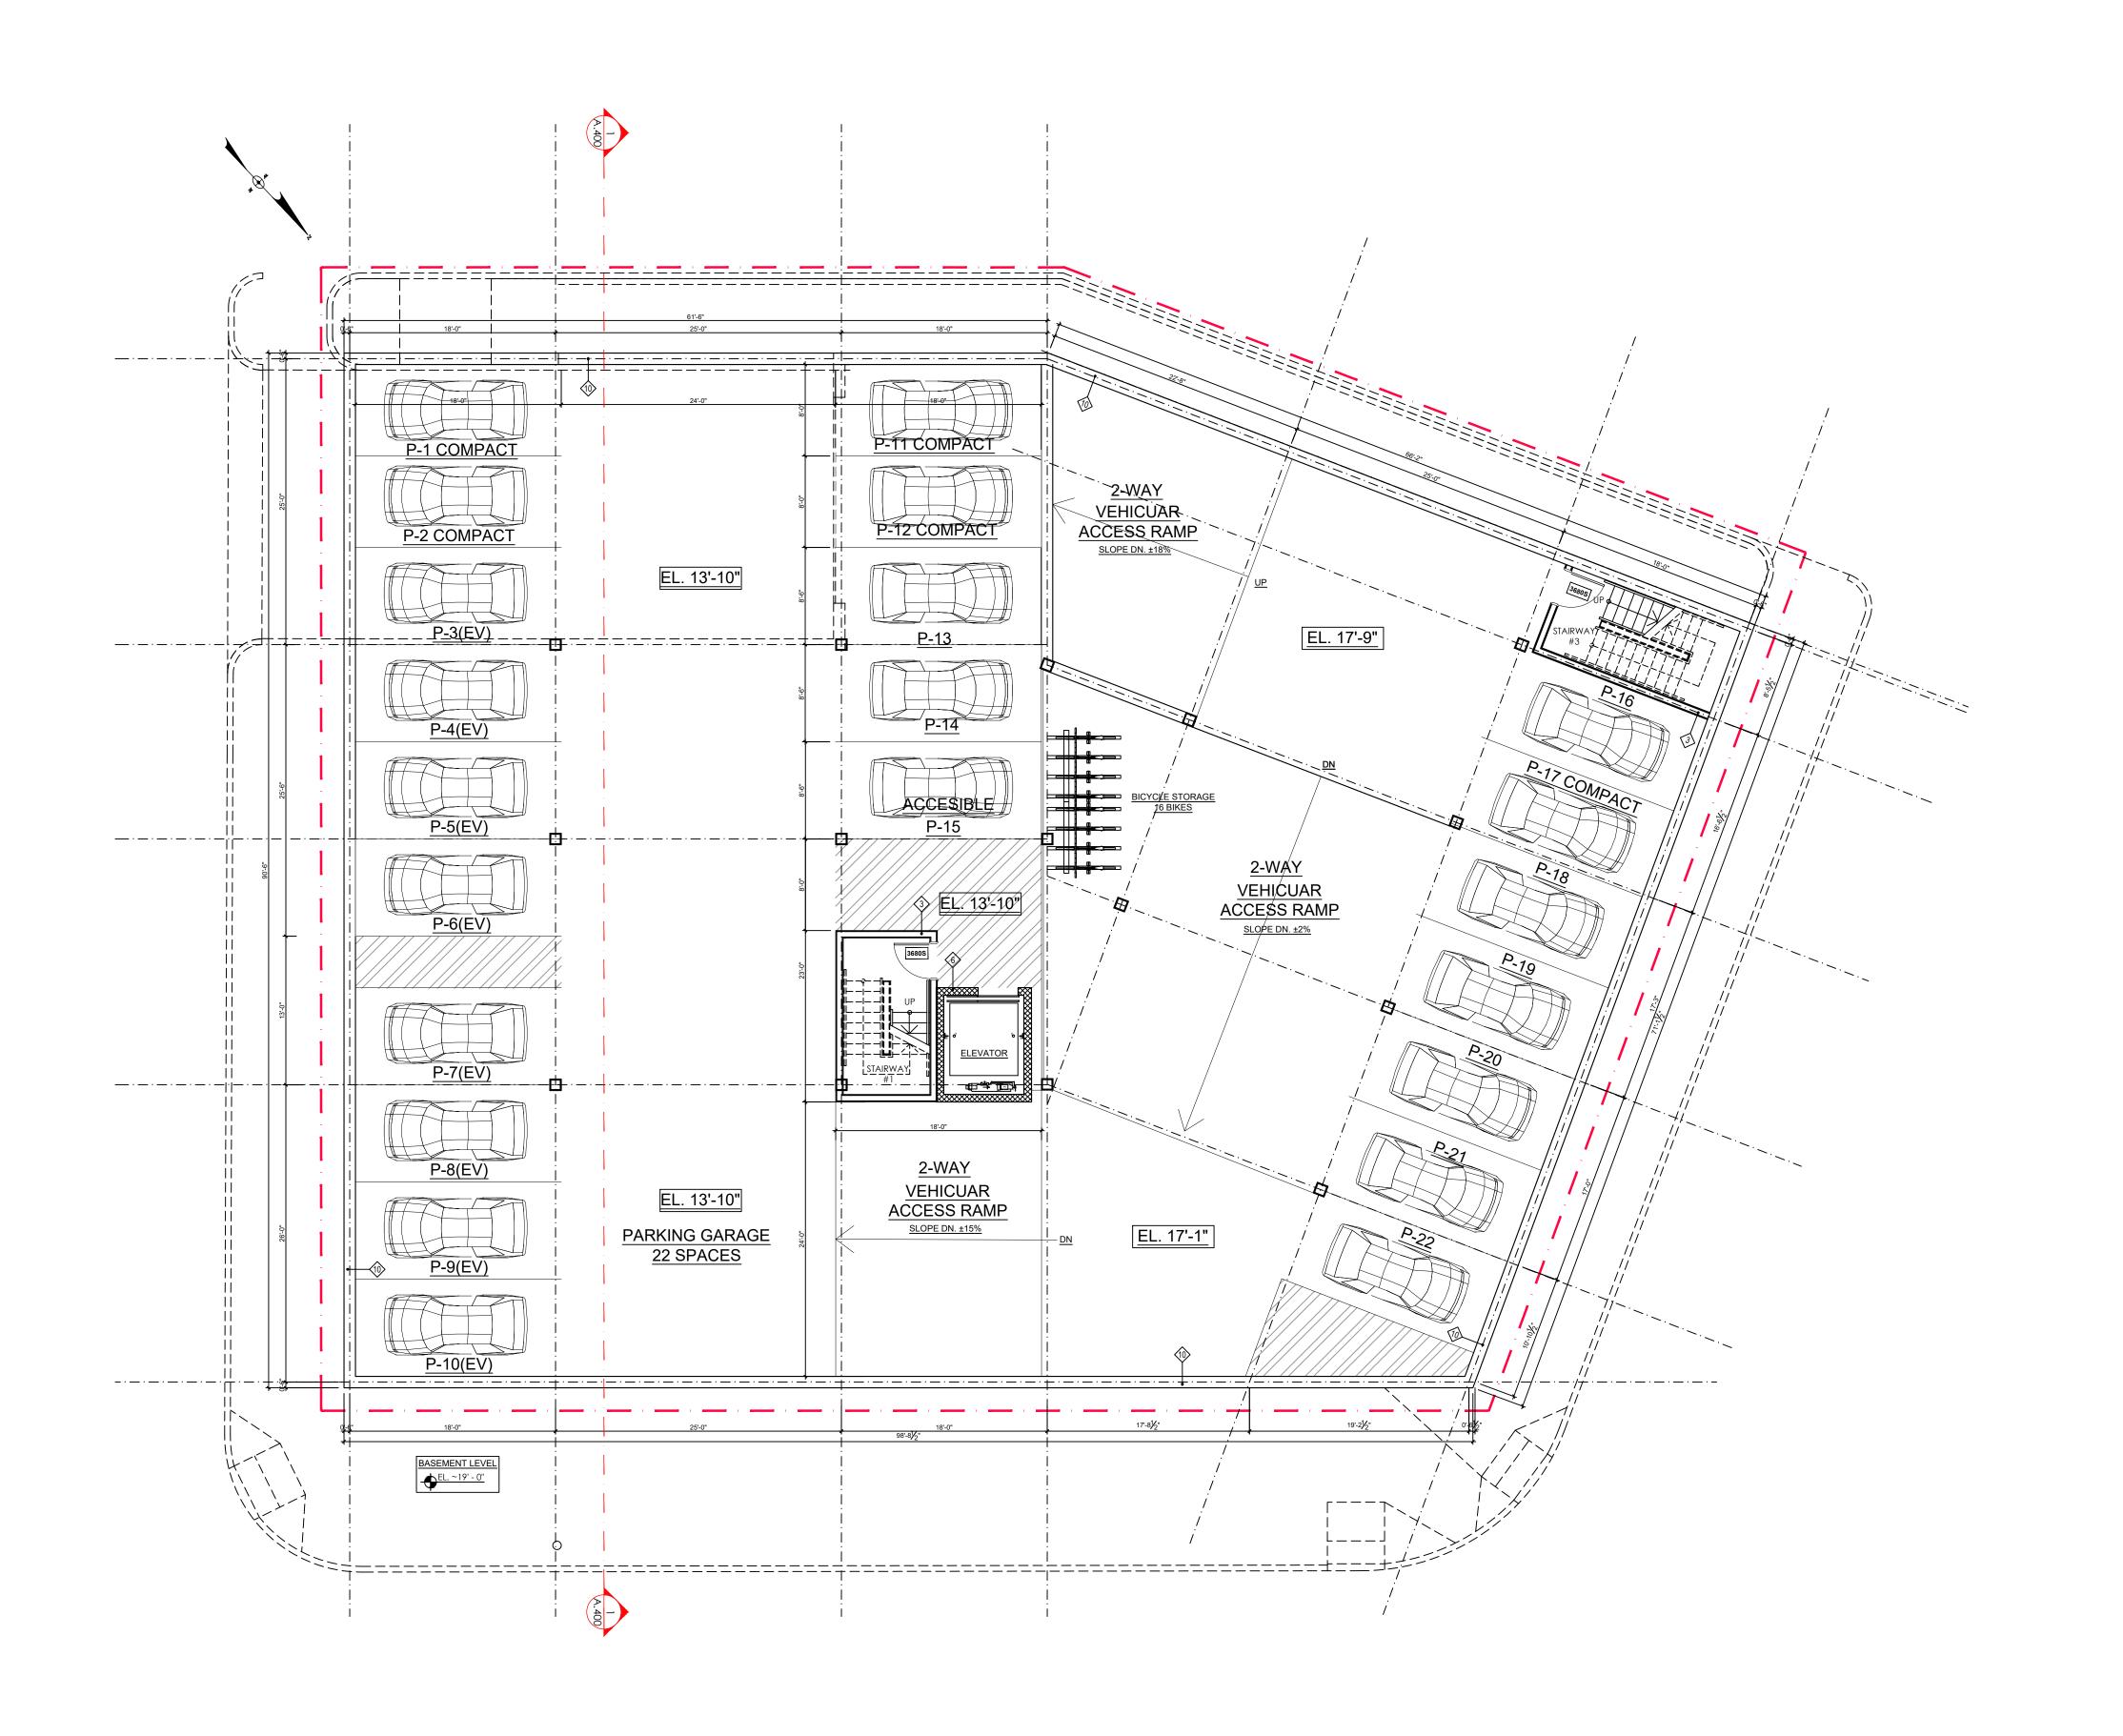

09	02.20.2023	ISSUED FOR REVIEW	
80	02.16.2023	ISSUED FOR REVIEW	
07	02.08.2023	ISSUED FOR REVIEW	
06	01.16.2023	ISSUED FOR REVIEW	
05	12.21.2022	ISSUED FOR REVIEW	
04	12.14.2022	ISSUED FOR INFORMATION	
03	12.01.2022	ISSUED FOR INFORMATION	
02	11.09.2022	ISSUED FOR INFORMATION	
01	10.31.2022	ISSUED FOR INFORMATION	<u></u>
SUB. NO.	SUBMITTAL DATE	DESCRIPTION	REV. NO.

ARCHITECT[']S SEAL:

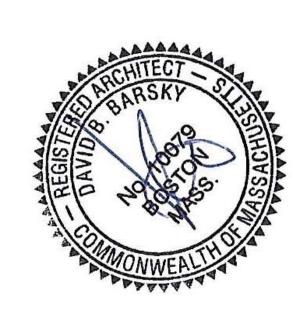



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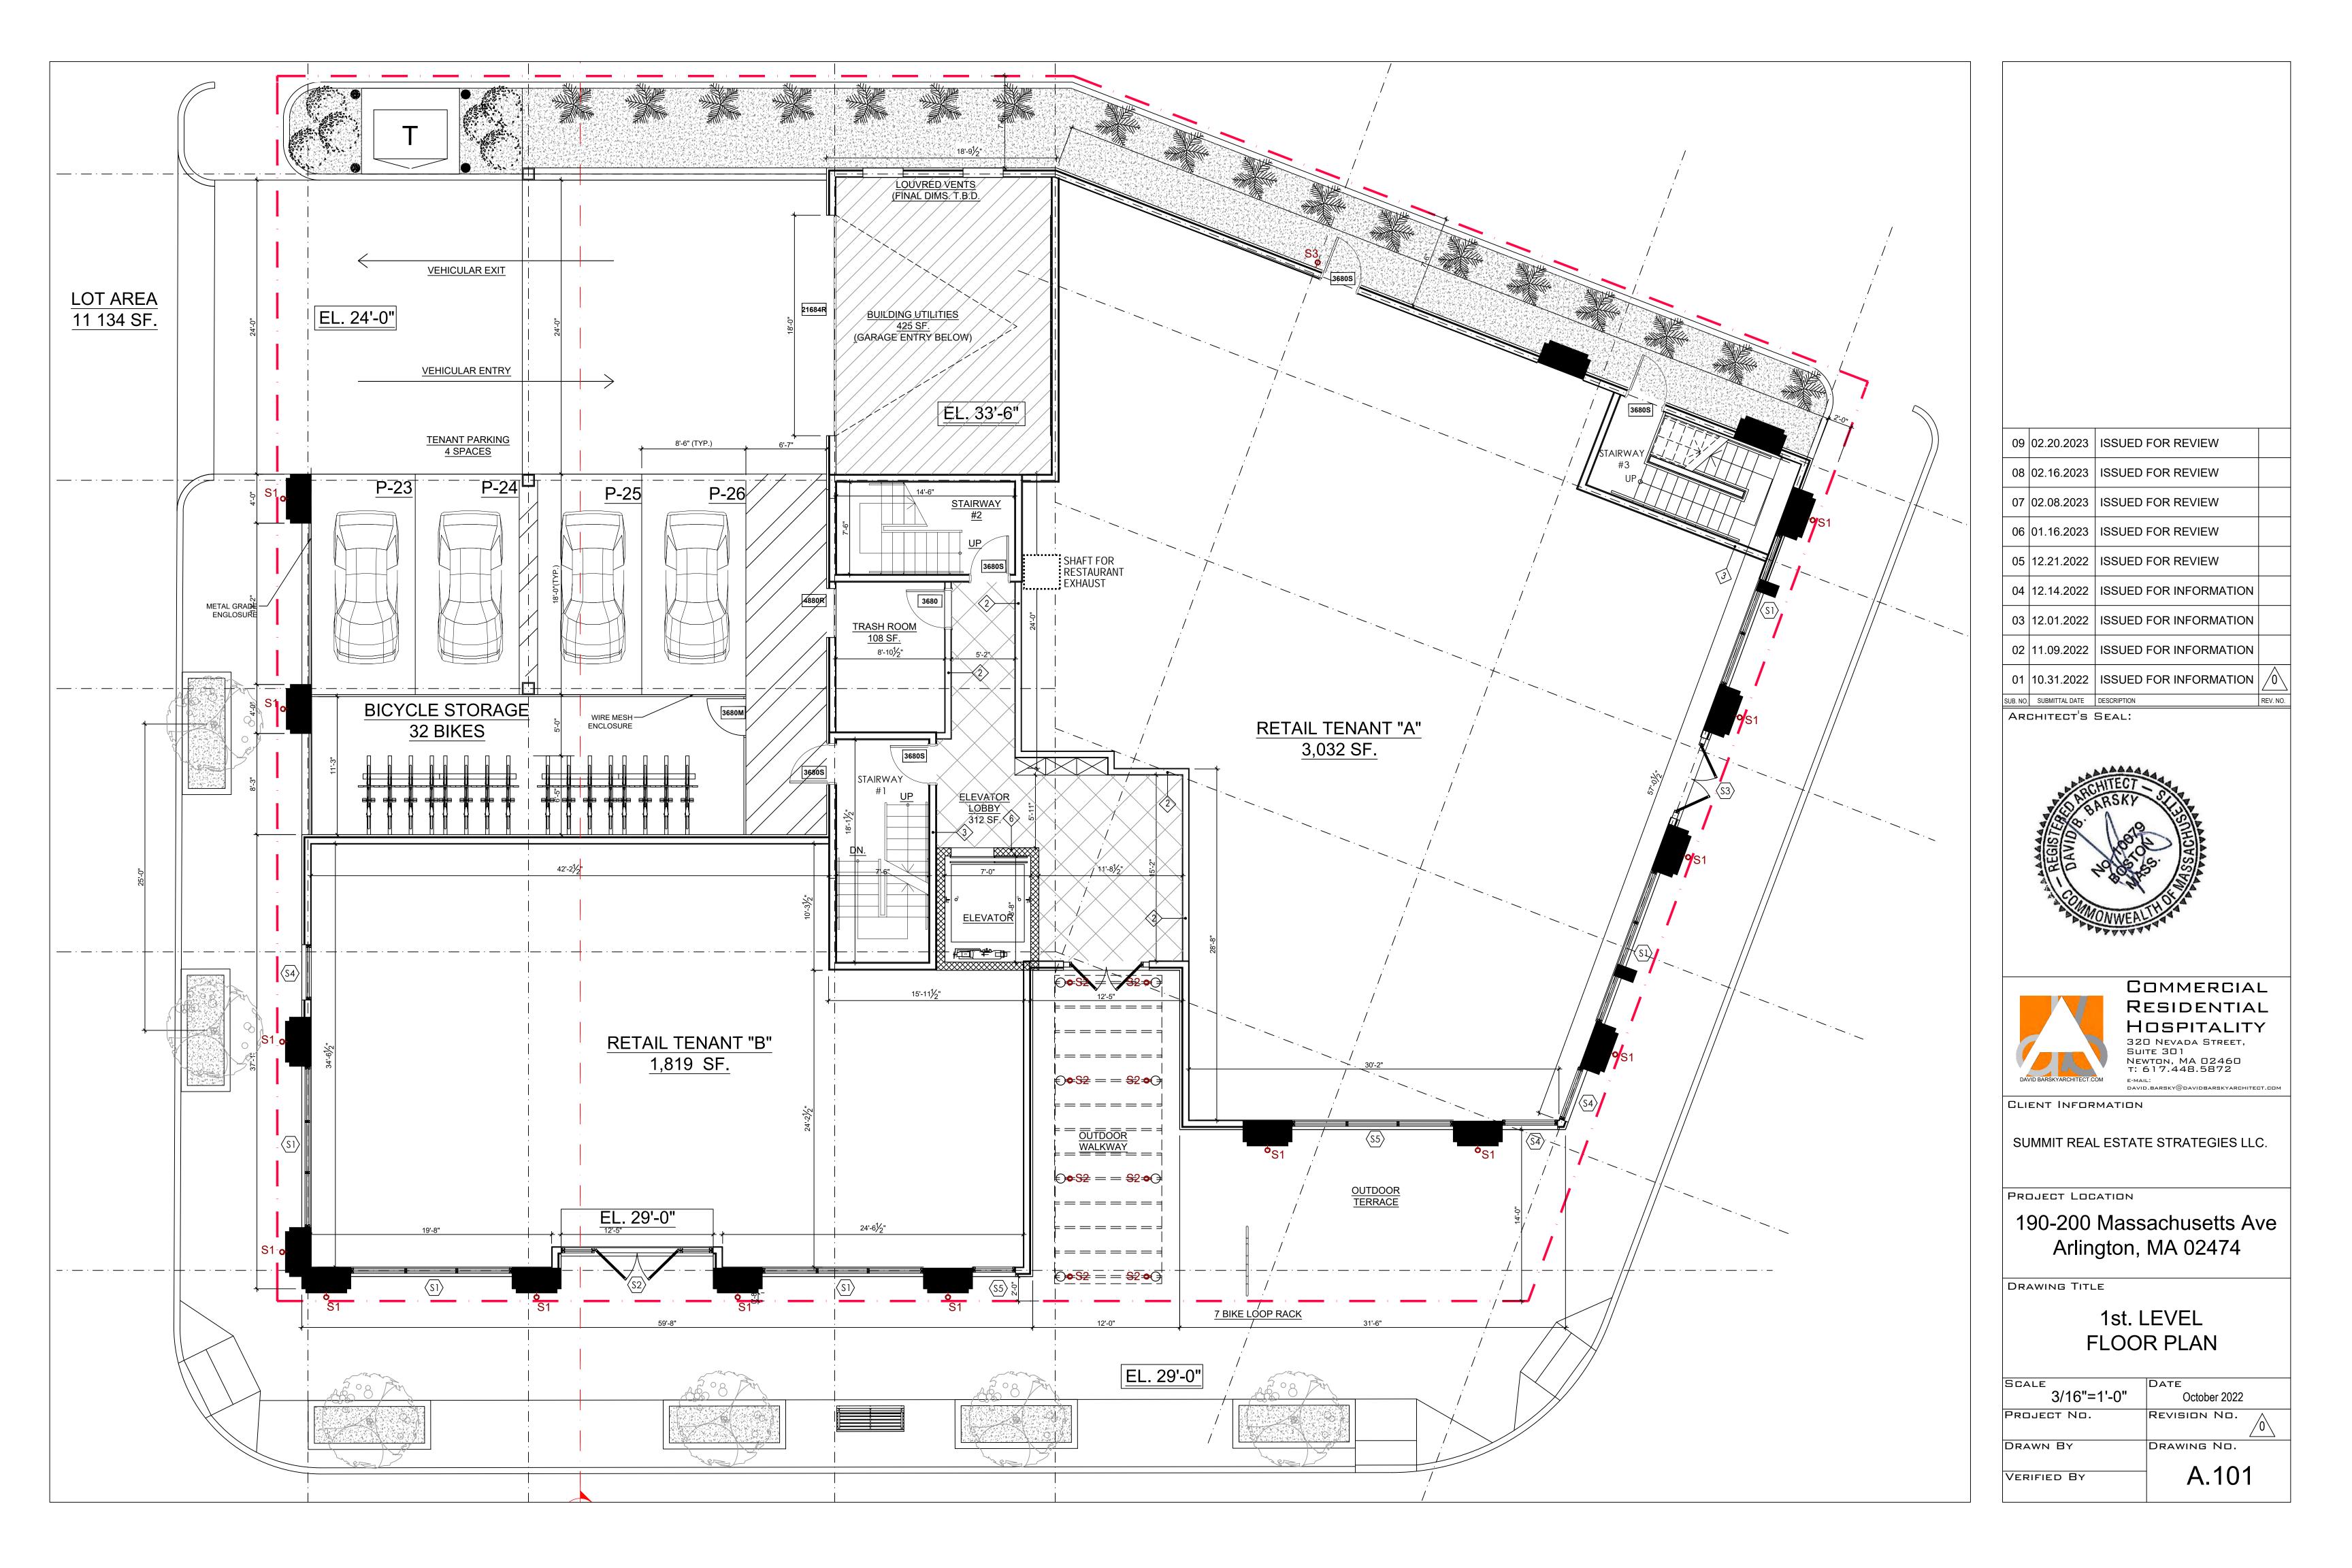
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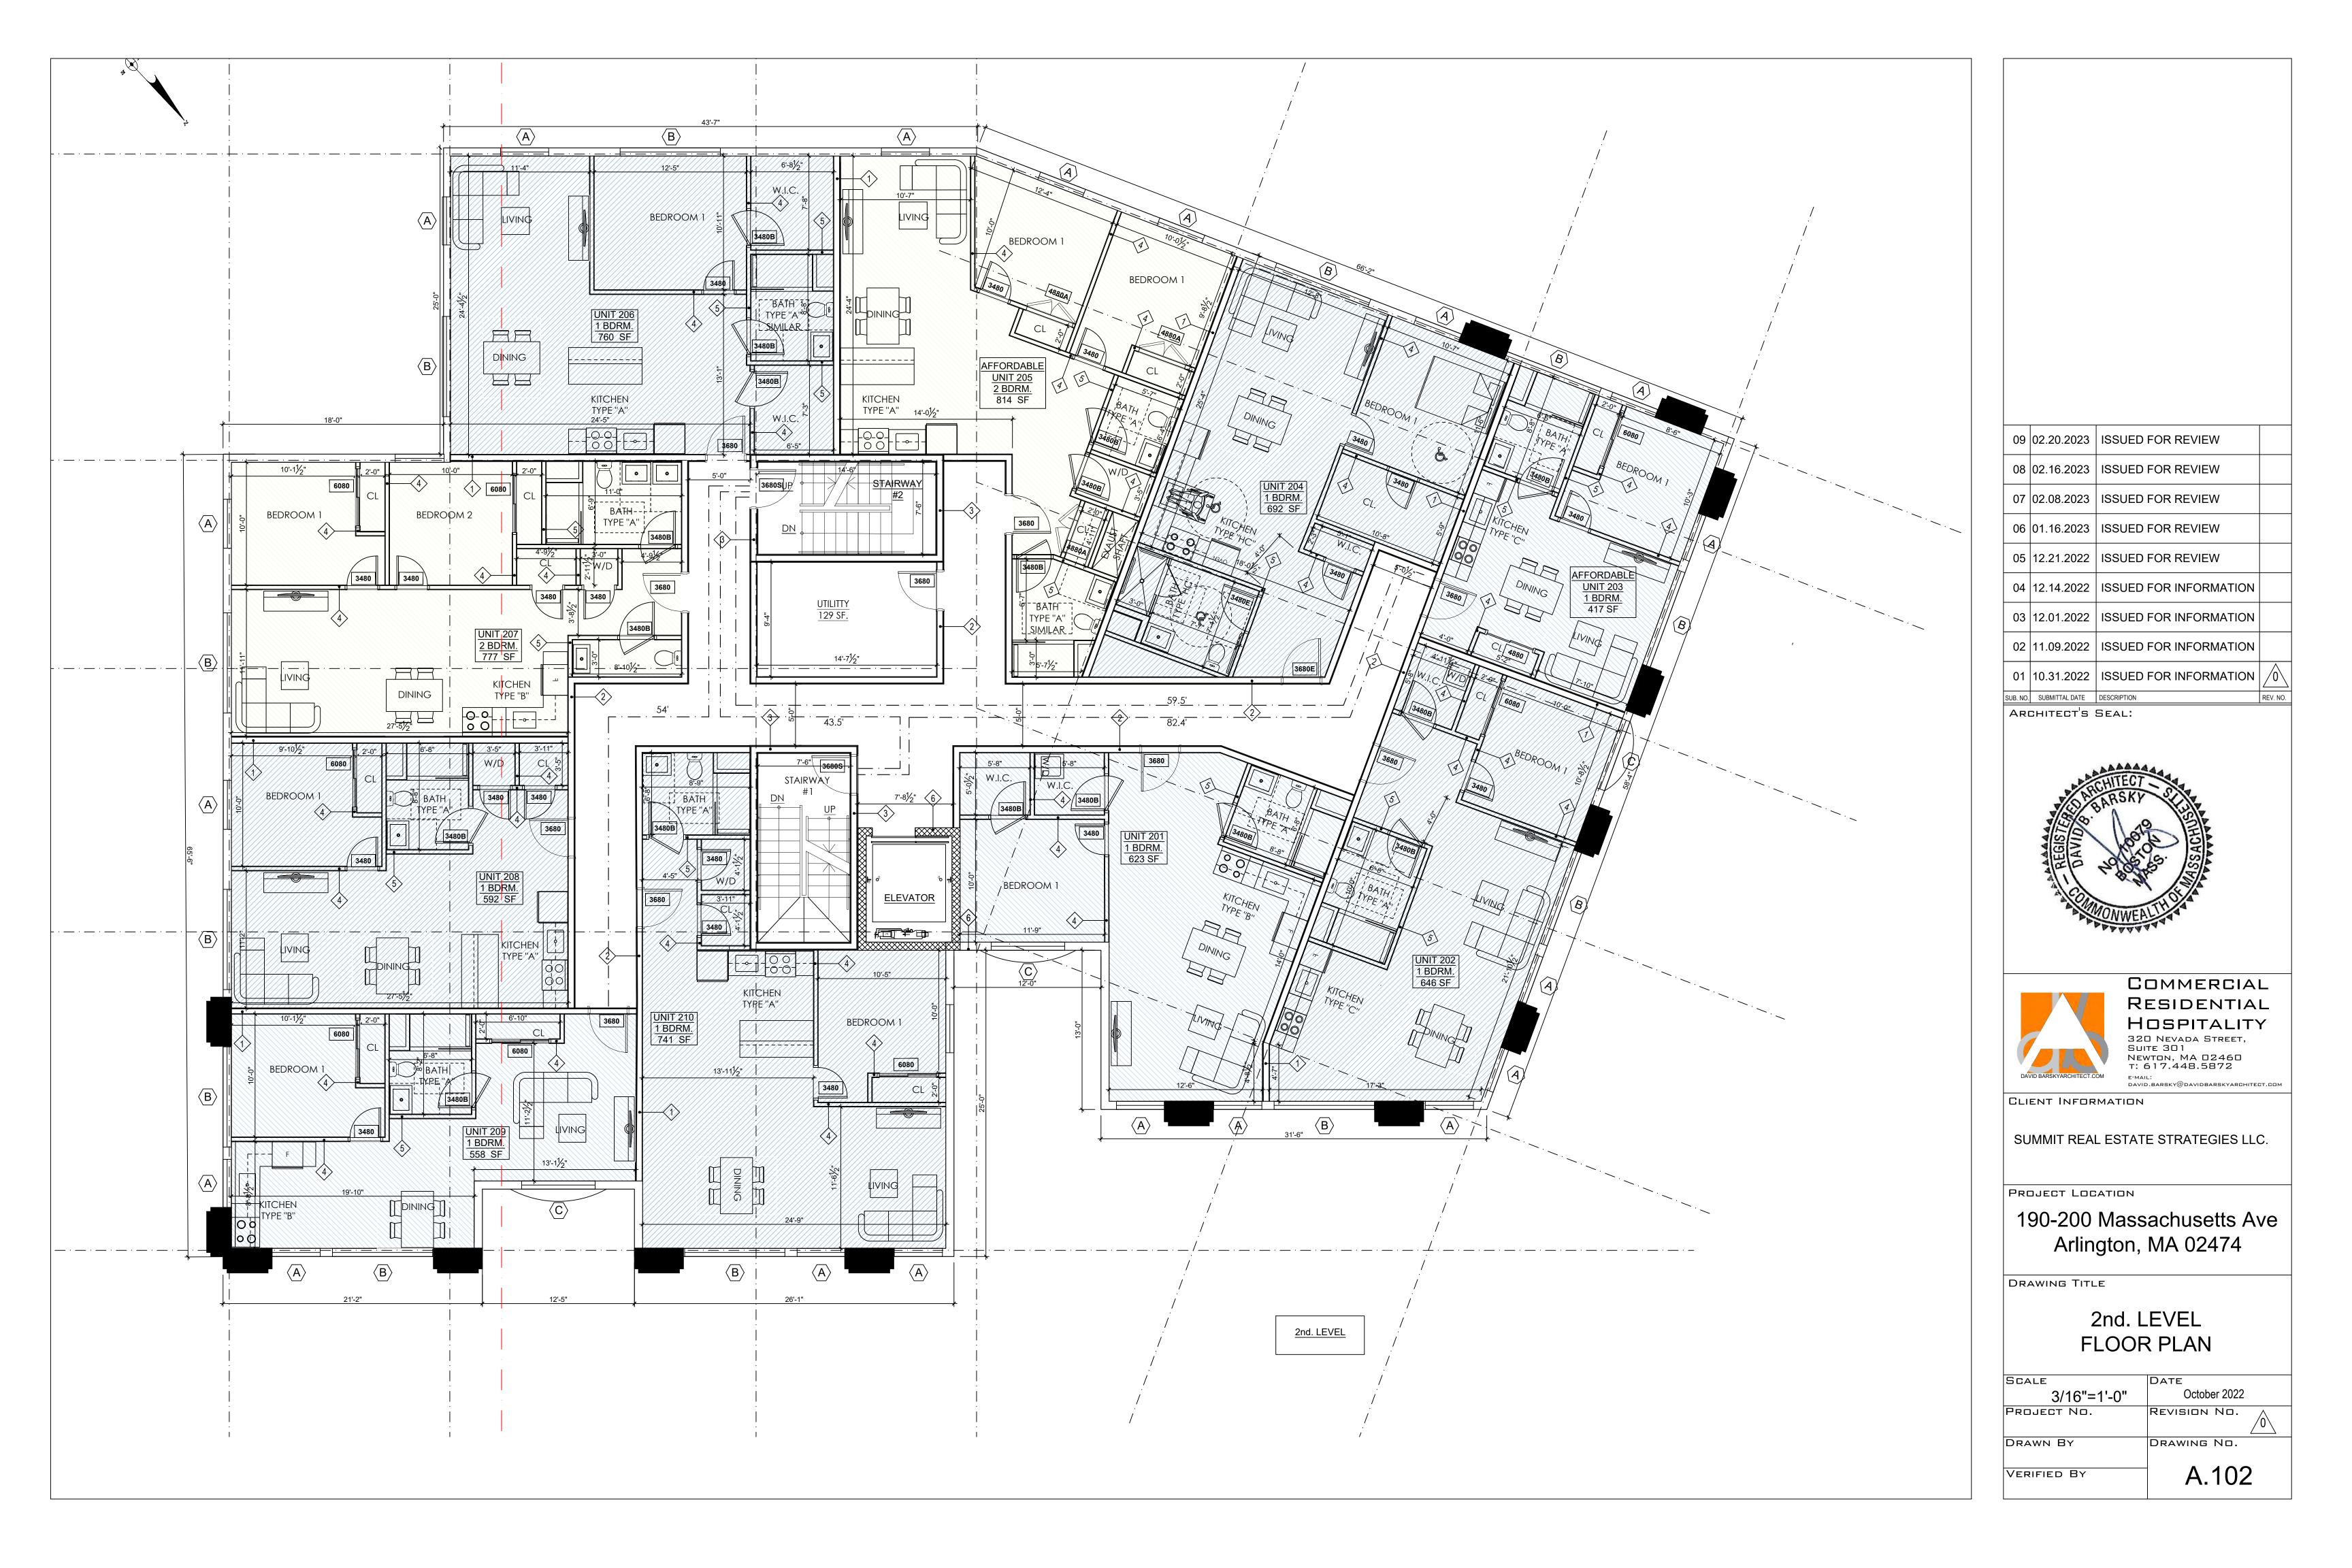
190-200 Massachusetts Ave Arlington, MA 02474


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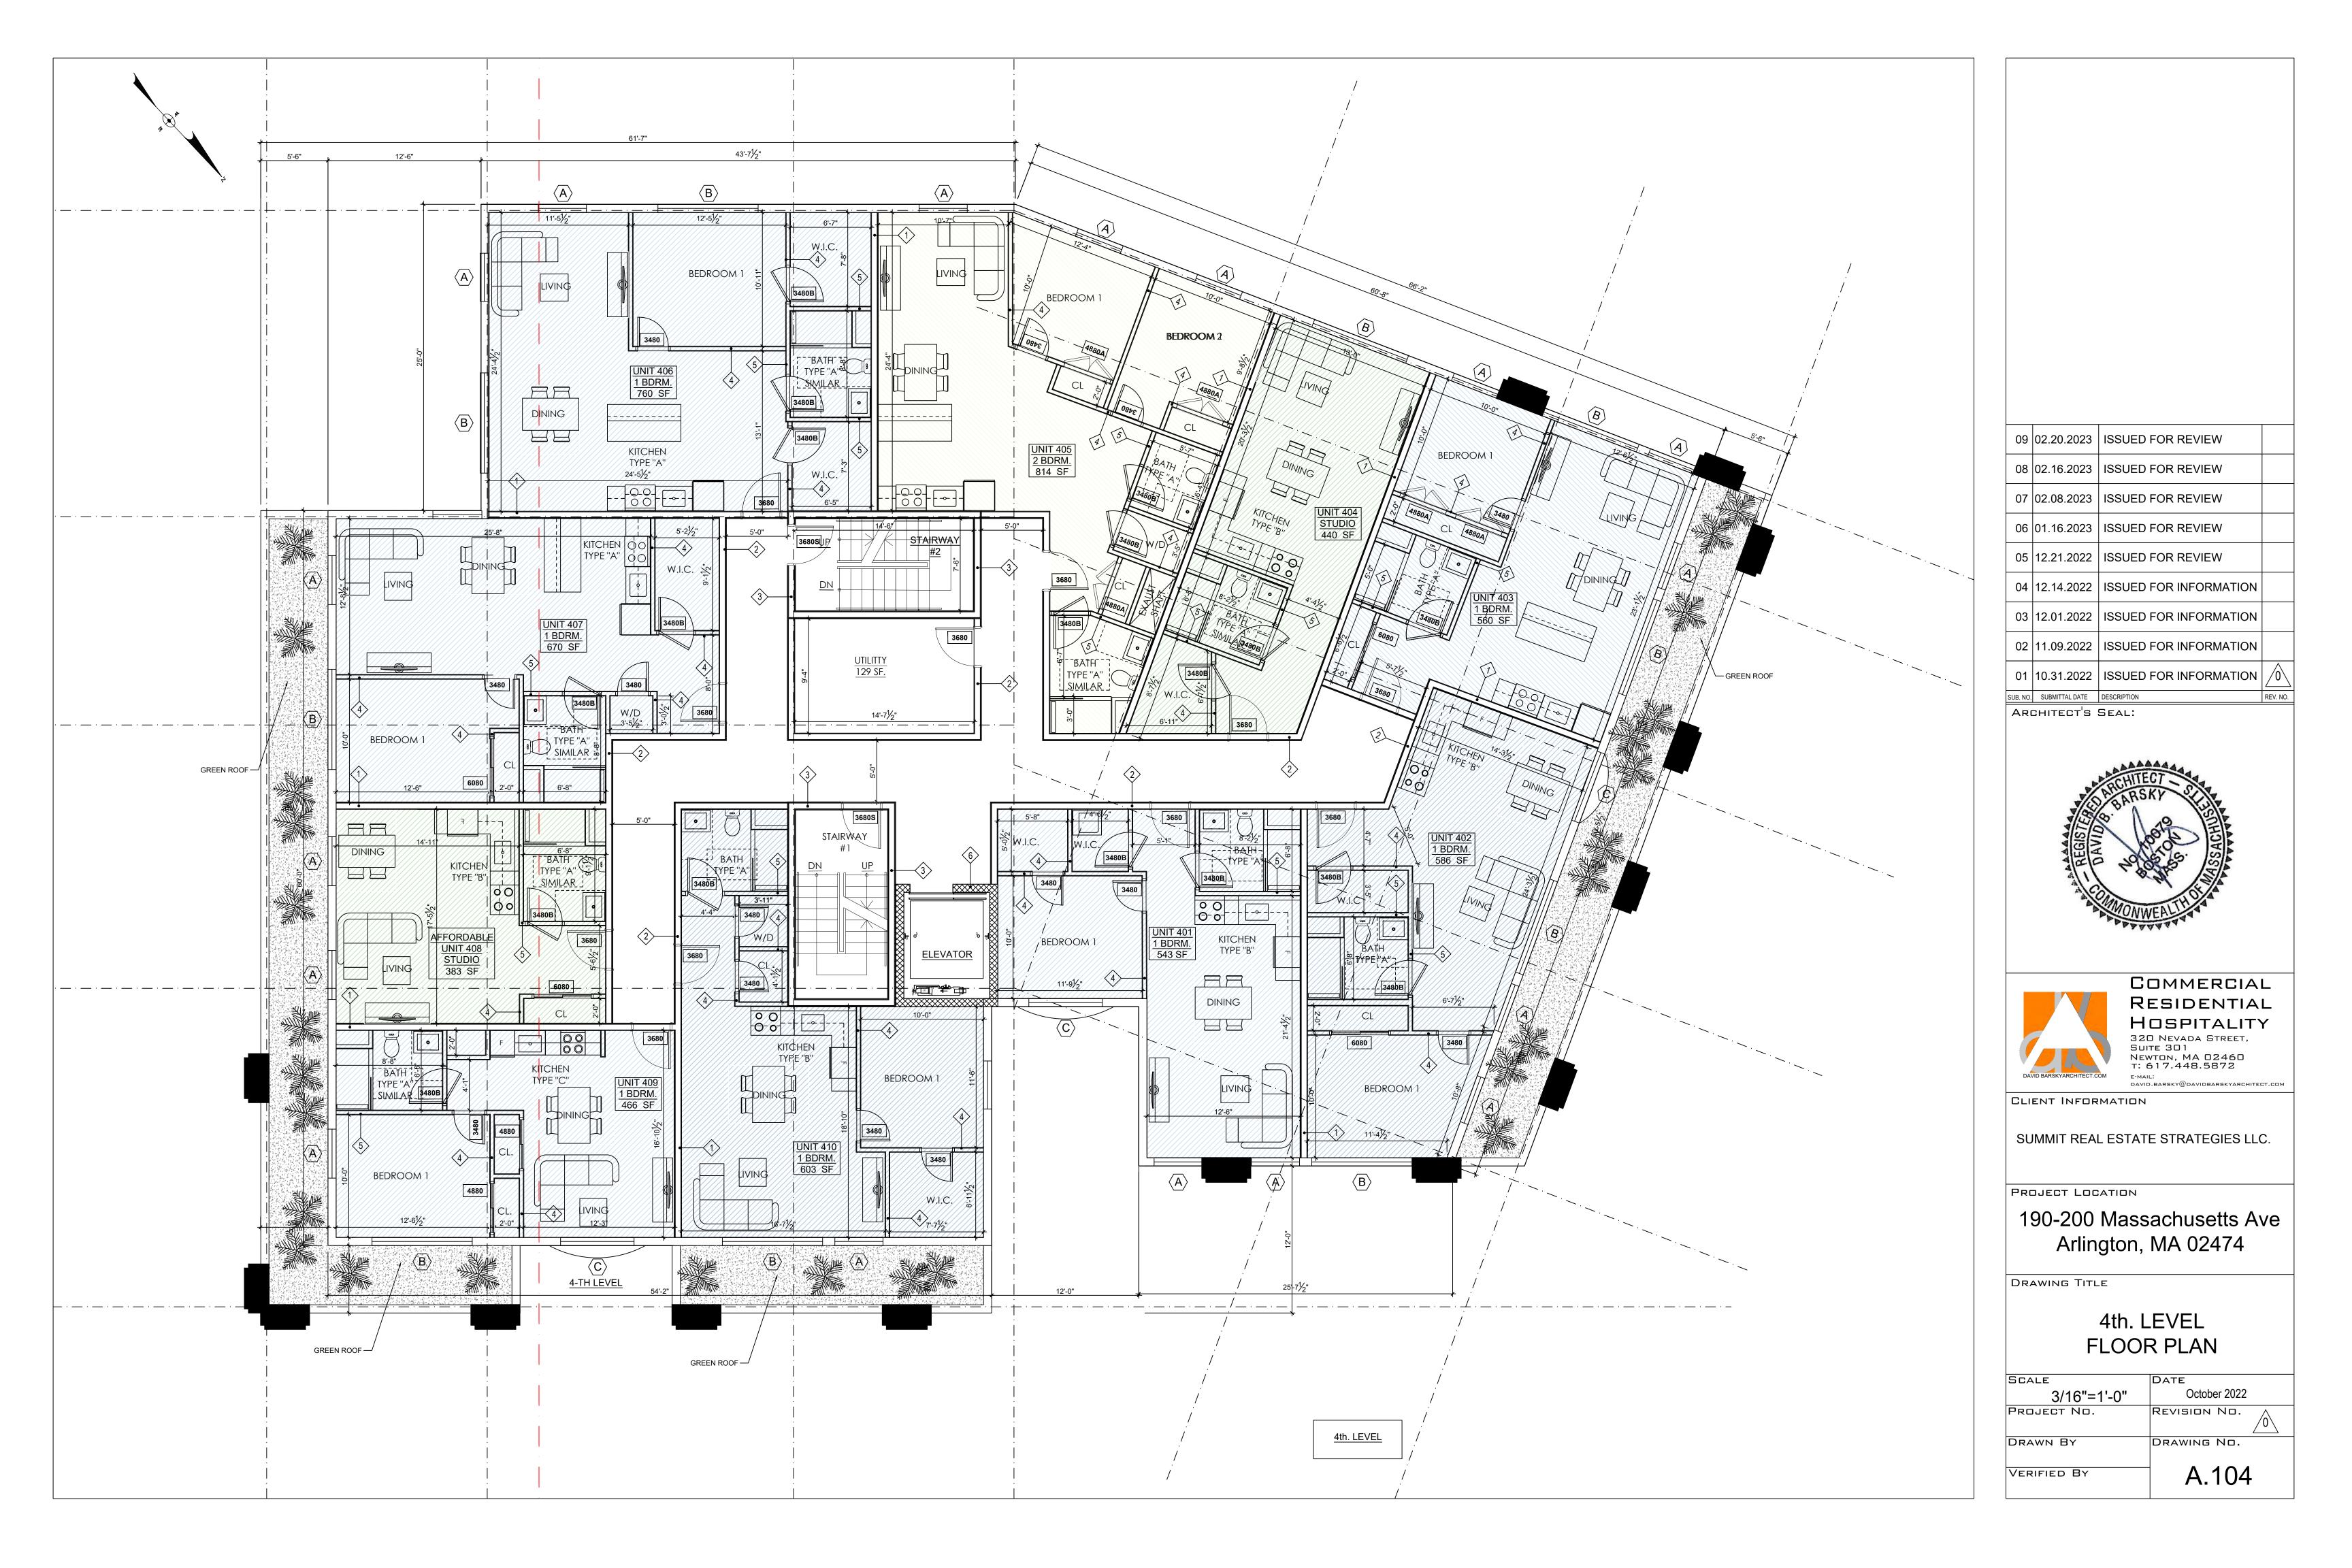
PARKING/ BASEMENT LEVEL


SCALE 1	/8"=1'-0"	October 2022	2
PROJECT	· No.	REVISION NO.	<u></u>
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VERIFIED	BY	\uparrow A. 100	








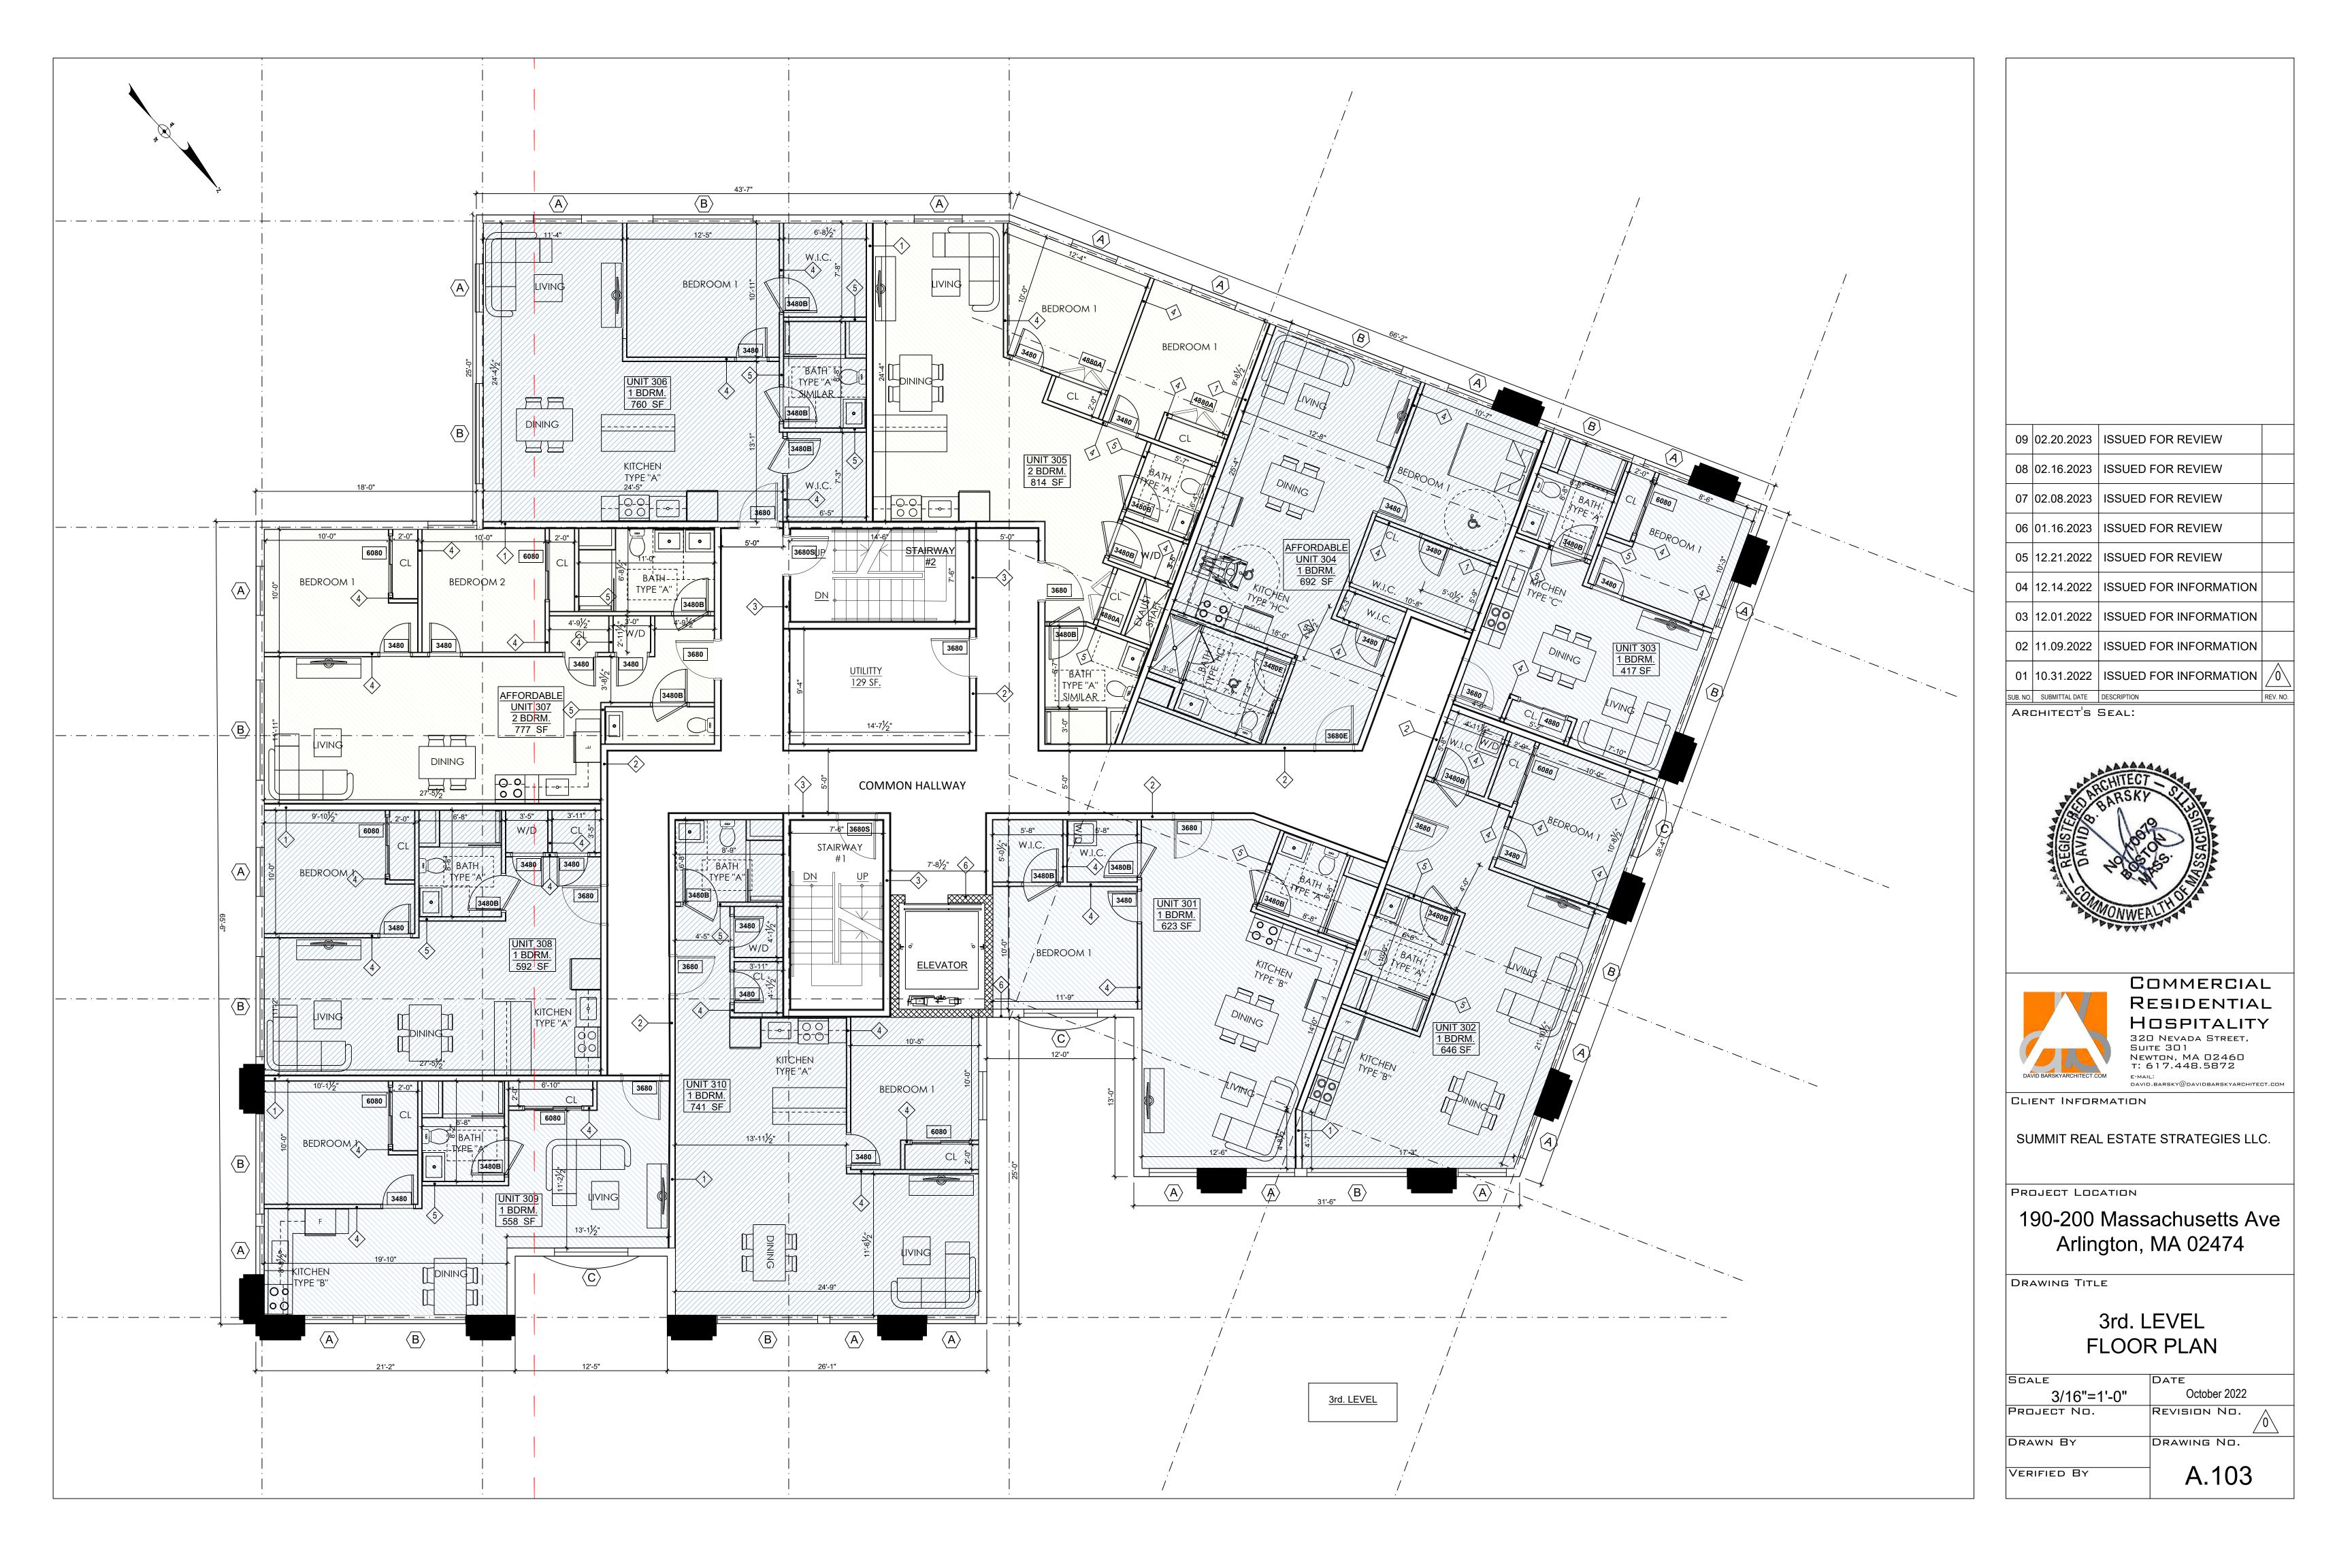

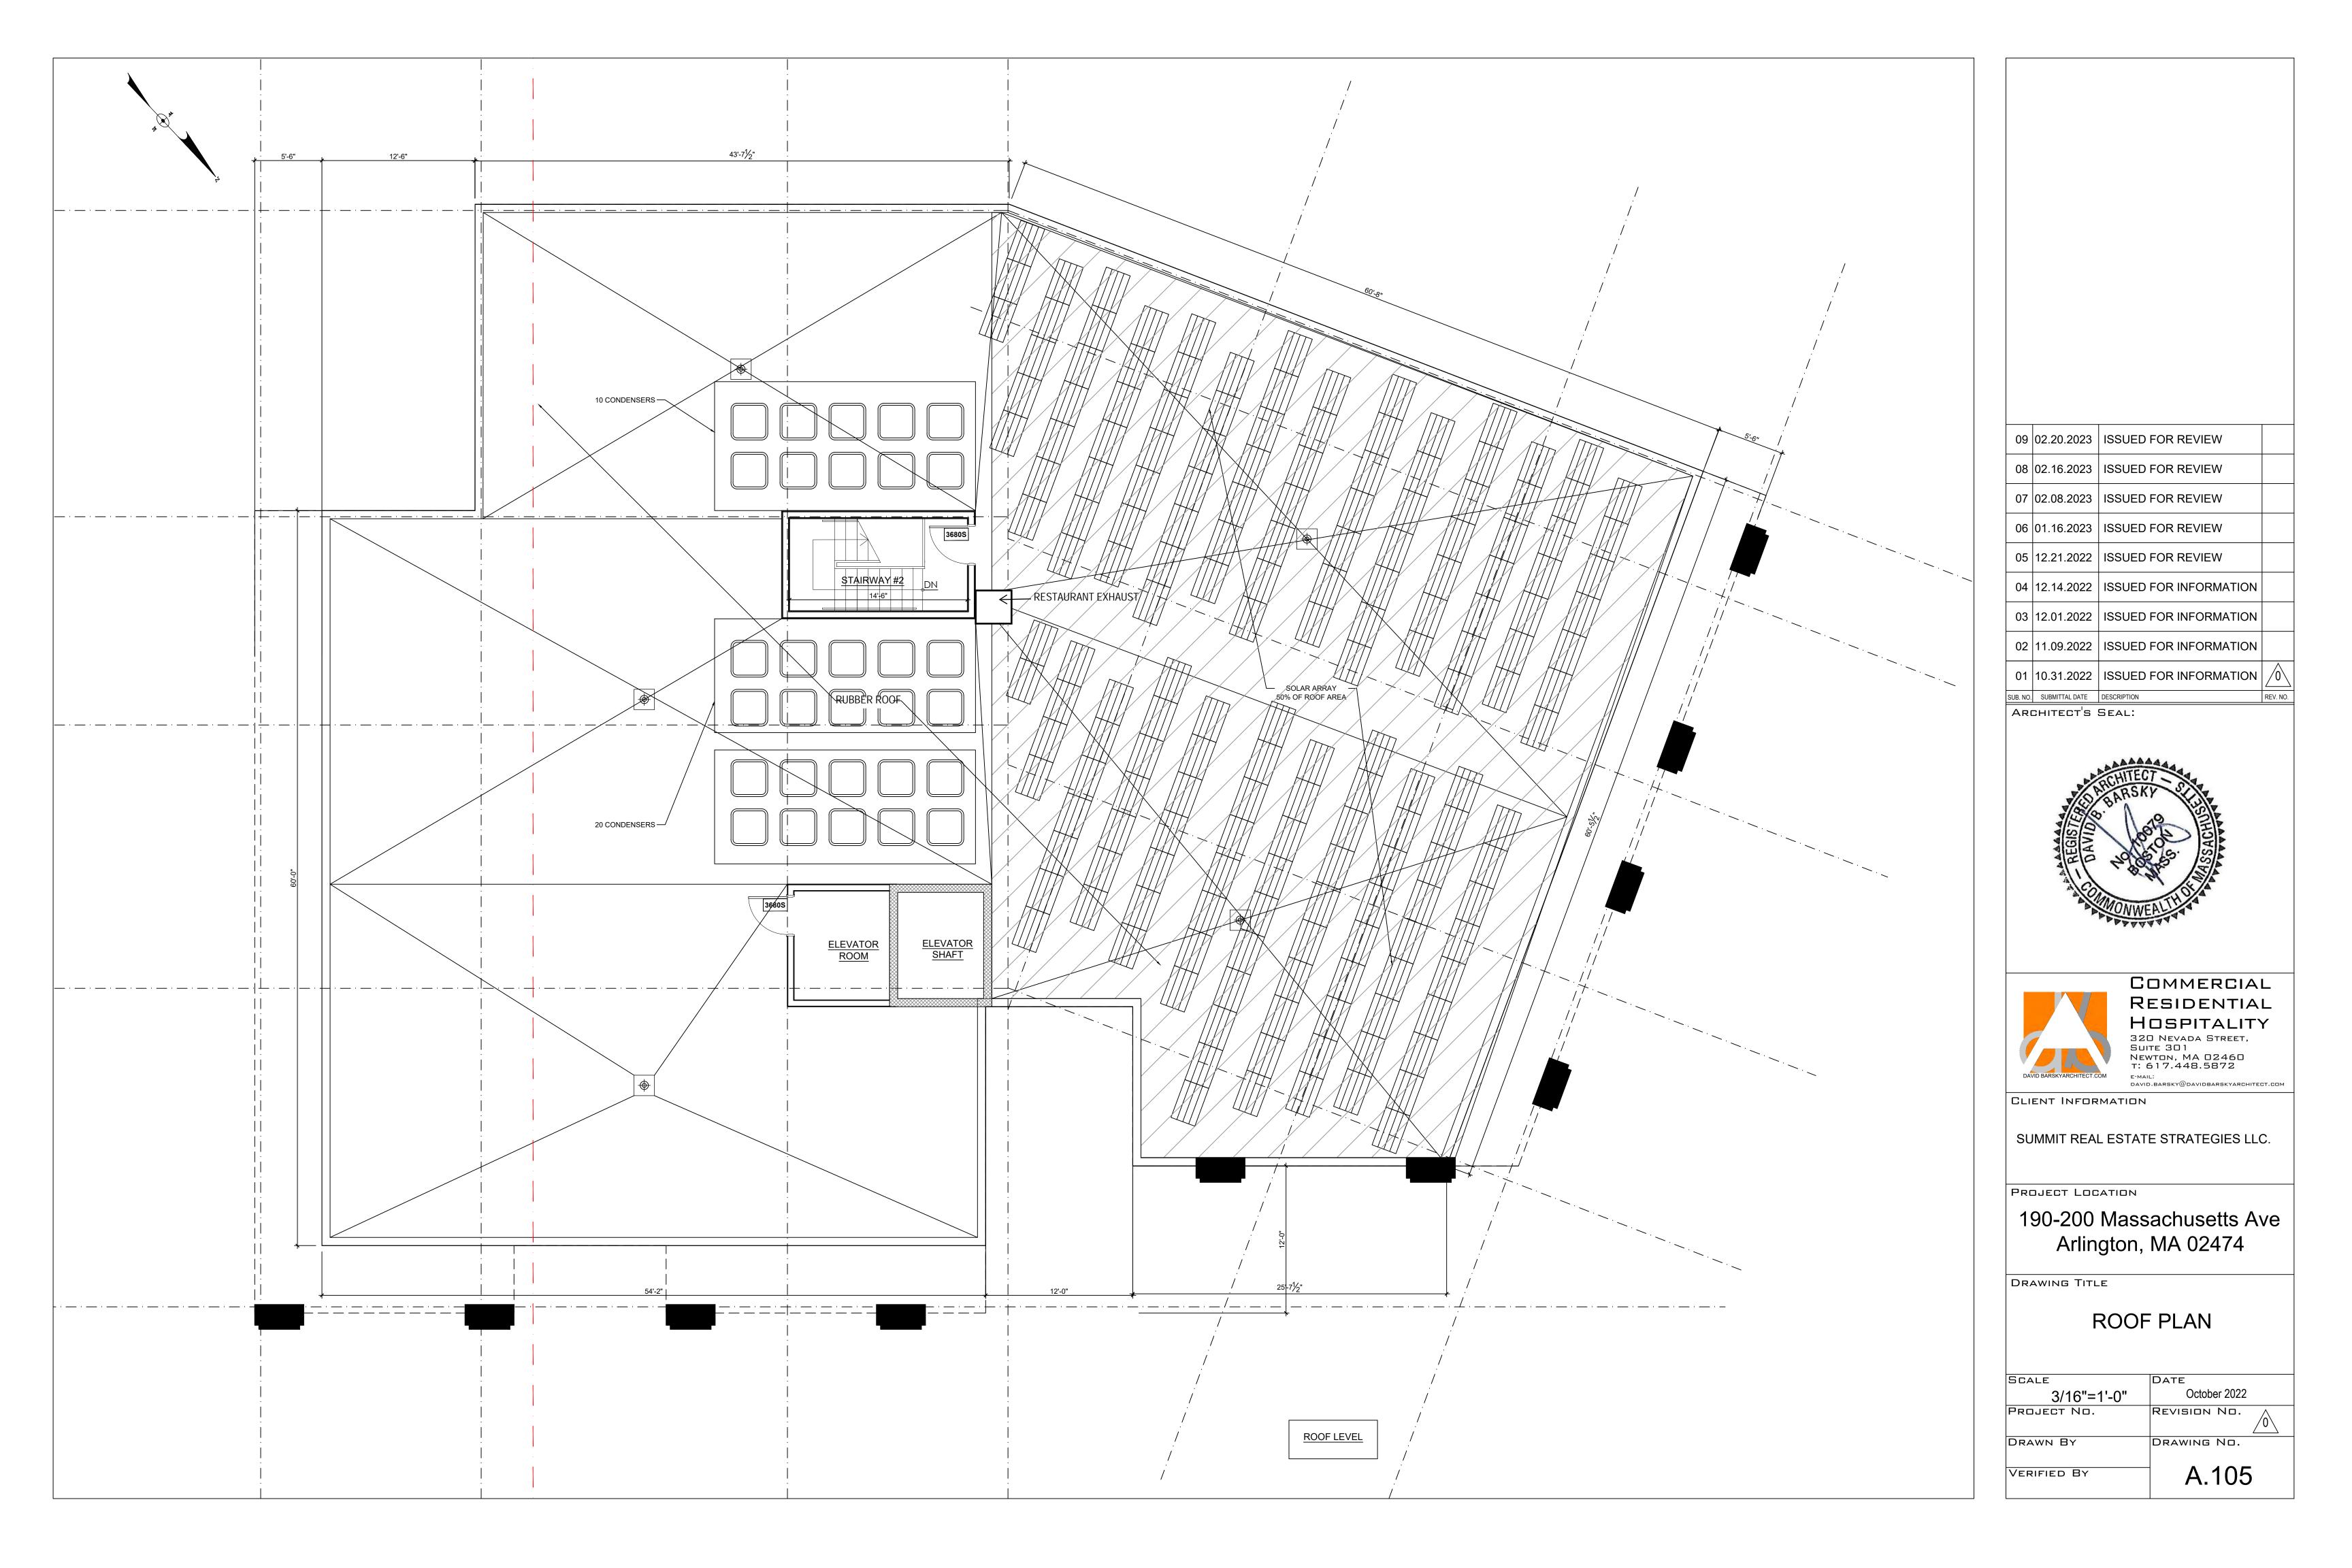



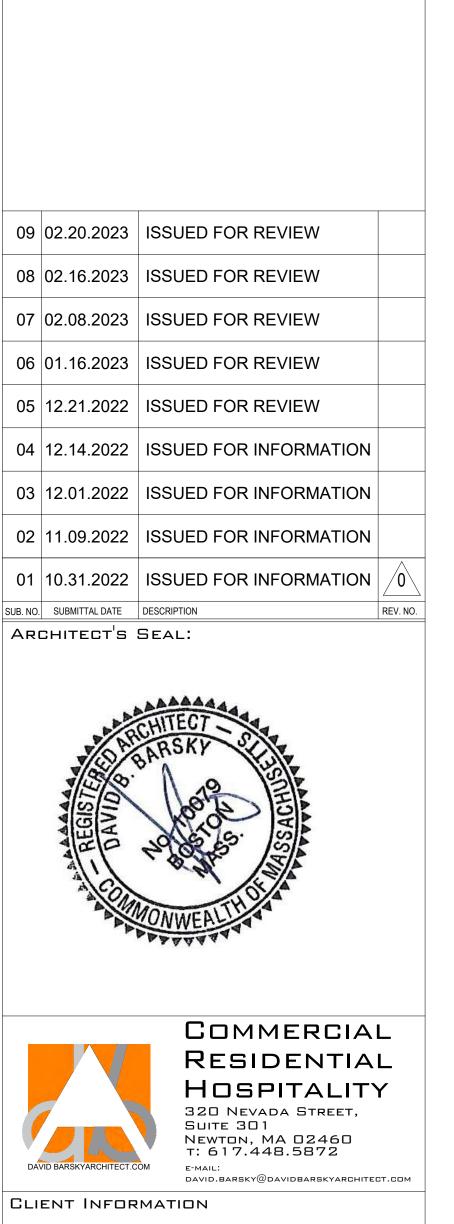

Arlington, MA 02474

ENLARGED

UNIT PLANS


October 2022


A-110

REVISION No.

DRAWING No.

1/4"=1'-0"

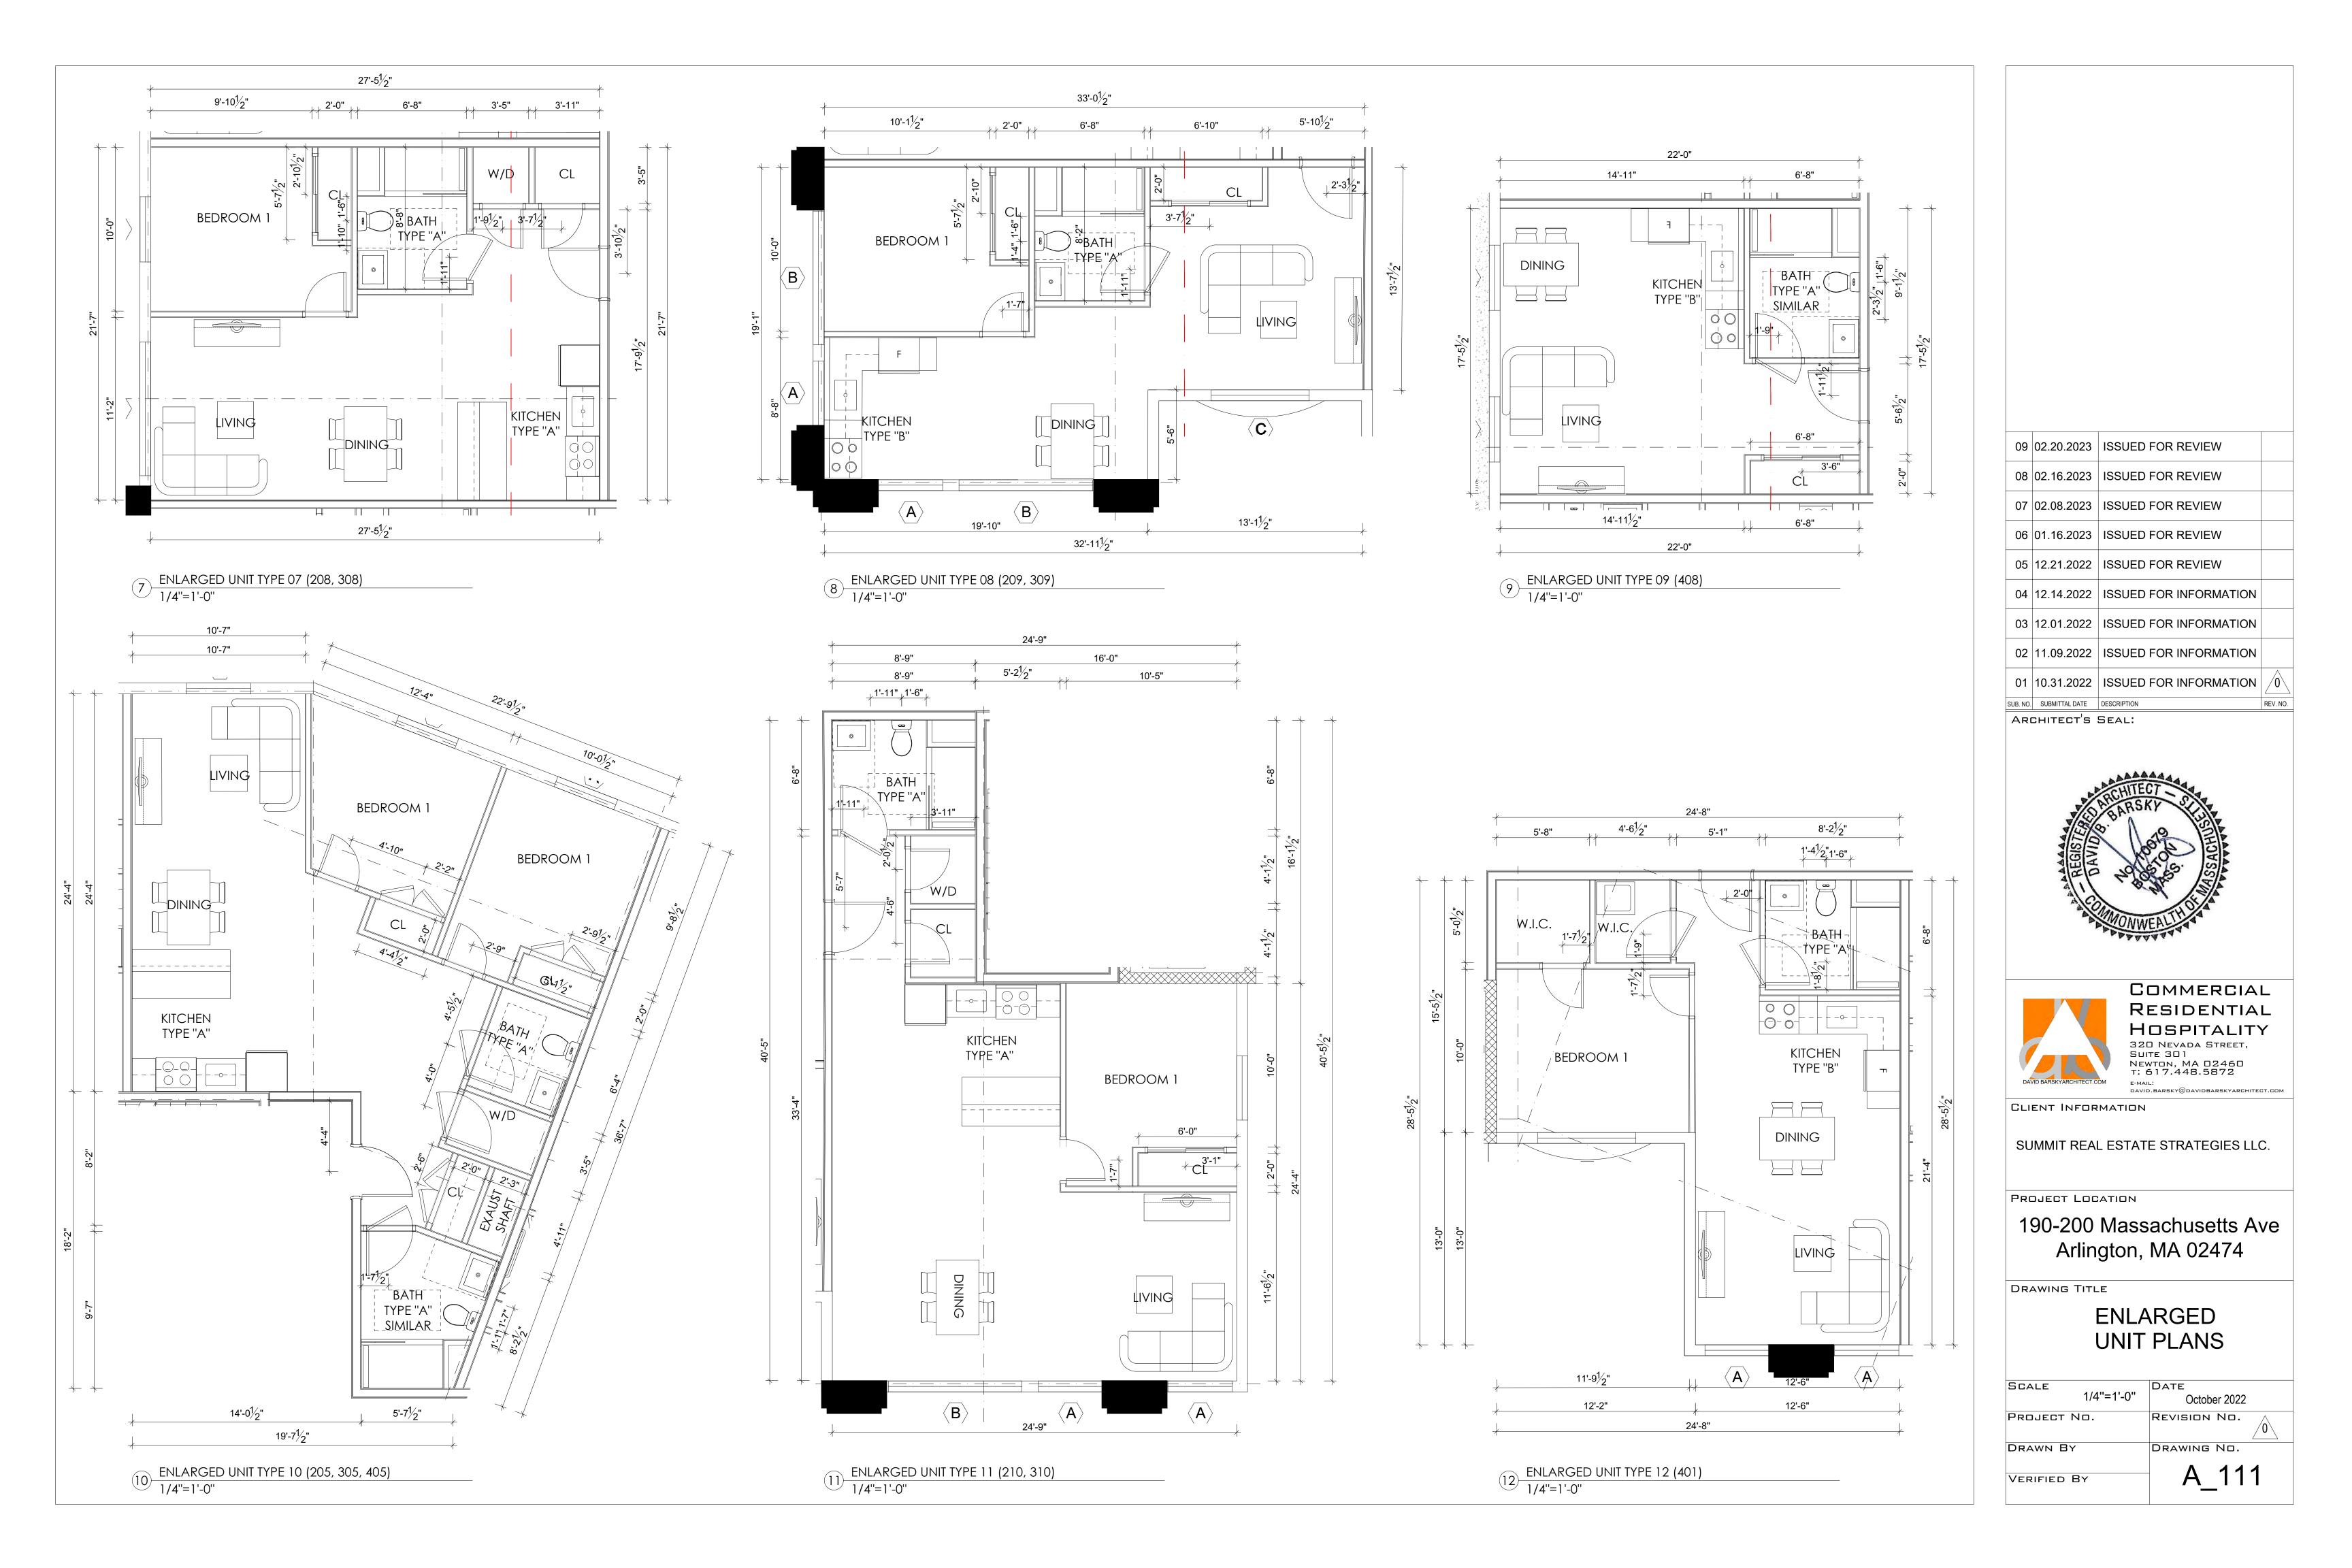

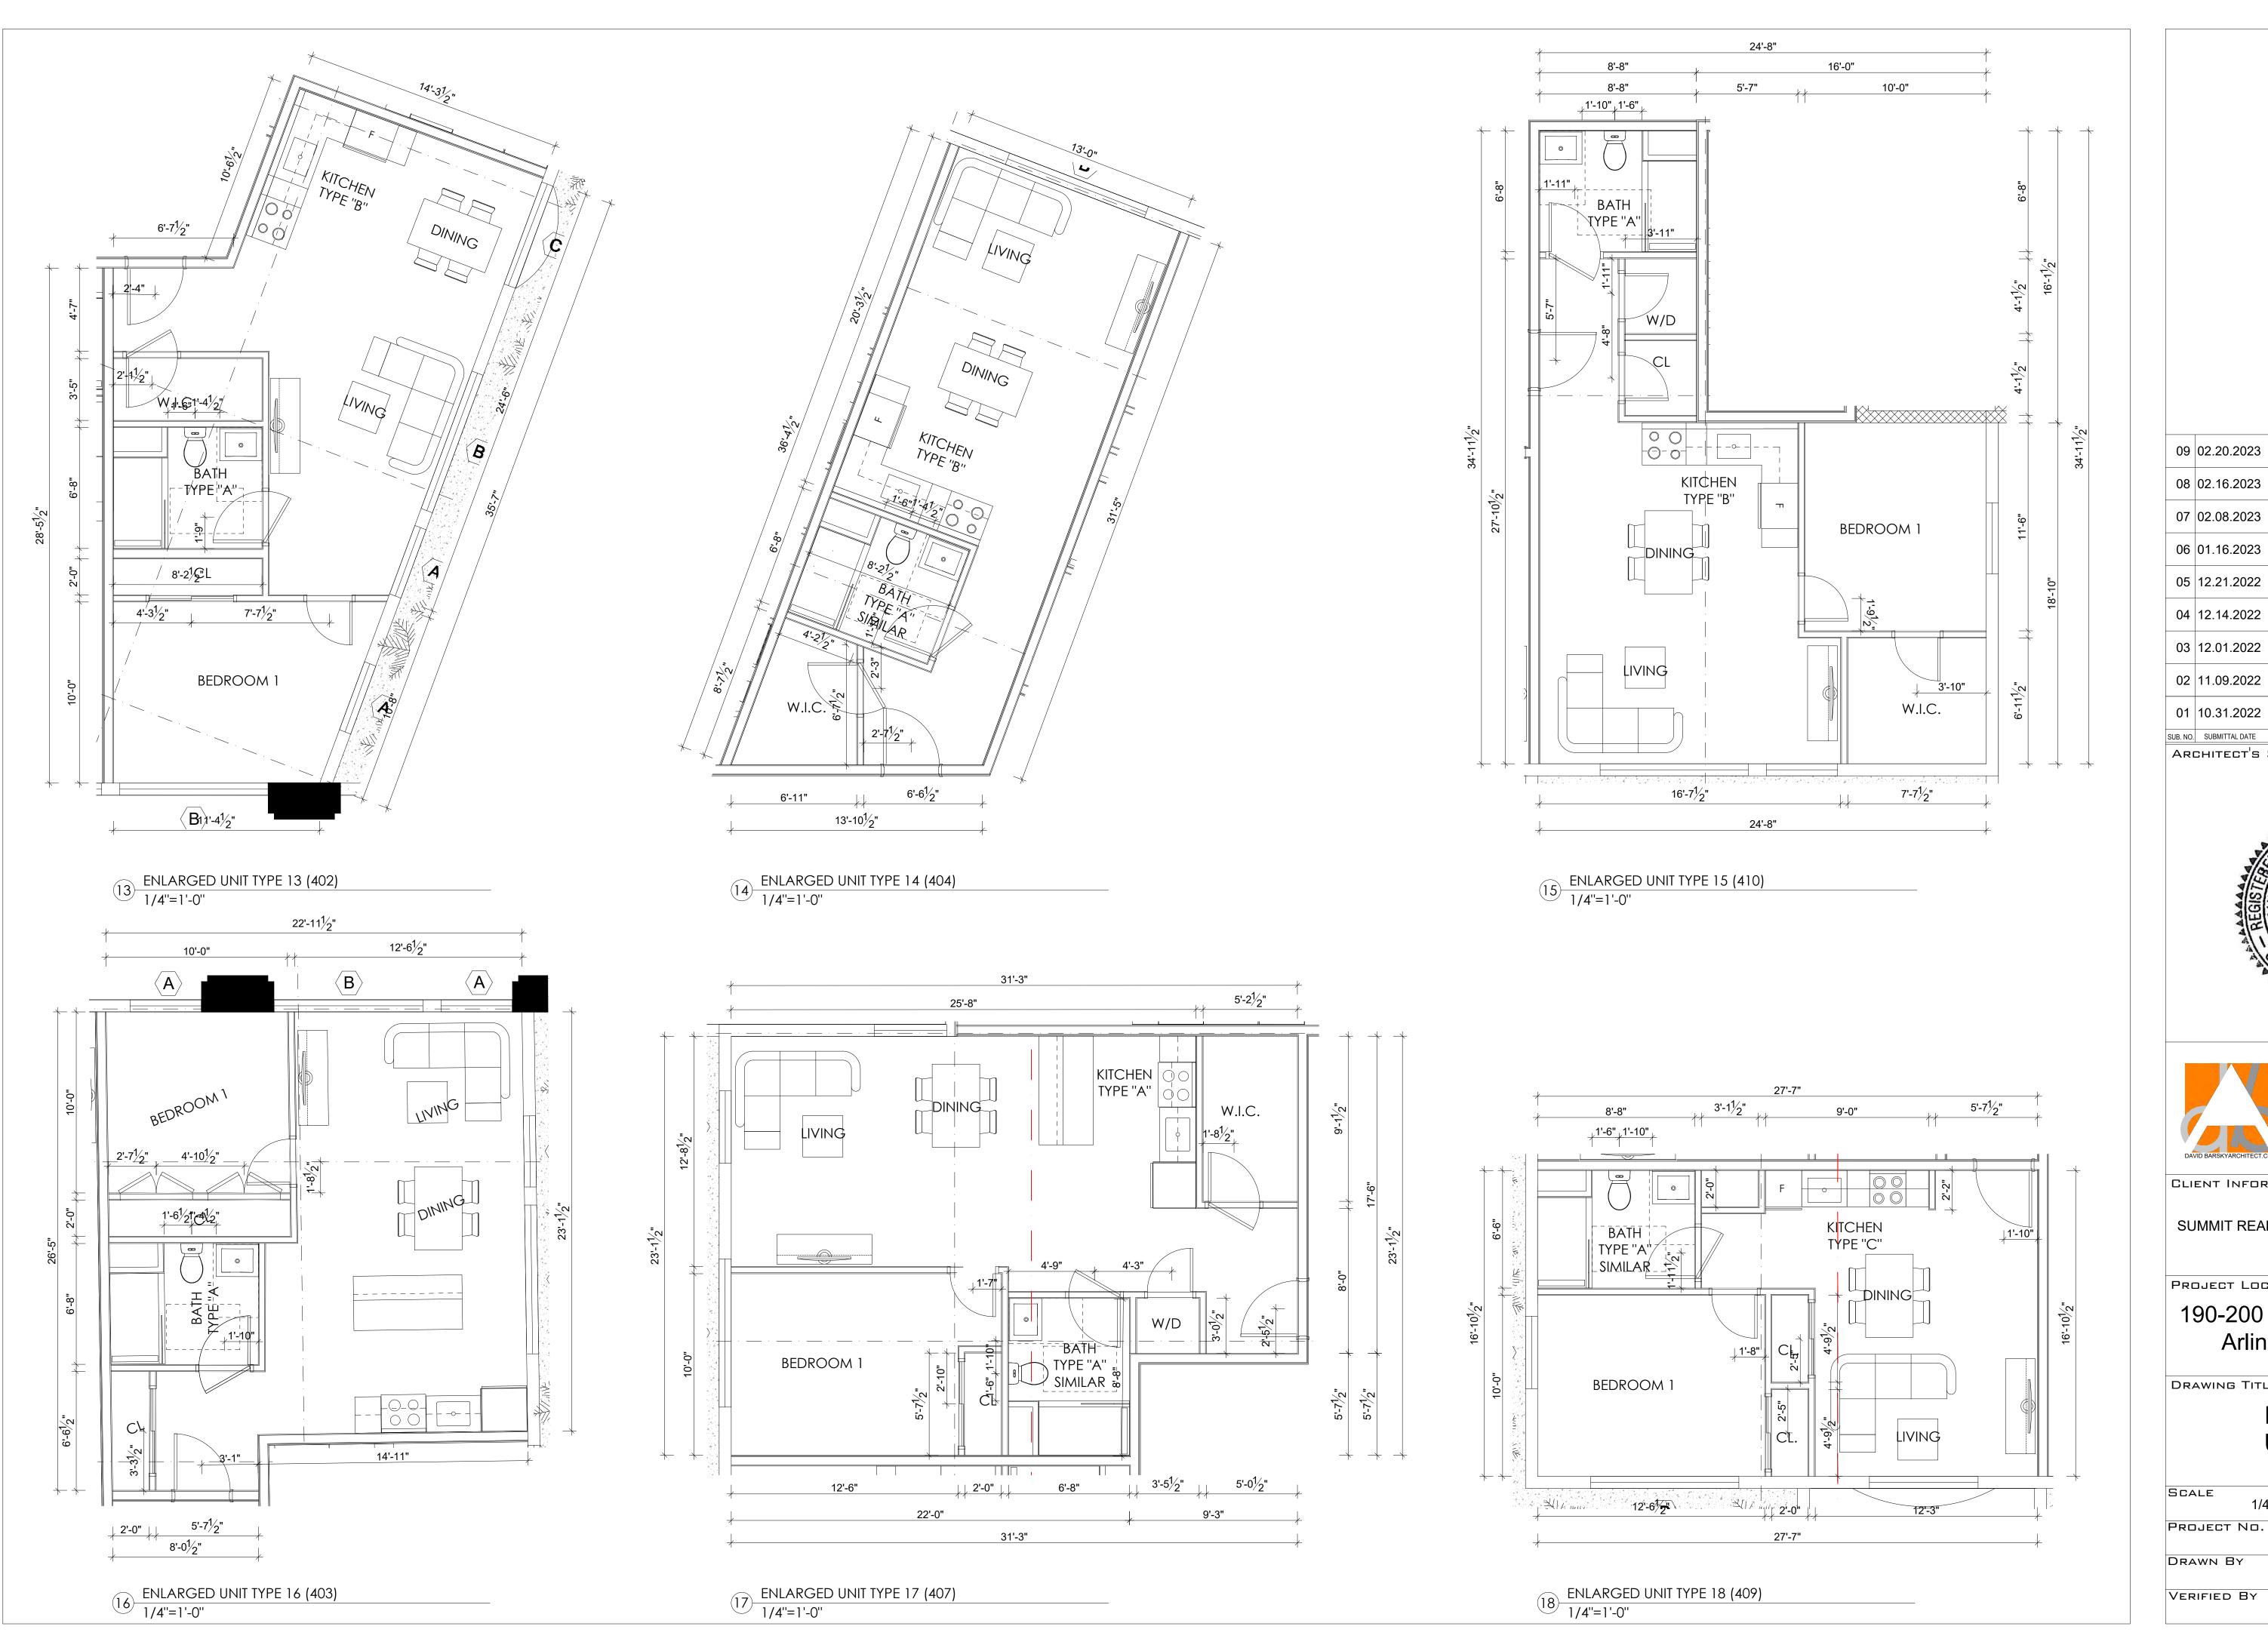



1/4"=1'-0"

October 2022

A-112

REVISION No.

DRAWING No.









09	02.20.2023	ISSUED FOR REVIEW	
80	02.16.2023	ISSUED FOR REVIEW	
07	02.08.2023	ISSUED FOR REVIEW	
06	01.16.2023	ISSUED FOR REVIEW	
05	12.21.2022	ISSUED FOR REVIEW	
04	12.14.2022	ISSUED FOR INFORMATION	
03	12.01.2022	ISSUED FOR INFORMATION	
02	11.09.2022	ISSUED FOR INFORMATION	
01	10.31.2022	ISSUED FOR INFORMATION	<u> </u>
B. NO.	SUBMITTAL DATE	DESCRIPTION	REV. NO.

ARCHITECT'S SEAL:





CLIENT INFORMATION

SUMMIT REAL ESTATE STRATEGIES LLC.

PROJECT LOCATION

190-200 Massachusetts Ave Arlington, MA 02474


DRAWING TITLE

ELEVATIONS

S	CALE	DATE
	3/16"=1'-0"	October 2022
P	ROJECT NO.	REVISION NO.
D	RAWN BY	DRAWING No.

VERIFIED BY

A-301

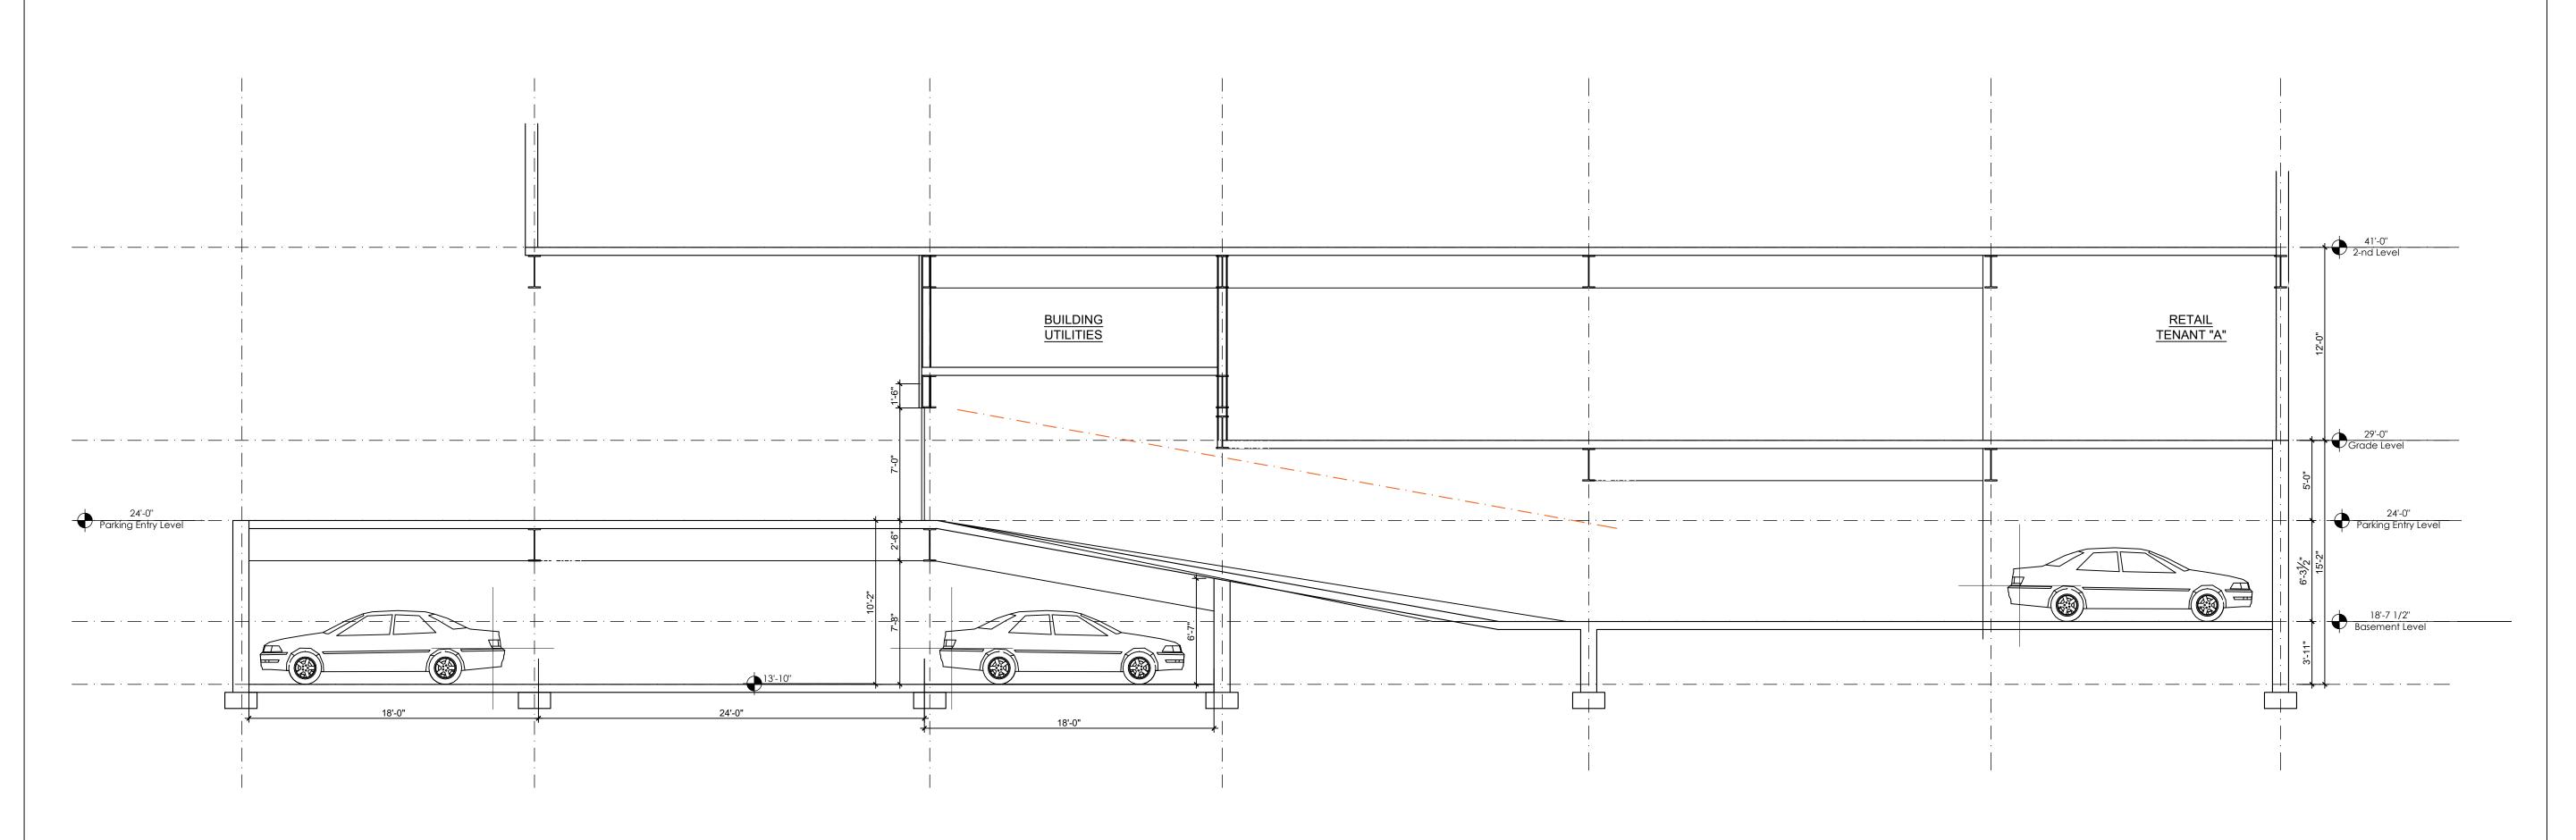

 09
 02.20.2023
 ISSUED FOR REVIEW

 08
 02.16.2023
 ISSUED FOR REVIEW

 07
 02.08.2023
 ISSUED FOR REVIEW

 06
 01.16.2023
 ISSUED FOR REVIEW

 05
 12.21.2022
 ISSUED FOR REVIEW

 04
 12.14.2022
 ISSUED FOR INFORMATION

 03
 12.01.2022
 ISSUED FOR INFORMATION

 02
 11.09.2022
 ISSUED FOR INFORMATION

 01
 10.31.2022
 ISSUED FOR INFORMATION

ARCHITECT'S SEAL:

SUB. NO. SUBMITTAL DATE DESCRIPTION





COMMERCIAL
RESIDENTIAL
HOSPITALITY
320 NEVADA STREET,
SUITE 301
NEWTON, MA 02460
T: 617.448.5872
E-MAIL:

CLIENT INFORMATION

SUMMIT REAL ESTATE STRATEGIES LLC.


PROJECT LOCATION


190-200 Massachusetts Ave Arlington, MA 02474

DRAWING TITLE

PARTIAL SECTION

SCALE	DATE
3/16"=1'-0"	October 2022
PROJECT NO.	REVISION NO.
DRAWN BY	DRAWING NO.
VERIFIED BY	A.400

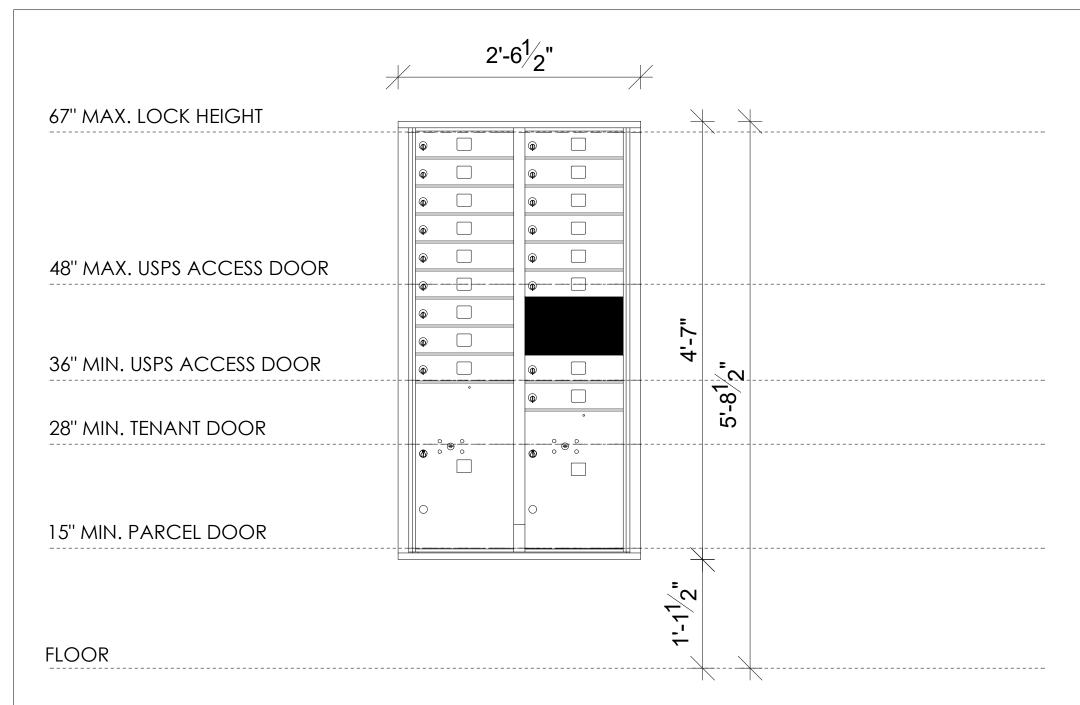

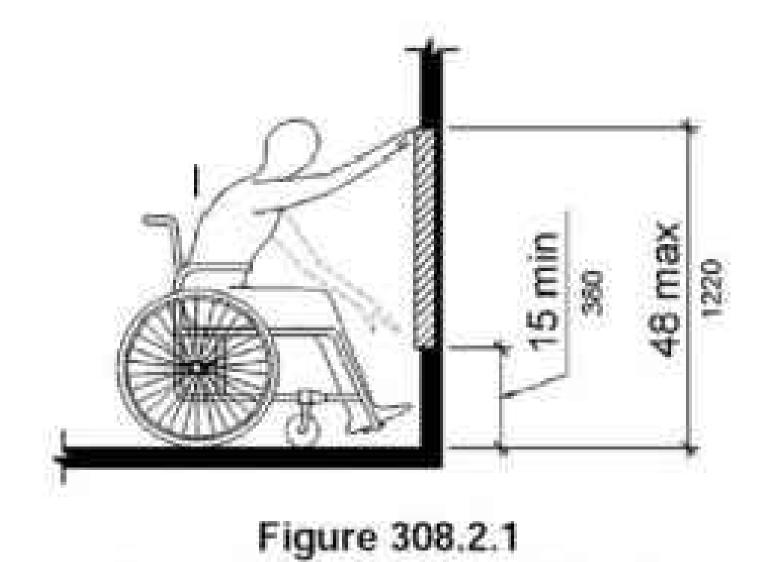


Unobstructed Forward Reach


10 max 255

1 MAILBOX TYPE A 4C15D-17(17 MB1)

Figure 308.3.1 Unobstructed Side Reach

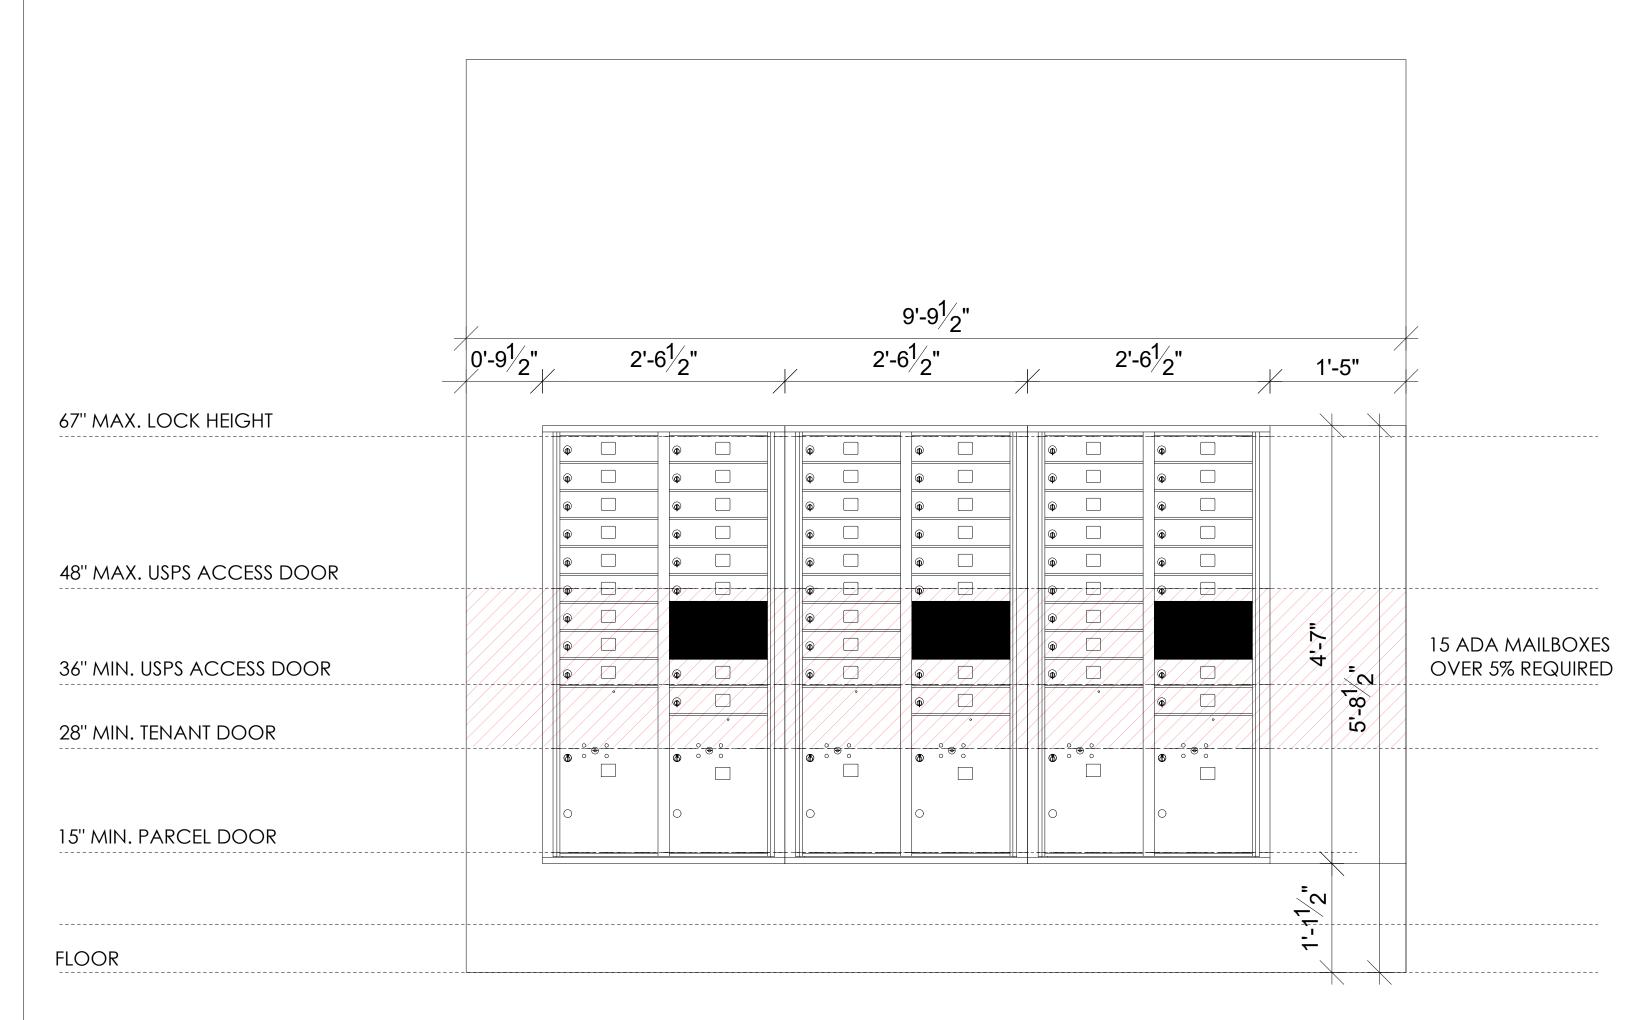



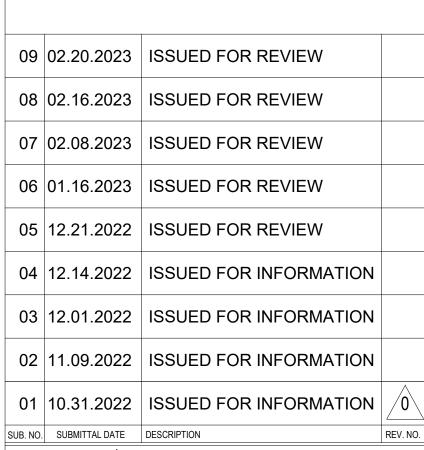

ARCHITECT'S SEAL:





CLIENT INFORMATION

SUMMIT REAL ESTATE STRATEGIES LLC.

PROJECT LOCATION

190-200 Massachusetts Ave Arlington, MA 02474

MAILBOX TYPES AND
MAILROOM ENLARGED
INTERIOR ELEVATION

1"=1'-0"	DATE October 2022
PROJECT No.	REVISION NO.
DRAWN BY	DRAWING NO.
VERIFIED BY	A.600



23.6 IN 36W Large Outdoor Lanterns For Porch Exterior Wall Lights SY-9046B

Home/Normal outdoor wall light (No Function), MAIN HOME LIGHT, Wall Light, Outdoor Wall Light/ 23.6 IN 36W Large Outdoor Lanterns For Porch Exterior Wall Lights SY-9046B

Porch Exterior Wall Lights SY-9046B

2/16/23, 3:50 PM

IP65 Waterproof large outdoor lanterns for porch exterior balcony Terrace. It is made of aluminum and double PC cover. Please feel free to get a quotation from Sytmhoe.

CDesigner LED Modern Exterior Wall Lights This LED modern wall sconce is designed in a simple and modern style that is very classic and elegant. A smooth, elongated frame with a black finish dominates the design and exudes a modern attitude perfect for indoor or outdoor spaces. Beautiful double pc shades stretch into a rectangular form, held n place by simple metal bars at each end for a picture-perfect finish, and have a more beautiful decorative effect. You can also remove the metal bars as you like when you install them.

Energy efficient Led Outdoor Wall light This Large Outdoor Wall Light is Made Of a Black die-cast aluminum outer box with a double PC cover(Transparent+milky white). This LED chip high bright wall light is energy efficient, LED 36W low consumption, but it can replace 200W candescent, which can save energy bills in its long lifespan.LED lamp eads can replace traditional incandescent lamps that need to be eplaced frequently, providing you with more convenient outdoor

Size:23.62in*4.92*3.07in,Watts: LED 36w,Input Voltage:AC 85-265V,Temp:3200k or 6500k,Frequency:50HZ,Light source: 108*LED chips with 3480LM illumination, Low power consumption and energy saving. The average lifespan of 50000 hours.

Waterproof.Adopt US Standard Bracket design, electric Hard-wired with wall lamp bracket, Contains all installed accessories and installation instructions. Follow the instruction, you can install it easily on your own. Best for courtyards, balconies, bedrooms, exhibition courtyards, bedrooms, exhibition halls, restaurants, cafes, squares, corridors, stairs, hotels, etc. Outdoor Garage Lights Wall Mount 30W Led Modern Outdoor

based in the USA and offers high-quality products at affordable prices, feel free to contact cy@sytmhoeled.com if you have any questions with our light, and we will deal for you the first time.


Ship From **United States**

Brand: Sytmhoe

Description

Additional information

13 × 6 × 6 in United States, China

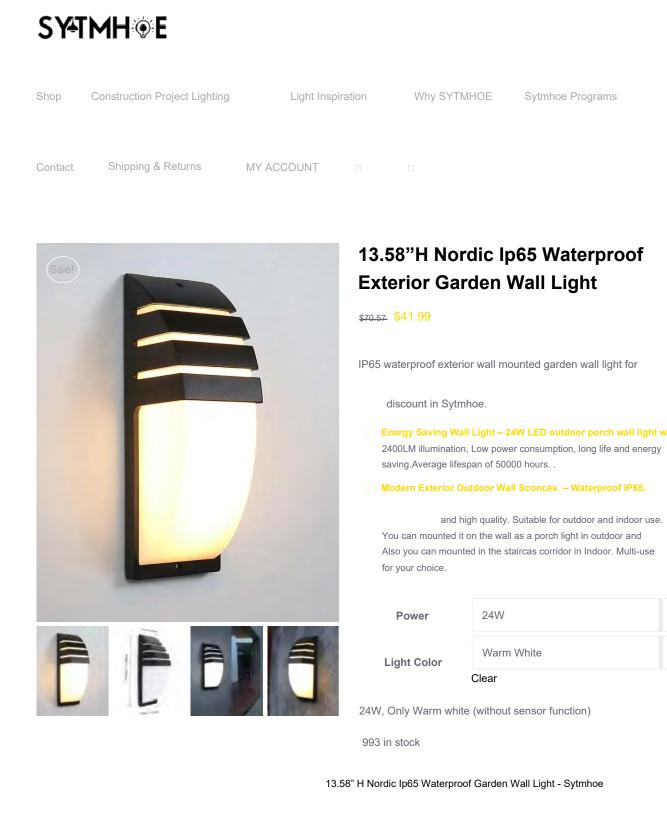



13.58" H Nordic Ip65 Waterproof Garden Wall Light - Sytmhoe

VAUGHAN, ON L4K 5W9
PHONE: (416) 927-7499
FAX: (416) 927-7499

BIKE RACK MFG. & DIST. CO. 80 BASS PRO MILLS DR., UNIT 24 VAUGHAN, ON L4K 5W9

LUMENS

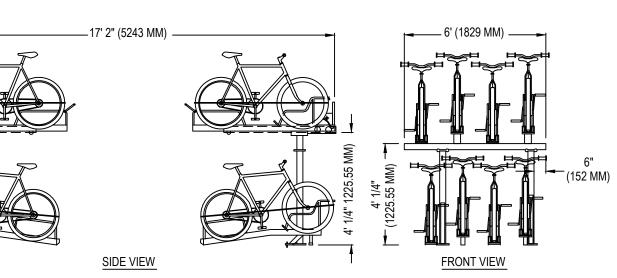

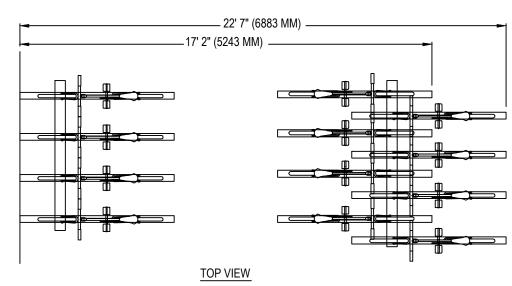

FEATURES: -MATERIAL: HSS STEEL

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- 4. ALL INFORMATION CONTAINED HEREIN WAS CURRENT AT THE TIME OF DEVELOPMENT BUT MUST BE REVIEWED AND APPROVED BY
- 5. CONTRACTOR'S NOTE: FOR PRODUCT AND COMPANY INFORMATION VISIT www.CADdetails.com/info AND ENTER REFERENCE NUMBER 4238-015.

REVISION DATE 03/06/2015

OUTDOOR WALL SCONCE S2


INDOOR BIKE

STORAGE RACKS



Prepared

Placement:

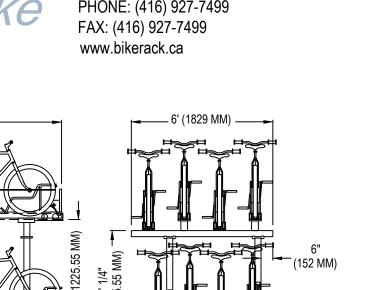

-FINISH: HOT DIPPED GALVANIZED

1. INSTALLATION TO BE COMPLETED IN ACCORDANCE WITH MANUFACTURER'S SPECIFICATIONS.

- THE PRODUCT MANUFACTURER TO BE CONSIDERED ACCURATE.

STACKABLE BIKE RACKS TRIPLE STACKABLE BIKE RACK, 18" CENTER TO CENTER

CADdetails.com

09 02.20.2023 | ISSUED FOR REVIEW 08 | 02.16.2023 | ISSUED FOR REVIEW 07 | 02.08.2023 | ISSUED FOR REVIEW 06 | 01.16.2023 | ISSUED FOR REVIEW 05 | 12.21.2022 | ISSUED FOR REVIEW 04 | 12.14.2022 | ISSUED FOR INFORMATION 03 | 12.01.2022 | ISSUED FOR INFORMATION | 02 11.09.2022 ISSUED FOR INFORMATION 01 10.31.2022 ISSUED FOR INFORMATION SUB. NO. SUBMITTAL DATE DESCRIPTION ARCHITECT'S SEAL:





NEWTON, MA 02460 T: 617.448.5872 david.barsky@davidbarskyarchitect.com

CLIENT INFORMATION

SUMMIT REAL ESTATE STRATEGIES LLC.

PROJECT LOCATION

190-200 Massachusetts Ave Arlington, MA 02474

DRAWING TITLE

VERIFIED BY

BIKE RACKS/LIGHTING

SCALE October 2022 PROJECT NO. REVISION No. DRAWN BY DRAWING NO.

B.01

Energy Saving Wall Light – 24W LED outdoor porch wall light wit 2400LM illumination, Low power consumption, long life and energy

Additional Details

Rating: UL Listed Damp

ITEM#: KCH2190685

Outdoor Up/Down Cylinder Wall Sconce

12 inches Option Backplate: Width 4.5", Height 4.88"

Incandescent

2 (Not Included)

65W BR30 E26

2700 (Warm)

https://www.lumens.com/outdoor-up-down-cylinder-wal

1260.0

12 inches Option Fixture: Width 4.75", Height 12",

By Kichler

Product Options

Finish: Black, Size: 12 inches

Details

Dimensions

Lighting

12 inches

Outdoor Up/Down Cylinder Wall Sconce

Up and down light

Depth 7", Weight 1.95Lbs

Lamp Type

Total Lumens

of Bulbs

Bulb Type

Color Temp

Average

Lifespan (Hours)

Halogen, CFL or

l-sconce-by-kichler-KCH2190685.html

LED Bulb Can


Be Used

Volts

Light Color Temperature: 3000K-Warm White

OUTDOOR WALL SCONCE S1

OUTDOOR WALL SCONCE S3

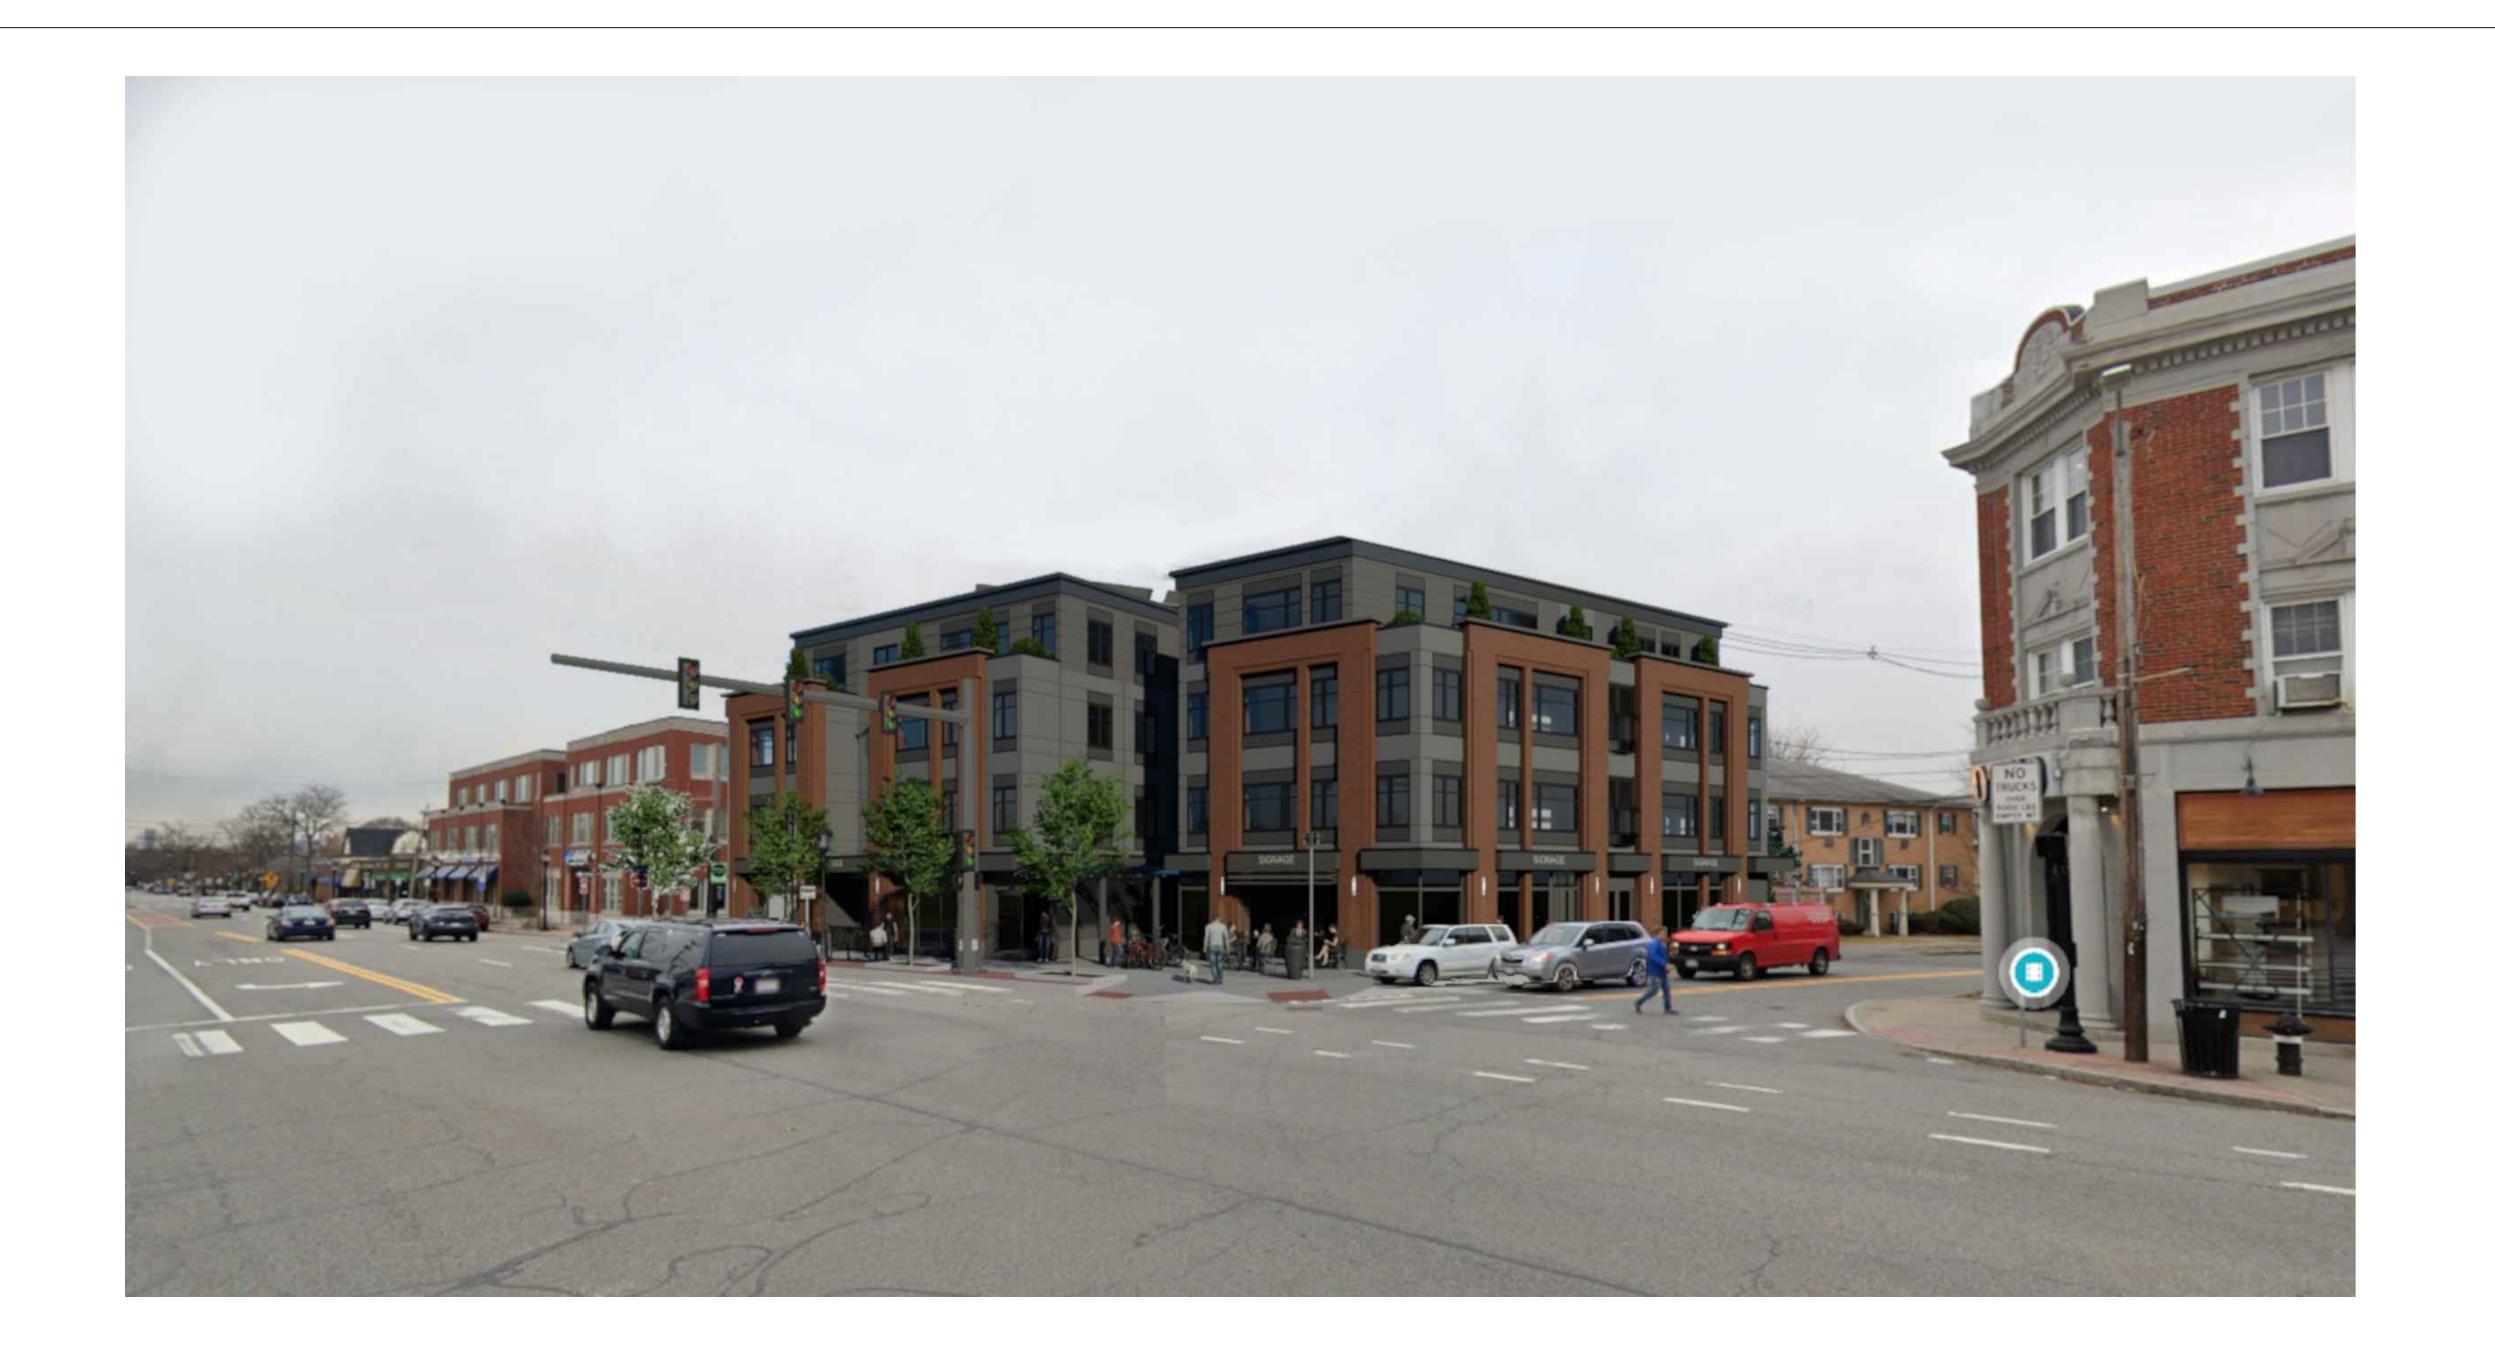



09	02.20.2023	ISSUED FOR REVIEW	
08	02.16.2023	ISSUED FOR REVIEW	
07	02.08.2023	ISSUED FOR REVIEW	
06	01.16.2023	ISSUED FOR REVIEW	
05	12.21.2022	ISSUED FOR REVIEW	
04	12.14.2022	ISSUED FOR INFORMATION	
03	12.01.2022	ISSUED FOR INFORMATION	
02	11.09.2022	ISSUED FOR INFORMATION	
01	10.31.2022	ISSUED FOR INFORMATION	0
SUB. NO.	SUBMITTAL DATE	DESCRIPTION	REV. NO.
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ARCHITECT[']S SEAL





COMMERCIAL
RESIDENTIAL
HOSPITALITY
320 NEVADA STREET,
SUITE 301
NEWTON, MA 02460
T: 617.448.5872

CLIENT INFORMATION

SUMMIT REAL ESTATE STRATEGIES LLC.

PROJECT LOCATION

190-200 Massachusetts Ave Arlington, MA 02474

DRAWING TITLE

VISUALIZATION

SCALE	NTS	DATE
	1113	October 2022
PROJECT	No.	REVISION NO.
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VERIFIED	BY	→ AV1





08	02.16.2023	ISSUED FOR REVIEW	
07	02.08.2023	ISSUED FOR REVIEW	
06	01.16.2023	ISSUED FOR REVIEW	
05	12.21.2022	ISSUED FOR REVIEW	
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02	11.09.2022	ISSUED FOR INFORMATION	
01	10.31.2022	ISSUED FOR INFORMATION	<u></u>
SUB. NO.	SUBMITTAL DATE	DESCRIPTION	REV. NO.
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COMMERCIAL RESIDENTIAL HOSPITALITY
320 NEVADA STREET,
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NEWTON, MA 02460
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CLIENT INFORMATION


SUMMIT REAL ESTATE STRATEGIES LLC.

PROJECT LOCATION

190-200 Massachusetts Ave Arlington, MA 02474


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VISUALIZATION

SCALE N	ITS	October 2022	
PROJECT NO	J.	REVISION NO.	<u></u>
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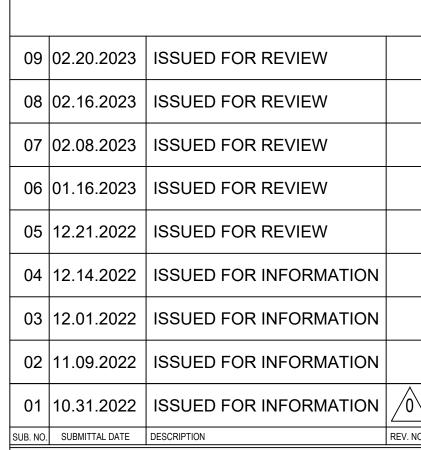


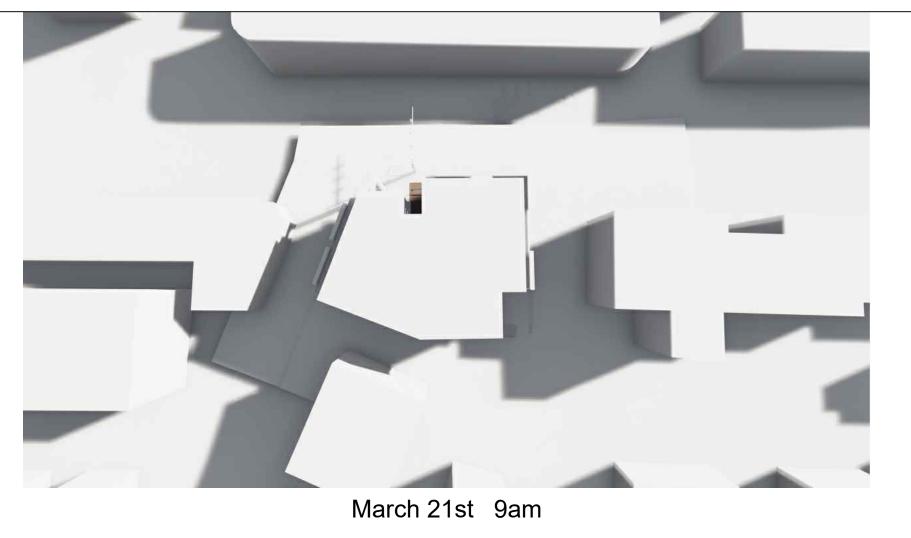





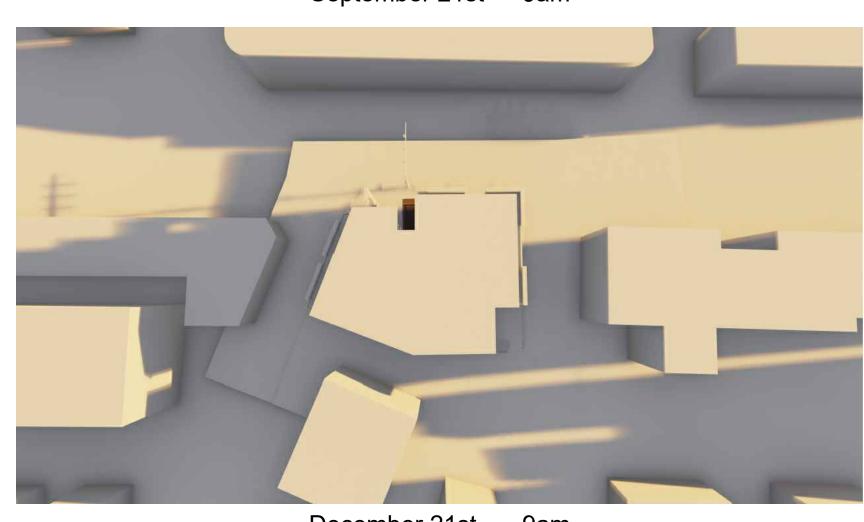



ARCHITECT'S SEAL:





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CLIENT INFORMATION

SUMMIT REAL ESTATE STRATEGIES LLC.

PROJECT LOCATION

190-200 Massachusetts Ave Arlington, MA 02474

DRAWING TITLE

SHADOW STUDY

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	SCALE	NTO	DATE	
		NTS	October 2	2022
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